

108-110 RITCHIE LLC P.O. BOX 14001-174 KETCHUM, ID 83340 TEL: 603.801.0419

BUILDING ARCHITECT:

RO | ROCKETT DESIGN 1031 W. MANCHESTER BLVD. UNIT 6 INGLEWOOD, CA 90301 TEL: 213.784.0014

STRUCTURAL ENGINEER:

ZFA STRUCTURAL ENGINEERS 601 MONTGOMERY STREET SUITE 1450 SAN FRANCISCO, CA 94111 TEL: 415.243.4091

MECHANICAL, ELECTRICAL, PLUMBING ENGINEER:

PROFICIENT ENGINEERING 4704 HARLAN STREET SUITE 620 DENVER, CO 80212 TEL: 720.779.3556

CIVIL ENGINEER:

GALENA BENCHMARK ASSOCIATES 100 BELL DRIVE SUITE C KETCHUM, ID 83340 TEL: 208.726.9512

LANDSCAPE ARCHITECT:

EGGERS ASSOCIATES 560 NORTH 2ND AVENUE KETCHUM, ID 83340 TEL: 208.725.0988

WARM SPRINGS TOWNHOMES

DESIGN REVIEW APPLICATION / SEPTEMBER 09, 2025

<u>DESCRIPTION</u>
3-4 STORY MULTI-FAMILY RESIDENCE WITH 12 UNITS (4 BUILDINGS) WITH 23 INTERIOR, PRIVATE GARAGE PARKING SPACES. SCOPE OF WORK INCLUDES NEW CONSTRUCTION OF FOUNDATION, ERECTION OF STRUCTURE, CIVIL, LANDSCAPING, HARDSCAPING AND FINISHES.

PROJECT ADDRESS 108 / 110 RITCHIE DRIVE KETCHUM, ID 83340

APPLICABLE CODES
ALL CONSTRUCTION SHALL COMPLY WITH: 2018 INTERNATIONAL BUILDING CODE*

2018 INTERNATIONAL RESIDENTIAL CODE* 2018 INTERNATIONAL FIRE CODE WITH LOCAL AMENDMENTS* 2018 INTERNATIONAL ENERGY CONSERVATION CODE*
2018 INTERNATIONAL SWIMMING POOL AND SPA CODE

2018 INTERNATIONAL EXISTING BUILDING CODE

2018 INTERNATIONAL PROPERTY MAINTENANCE CODE TITLE 15 KETCHUM MUNICIPAL CODE APPENDIX M OF THE IBC AS AMENDED BY THE CITY OF KETCHUM

ALL APPLICABLE COUNTY ORDINANCES

JURISDICTIONAL AGENCY SHALL BE THE KETCHUM BUILDING DEPARTMENT.

CONTRACTOR SHALL KEEP A COPY OF THE ABOVE CODE SECTIONS ON THE JOB SITE AT ALL TIMES.

*AS AMENDED BY THE IDAHO BUILDING CODE BOARD AND INCLUDING NOTED APPENDICES.

CLIMATE ZONE:

PROJECT DATA LOT AREA: ZONING DESIGNATION: OCCUPANCY: CONSTRUCTION TYPE:

T-3000 (TOURIST ZONE) MULTI-FAMILY (PRIVATÉ CONDOS) TYPE V

1. THE CONTRACTOR SHALL BE RESPONSIBLE FOR ALL DRAWINGS, CALCULATIONS, GOVERNMENTAL AGENCY APPROVALS AND FEES TO COMPLETE THIS WORK. CONTRACTOR/SUBCONTRACTORS SHALL SUBMIT MECHANICAL, ELECTRICAL, COMMUNICATIONS AND PLUMBING DRAWINGS TO ROCKETT DESIGN FOR PREVIEW OF DEVICE TYPES, LOCATIONS AND QUANTITIES, HVAC ZONING/THERMOSTAT LOCATIONS, ETC. PRIOR TO SUBMITTING FOR PERMIT AND CONSTRUCTION.

2. THESE DOCUMENTS ARE INTENDED TO INCLUDE ALL LABOR, MATERIALS, EQUIPMENT AND SERVICES REQUIRED TO COMPLETE ALL WORK DESCRIBED HEREIN. IT IS THE RESPONSIBILITY OF THE CONTRACTOR TO BRING TO THE ATTENTION OF THE ARCHITECT ANY CONDITIONS WHICH WILL NOT PERMIT CONSTRUCTION ACCORDING TO THE INTENTIONS OF THESE DOCUMENTS. IT IS THE RESPONSIBILITY OF THE ARCHITECT TO PROVIDE DETAILS AND/OR DIRECTIONS REGARDING DESIGN INTENT WHERE IT IS ALTERED BY EXISTING CONDITIONS OR WHERE NEGLECTED IN THE DOCUMENTS.


3. ANY MATERIALS PROPOSED FOR SUBSTITUTION OF THOSE SPECIFIED, OR CALLED OUT BY TRADE NAME, IN THESE DOCUMENTS SHALL BE PRESENTED TO THE ARCHITECT FOR REVIEW. THE CONTRACTOR SHALL SUBMIT SAMPLES WHEN REQUIRED BY THE ARCHITECT, AND ALL SUCH SAMPLES SHALL BE REVIEWED BY THE ARCHITECT BEFORE THE WORK IS PERFORMED. WORK MUST CONFORM TO THE REVIEWED SAMPLES. ANY WORK WHICH DOES NOT CONFORM SHALL BE REMOVED AND REPLACE WITH WORK WHICH CONFORMS AT THE CONTRACTOR'S EXPENSE. SUBCONTRACTORS SHALL SUBMIT REQUESTS AND SAMPLES FOR REVIEW THROUGH THE GENERAL CONTRACTOR WHEN WORK IS LET THROUGH HIM OR HER. REQUIRED VERIFICATIONS AND SUBMITTALS TO BE MADE IN ADEQUATE TIME AS NOT TO DELAY WORK IN PROGRESS.

4. SHOP DRAWINGS SHALL BE SUBMITTED TO THE ARCHITECT FOR HIS OR HER REVIEW WHERE CALLED FOR ANYWHERE IN THESE DOCUMENTS. REVIEW SHALL BE MADE BY THE ARCHITECT BEFORE WORK IS BEGUN, AND WORK SHALL CONFORM TO THE REVIEWED SHOP DRAWINGS, SUBJECT TO REPLACEMENT AS REQUIRED IN PARAGRAPH "E" ABOVE.

5. DO NOT SCALE DRAWINGS. CONTRACTOR SHALL VERIFY ALL DIMENSIONAL DISCREPANCIES WITH

6. CONTRACTOR SHALL VERIFY AND COORDINATE ALL OPENINGS THROUGH FLOORS, CEILINGS, AND WALLS WITH ALL ARCHITECTURAL, STRUCTURAL, MECHANICAL, PLUMBING AND ELECTRICAL

7. CONTRACTOR WILL ASSUME RESPONSIBILITY OF ITEMS REQUIRING COORDINATION AND RESOLUTION DURING THE BIDDING PROCESS. 8. BUILDING TO BE FULLY SPRINKLERED PER NFPA 13D. CONTRACTOR TO PROVIDE FIRE SPRINKLER SYSTEM DESIGN AND SHOP DRAWINGS TO COMFORM TO THESE STANDARDS.

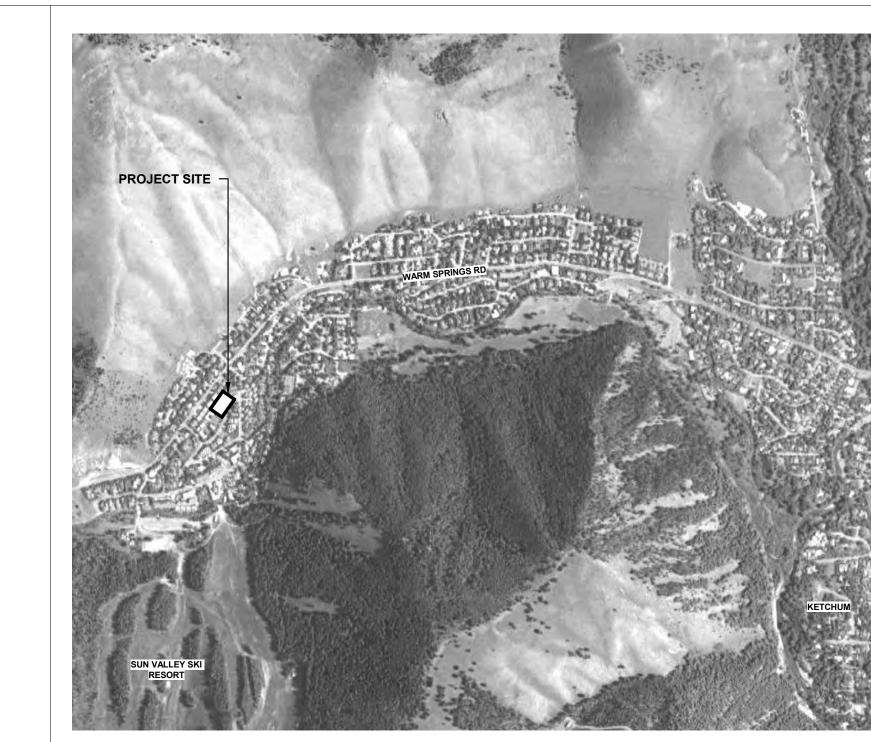

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DESCRIPTION

DESIGN REVIEW APPLICATION 25.09.09

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WARM SPRINGS TOWNHOMES KETCHUM, ID

108 & 110 RITCHIE DR. KETCHUM, IDAHO


DRAWING TITLE:

COVER SHEET

PROJECT NUMBER

DRAWING NUMBER:

PROJECT DESCRIPTION NTS **PROJECT NOTES** PROJECT LOCATION ©2025, RO | ROCKETT DESIGN, INC.

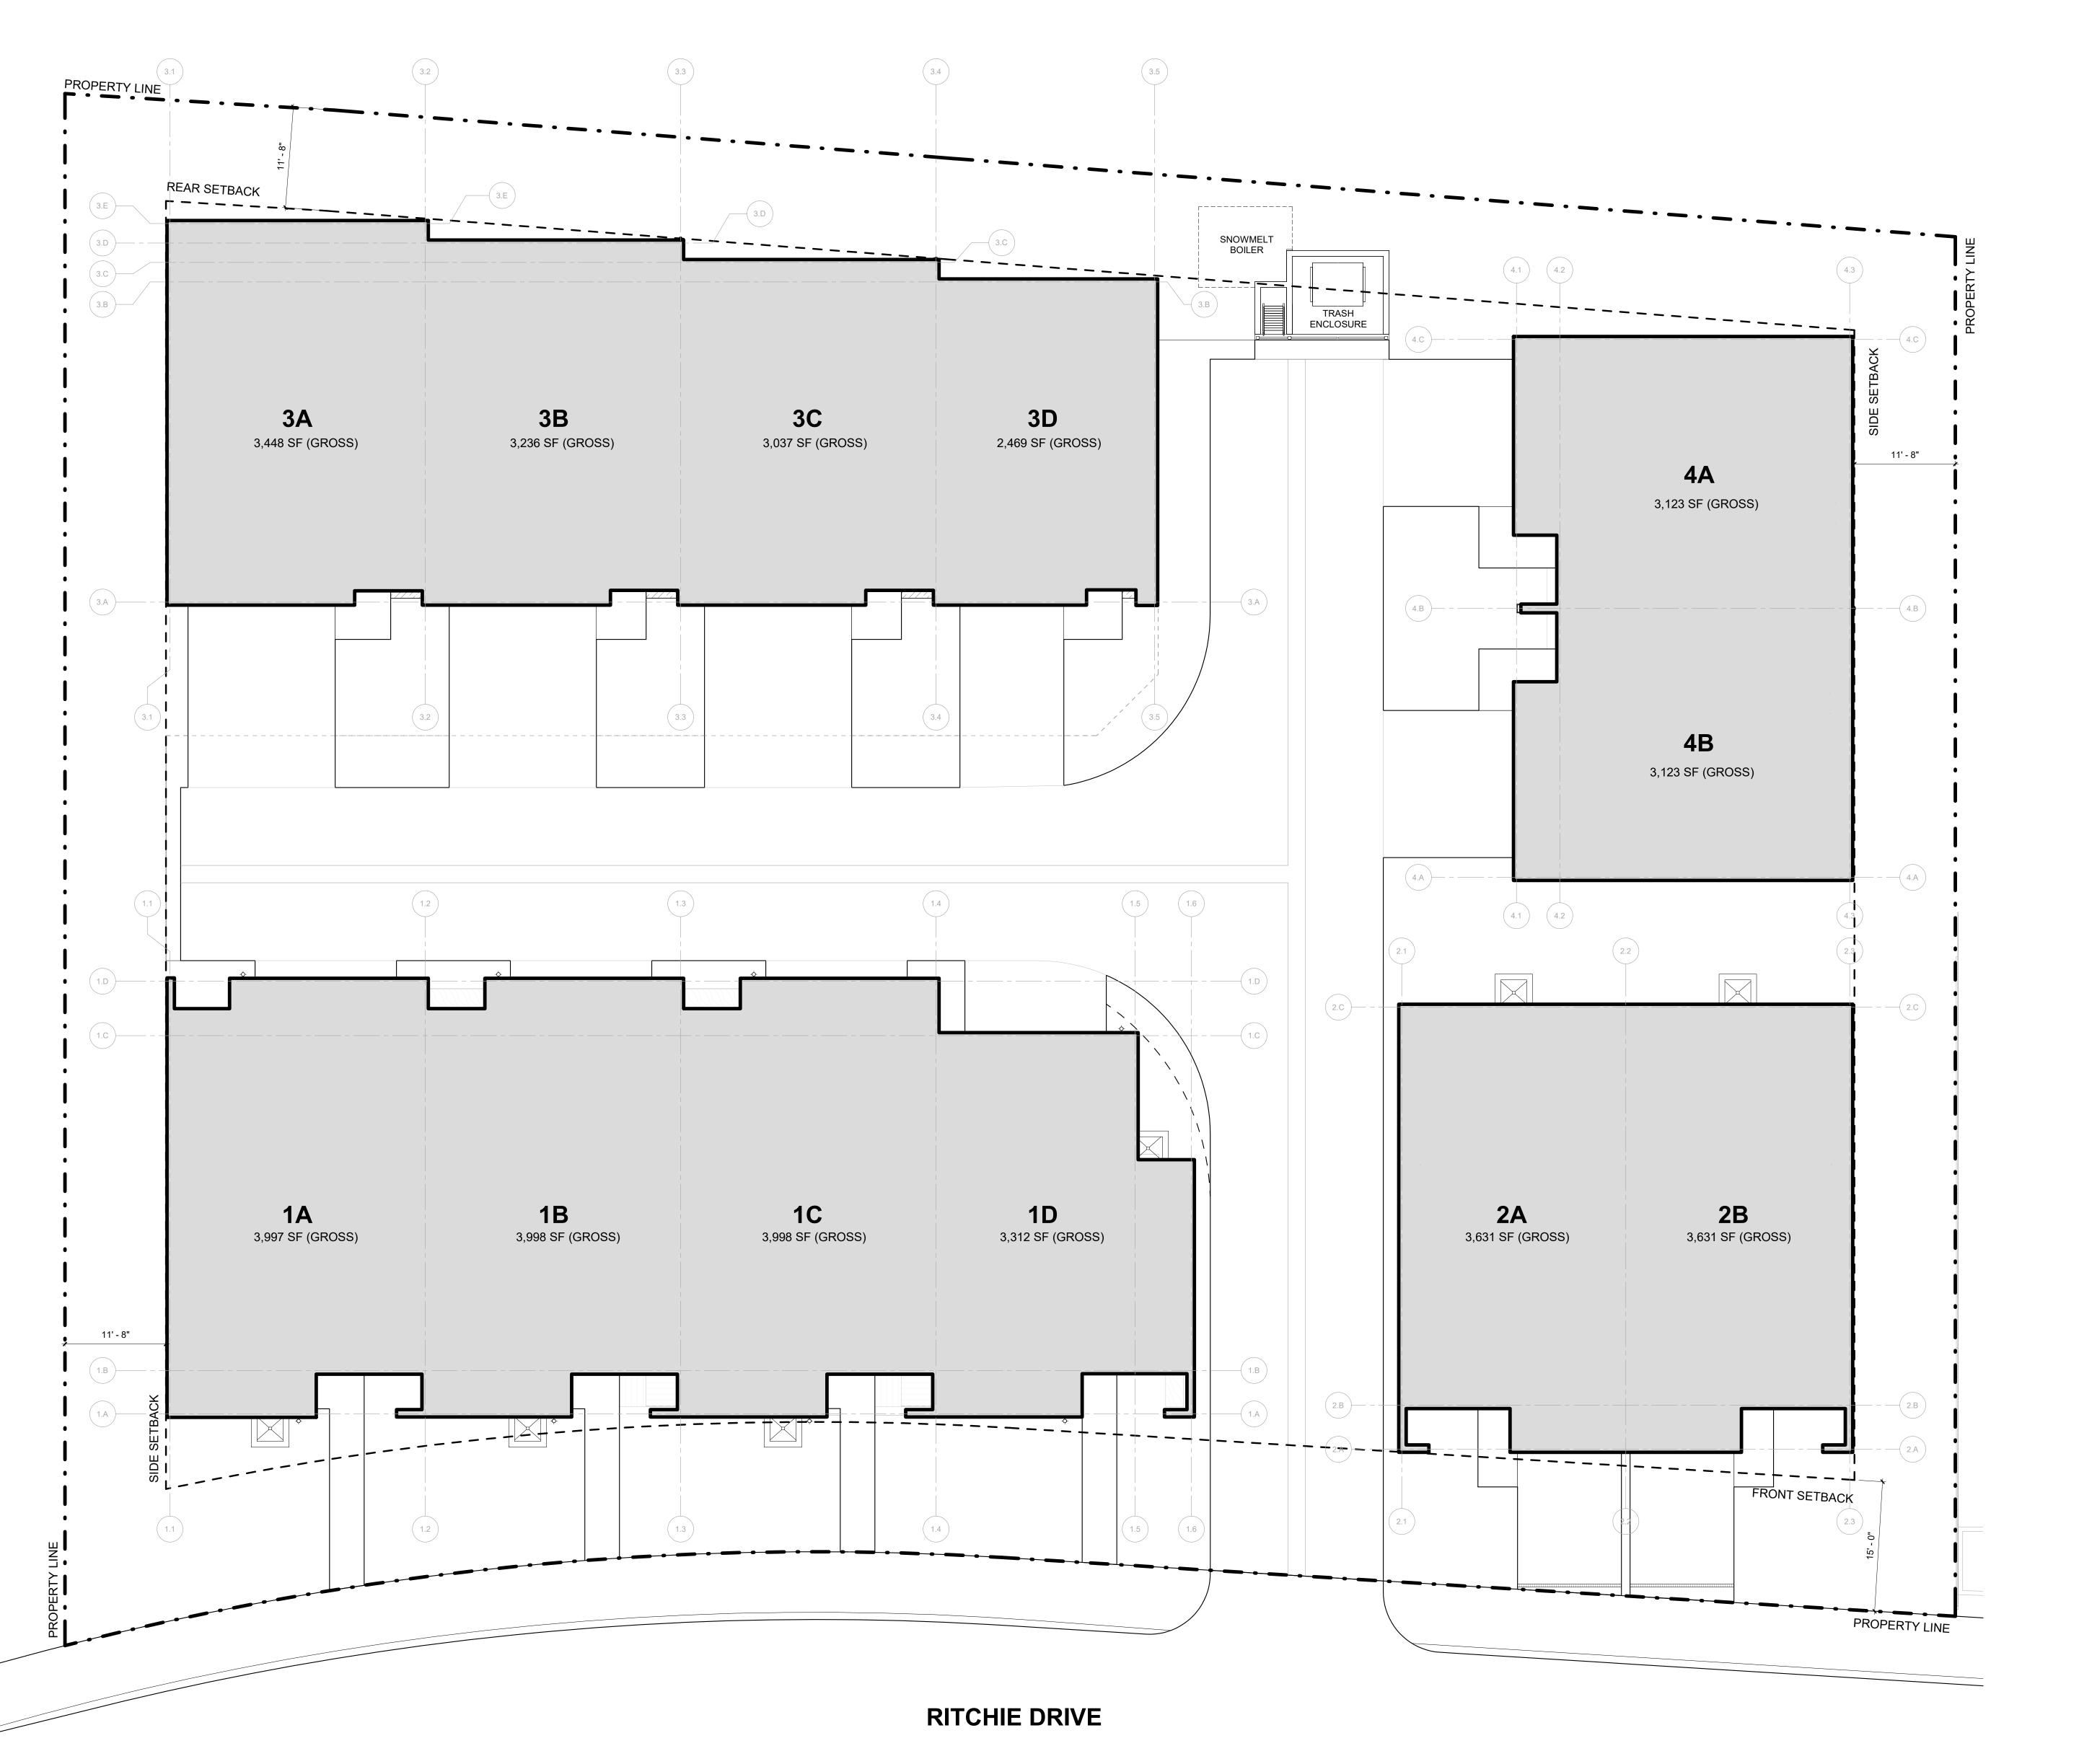

ADEA	- GROSS
1A (GARAGE)	AREA 541 SF
1A (LEVEL 01)	843 SF
1A (LEVEL 01)	1374 SF
1A (LEVEL 03)	1239 SF
TA (LEVEL 00)	3997 SF
1B (GARAGE)	541 SF
1B (LEVEL 01)	843 SF
1B (LEVEL 02)	1374 SF
1B (LEVEL 03)	1240 SF
TD (LL VLL 00)	3998 SF
1C (GARAGE)	541 SF
1C (LEVEL 01)	843 SF
1C (LEVEL 02)	1374 SF
1C (LEVEL 03)	1240 SF
10 (22 722 00)	3998 SF
1D (GARAGE)	543 SF
1D (LEVEL 01)	615 SF
1D (LEVEL 02)	1143 SF
1D (LEVEL 03)	1011 SF
15 (22 722 00)	3312 SF
2A (GARAGE)	548 SF
2A (LEVEL 01)	708 SF
2A (LEVEL 02)	1237 SF
2A (LEVEL 03)	1138 SF
27 (22 722 00)	3631 SF
2B (GARAGE)	548 SF
2B (LEVEL 01)	708 SF
2B (LEVEL 01)	1237 SF
2B (LEVEL 03)	1138 SF
25 (22722 00)	3631 SF
3A (GARAGE)	449 SF
3A (LEVEL 01)	827 SF
3A (LEVEL 02)	1196 SF
3A (LEVEL 03)	976 SF
0(=======)	3448 SF
3B (GARAGE)	449 SF
3B (LEVEL 01)	761 SF
3B (LEVEL 02)	1133 SF
3B (LEVEL 03)	893 SF
- \	3236 SF
3C (GARAGE)	449 SF
3C (LEVEL 01)	695 SF
3C (LEVEL 02)	1067 SF
3C (LEVEL 03)	827 SF
- (= - = - = - = - = - = - = - = - = -	3037 SF
3D (GARAGE)	363 SF
3D (LEVEL 01)	558 SF
3D (LEVEL 02)	866 SF
3D (LEVEL 03)	682 SF
05 (22 7 22 00)	2469 SF
4A (GARAGE)	476 SF
4A (LEVEL 01)	677 SF
4A (LEVEL 02)	1111 SF
4A (LEVEL 03)	859 SF
(3123 SF
4B (GARAGE)	476 SF
4B (LEVEL 01)	677 SF
4B (LEVEL 01) 4B (LEVEL 02)	1112 SF
4B (LEVEL 02) 4B (LEVEL 03)	859 SF
(FF A EF 09)	3123 SF
	3123 3 F

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PROJECT:
WARM SPRINGS TOWNHOMES
KETCHUM, ID

108 & 110 RITCHIE DR. KETCHUM, IDAHO

DRAWING TITLE:

DRAWING TITLE:

SITE PLAN - BUILDING AREAS

AL:


PROJECT NUMBER

2305

DRAWING NUMBER:

A-000

1/8" = 1'-0" SITE PLAN - BUILDING INFORMATION AREAS

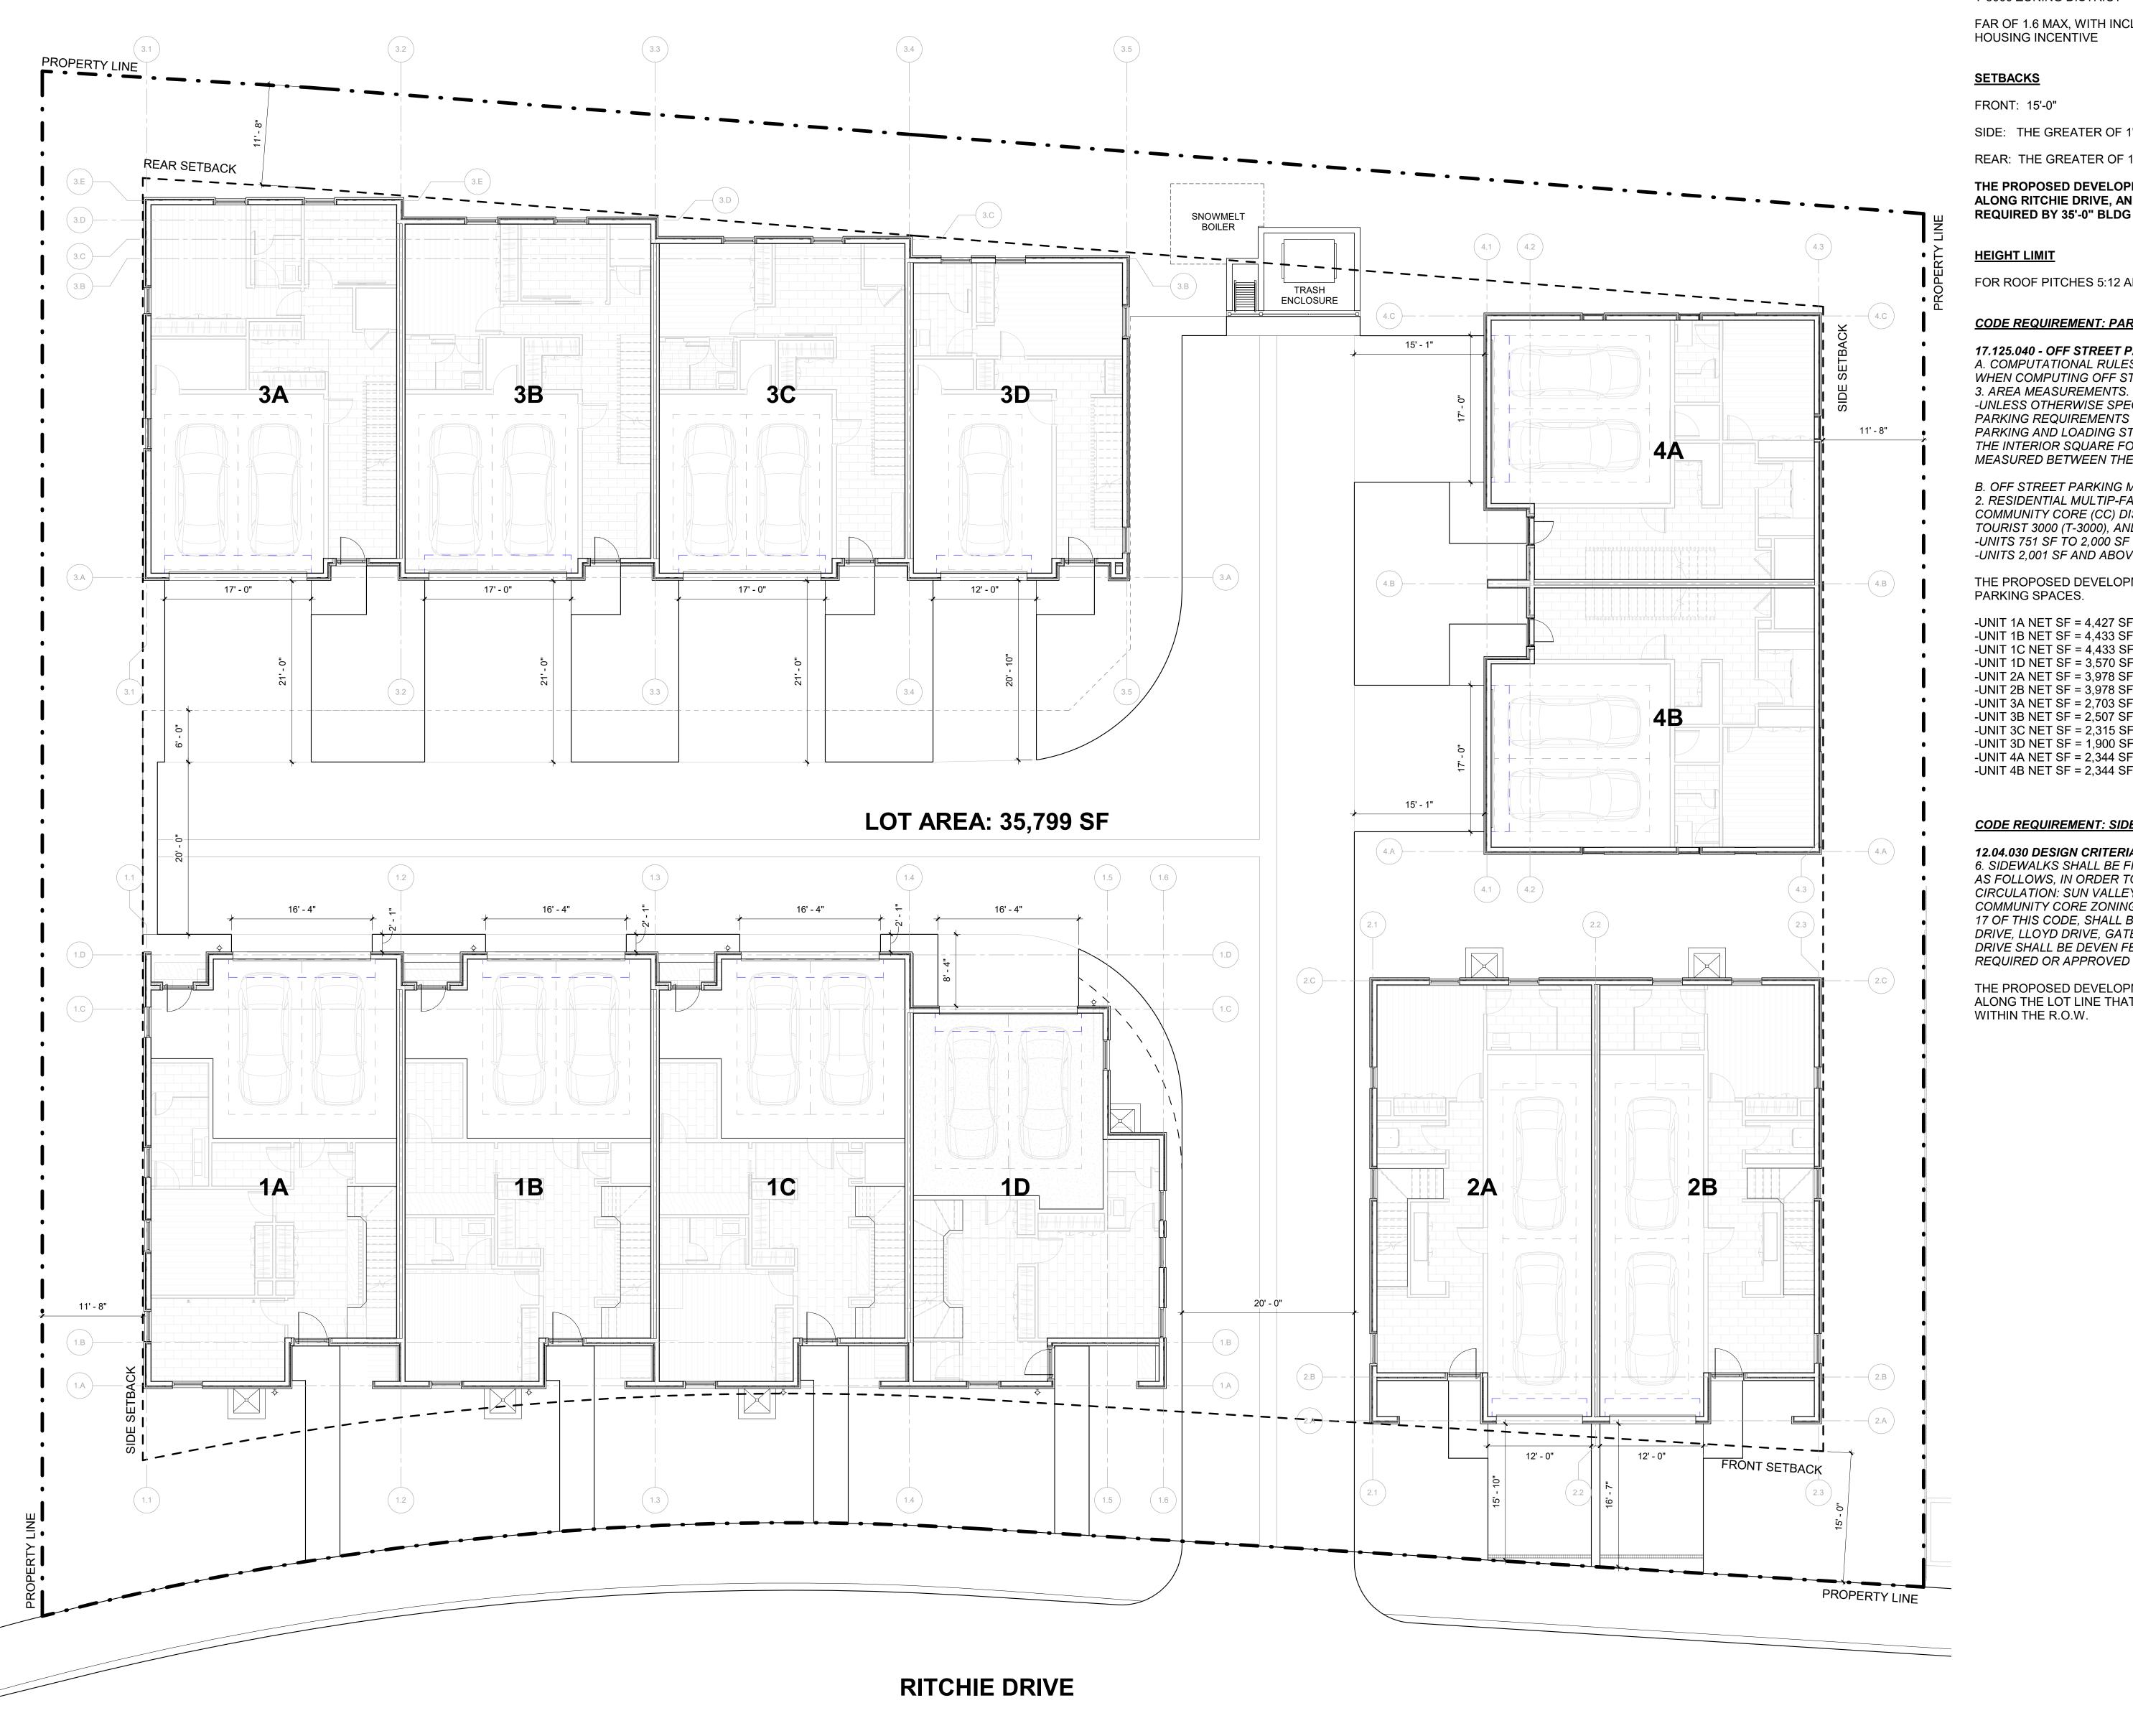

ZONING

T-3000 ZONING DISTRICT

FAR OF 1.6 MAX, WITH INCLUSIONARY

SIDE: THE GREATER OF 1' FOR EVERY 3' OF BLDG HT, OR 5'

REAR: THE GREATER OF 1' FOR EVERY 3' OF BLDG HT, OR 5'

THE PROPOSED DEVELOPMENT HAS A 15' SETBACK ALONG RITCHIE DRIVE, AND 11'-8" SIDE AND REAR AS REQUIRED BY 35'-0" BLDG HEIGHTS.

FOR ROOF PITCHES 5:12 AND UNDER = 35'-0"

CODE REQUIREMENT: PARKING

17.125.040 - OFF STREET PARKING AND LOADING CALCULATIONS A. COMPUTATIONAL RULES. THE FOLLOWING RULES APPLY WHEN COMPUTING OFF STREET PARKING AND LOADING REQ.

-UNLESS OTHERWISE SPECIFICALLY NOTED, RESIDENTIAL PARKING REQUIREMENTS FOR ALL SQUARE FOOTAGE BASED PARKING AND LOADING STANDARDS SHALL BE COMPUTED ON THE INTERIOR SQUARE FOOTAGE OF EACH RESIDENTIAL UNIT, MEASURED BETWEEN THE INTERIOR WALLS OF THE UNIT.

B. OFF STREET PARKING MATRIX.

2. RESIDENTIAL MULTIP-FAMILY DWELLING WITHIN THE COMMUNITY CORE (CC) DISTRICT AND THE TOURIST (T), TOURIST 3000 (T-3000), AND TOURIST 4000 (T-4000) -UNITS 751 SF TO 2,000 SF - 1 PARKING SPACE -UNITS 2,001 SF AND ABOVE - 2 PARKING SPACES

THE PROPOSED DEVELOPMENT INCLUDES 23 TOTAL INTERIOR PARKING SPACES.

-UNIT 1A NET SF = 4,427 SF (2 PARKING SPACES) -UNIT 1B NET SF = 4,433 SF (2 PARKING SPACES)

-UNIT 1C NET SF = 4,433 SF (2 PARKING SPACES) -UNIT 1D NET SF = 3,570 SF (2 PARKING SPACES)

-UNIT 2A NET SF = 3.978 SF (2 PARKING SPACES) -UNIT 2B NET SF = 3,978 SF (2 PARKING SPACES) -UNIT 3A NET SF = 2,703 SF (2 PARKING SPACES)

-UNIT 3B NET SF = 2,507 SF (2 PARKING SPACES) -UNIT 3C NET SF = 2,315 SF (2 PARKING SPACES)

-UNIT 3D NET SF = 1,900 SF (1 PARKING SPACE) -UNIT 4A NET SF = 2,344 SF (2 PARKING SPACES) -UNIT 4B NET SF = 2,344 SF (2 PARKING SPACES)

CODE REQUIREMENT: SIDEWALKS

12.04.030 DESIGN CRITERIA. M. SIDEWALKS, CURB AND GUTTER. 6. SIDEWALKS SHALL BE FIVE FEET WIDE, EXCEPT SPECIFICALLY AS FOLLOWS, IN ORDER TO ACCOMMODATE HEAVY PEDESTRIAN CIRCULATION: SUN VALLEY ROAD AND MAIN STREET WITHIN THE COMMUNITY CORE ZONING DISTRICT (CC), AS DEFINED IN TITLE 17 OF THIS CODE, SHALL BE EIGHT FEET IN WIDTH; AND SKYWAY DRIVE, LLOYD DRIVE, GATES ROAD, RITCHIE DRIVE AND HOWARD DRIVE SHALL BE DEVEN FEET IN WIDTH, UNLESS OTHERWISE REQUIRED OR APPROVED BY THE CITY COUNCIL.

THE PROPOSED DEVELOPMENT INCLUDES A 7'-0" WIDE SIDEWALK ALONG THE LOT LINE THAT IS ADJACENT TO RITCHE DRIVE WITHIN THE R.O.W.

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DESIGN REVIEW APPLICATION 25.09.09

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WARM SPRINGS TOWNHOMES KETCHUM, ID


108 & 110 RITCHIE DR. KETCHUM, IDAHO

DRAWING TITLE: SITE PLAN - BUILDING CODES

PROJECT NUMBER

DRAWING NUMBER: A-001

1/8" = 1'-0" SITE PLAN - BUILDING INFORMATION

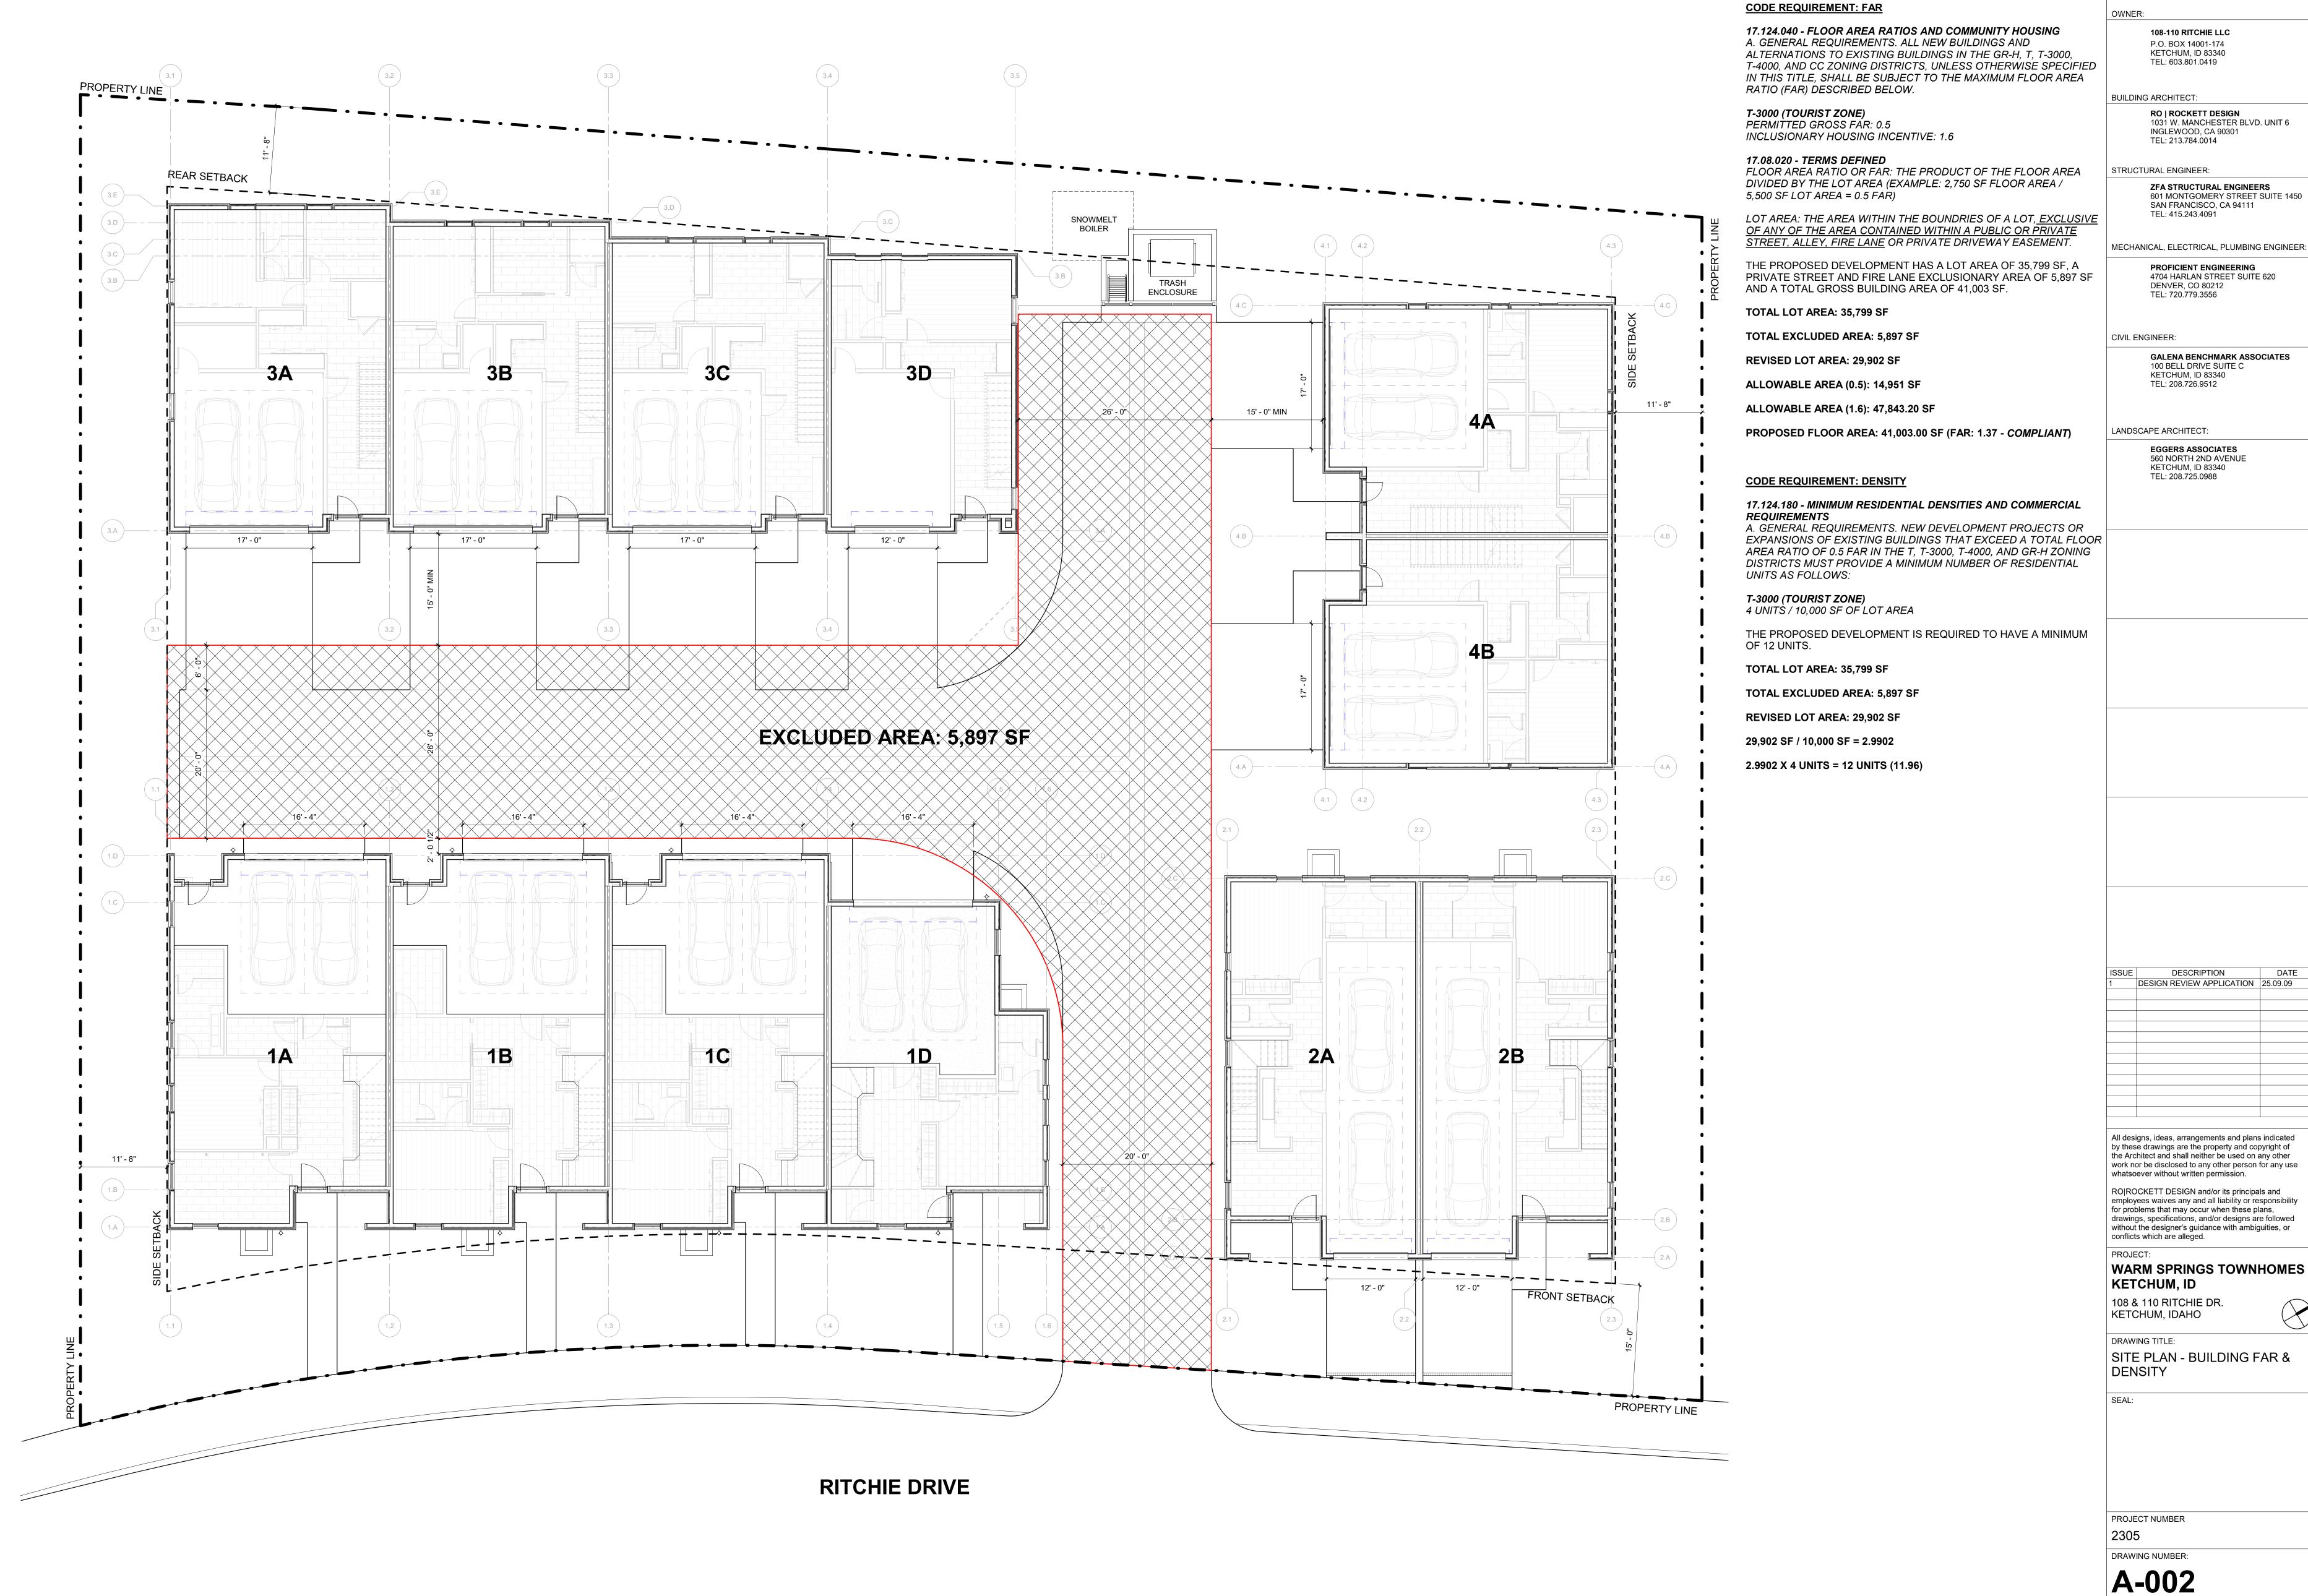

601 MONTGOMERY STREET SUITE 1450


GALENA BENCHMARK ASSOCIATES


DESIGN REVIEW APPLICATION 25.09.09

without the designer's guidance with ambiguities, or conflicts which are alleged.

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1/8" = 1'-0" | SITE PLAN - BUILDING INFORMATION B



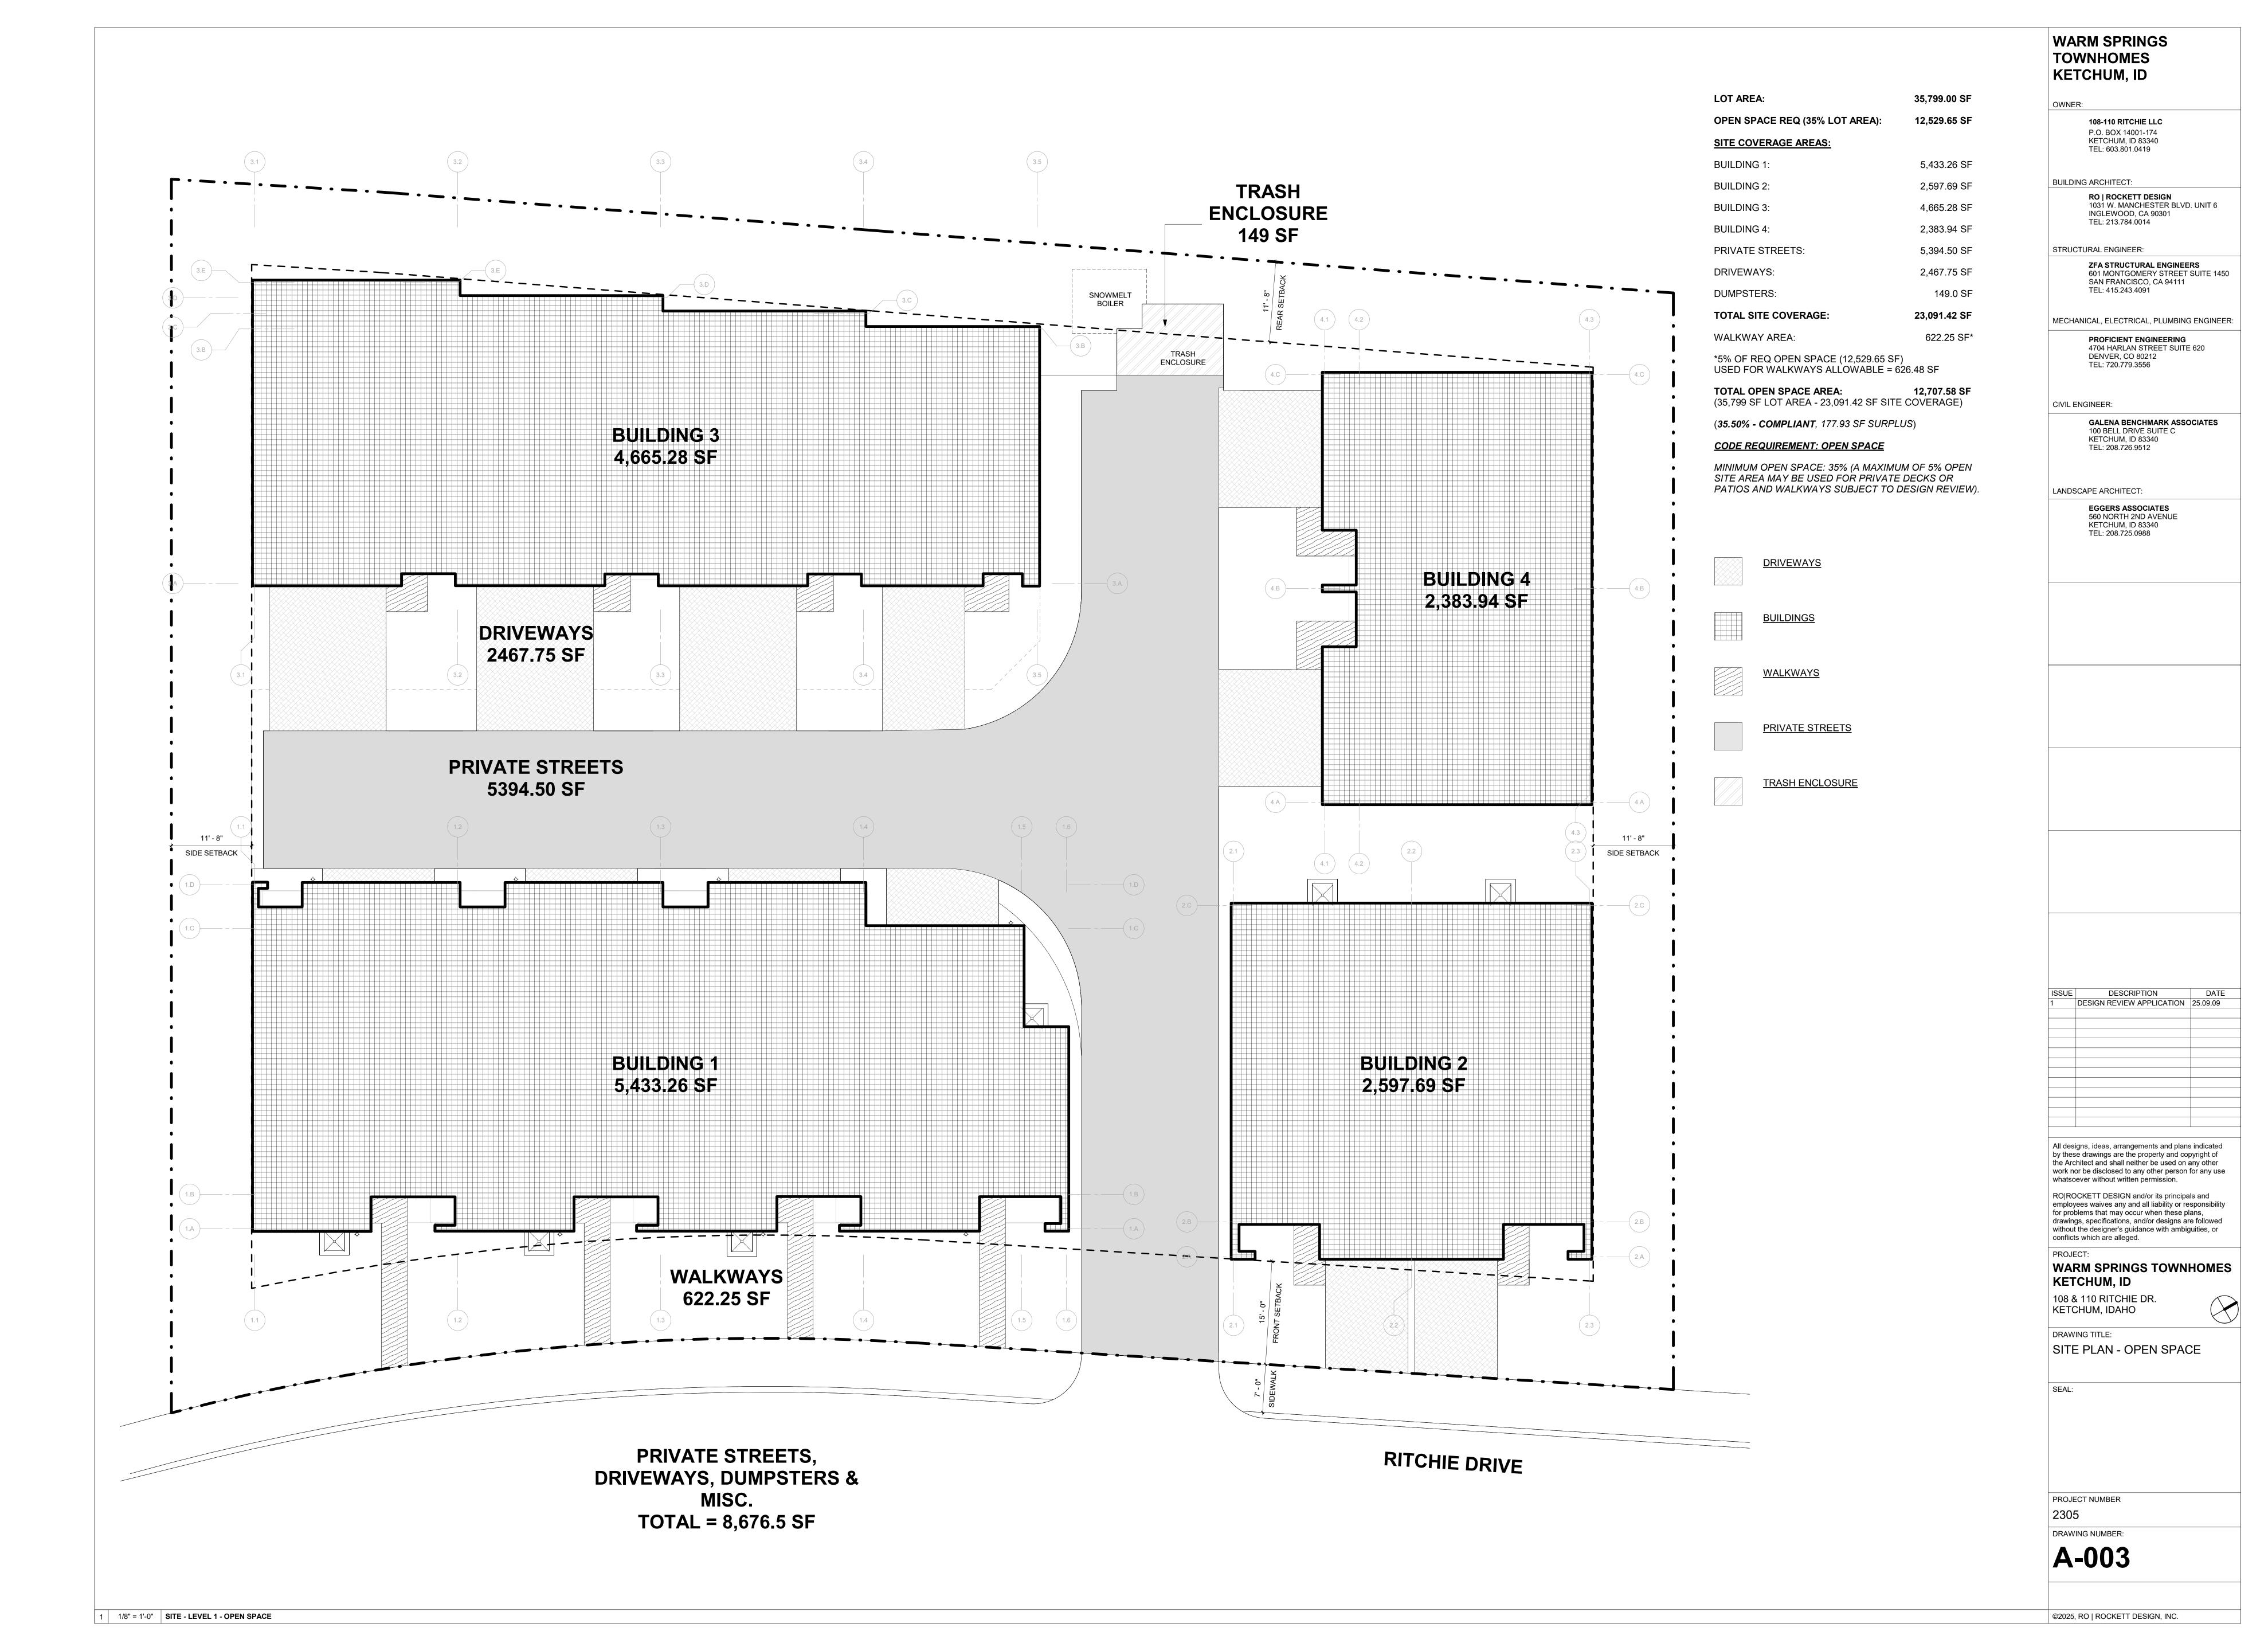

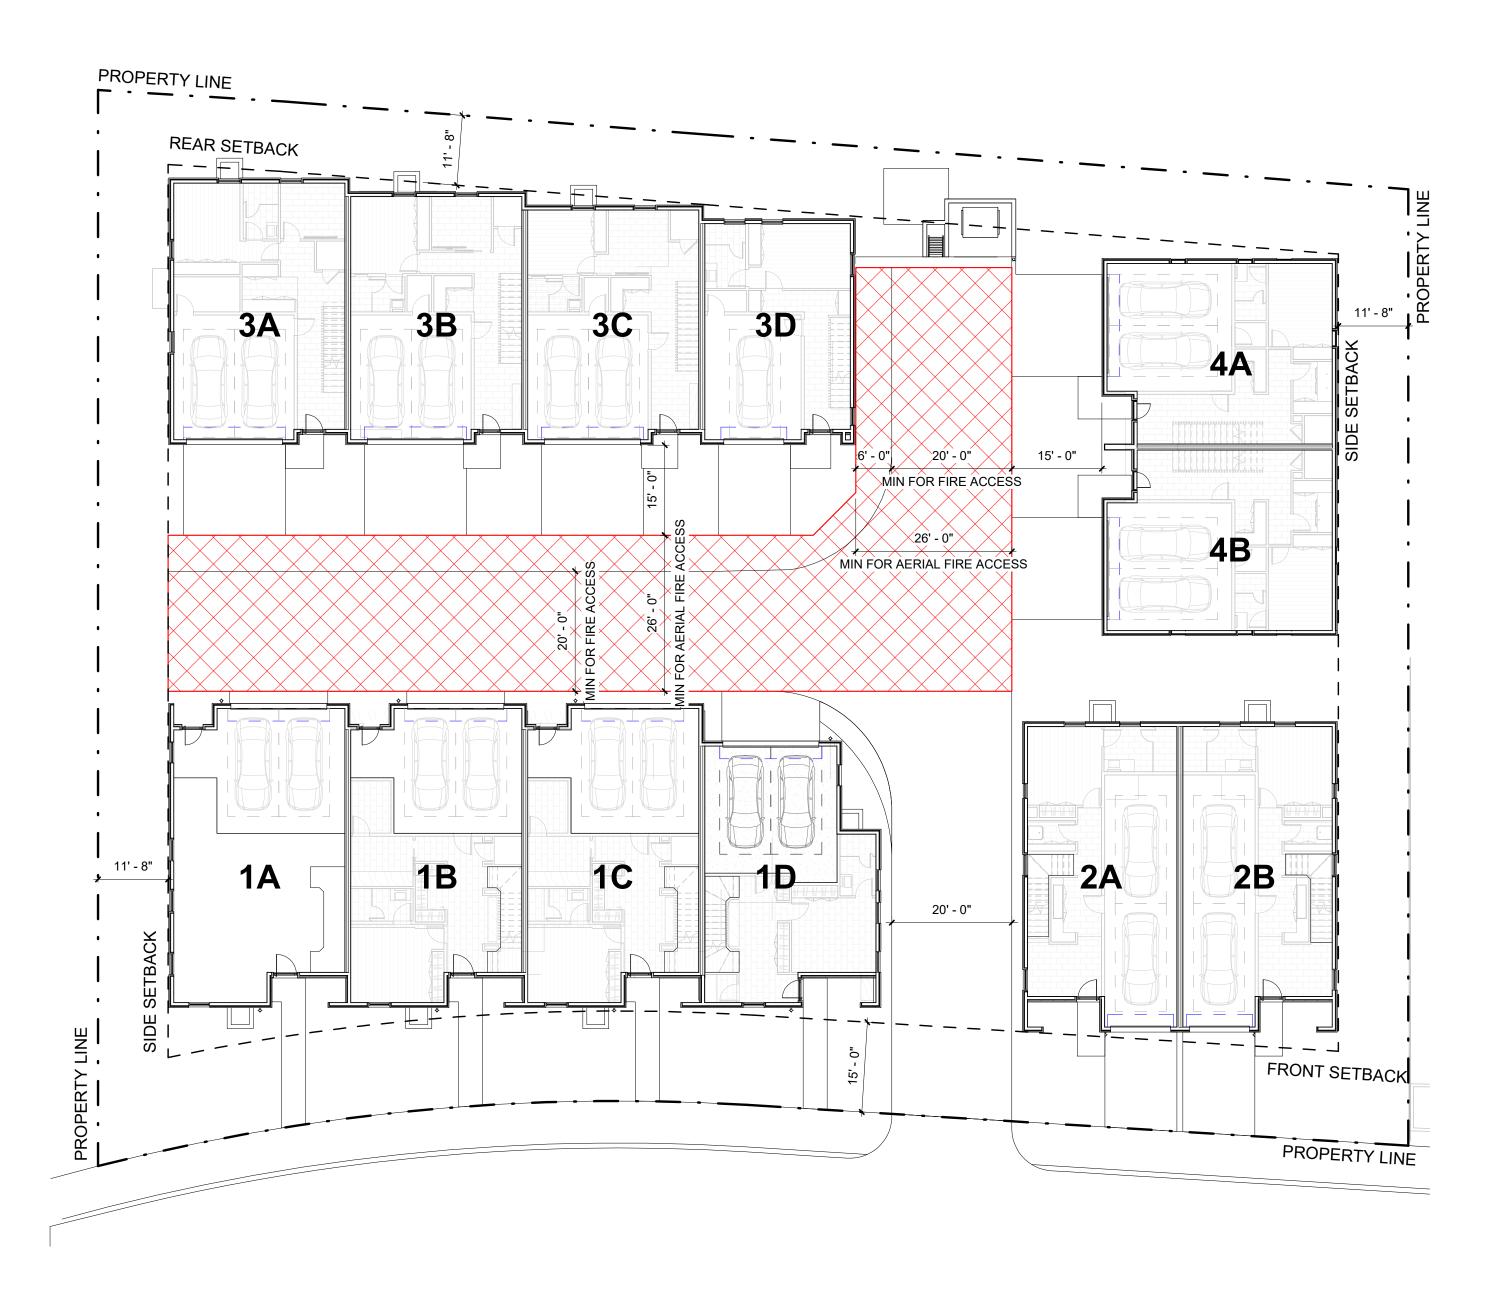CODE REQUIREMENT: FIRE ACCESS

APPENDIX D OF 2018 IFC, SECTION D105 - AERIAL FIRE APPARATUS ACCESS ROADS

D105.1 - WHERE THE VERTICAL DISTANCE BETWEEN THE GRADE PLANE AND THE HIGHEST ROOF SURFACE EXCEEDS 30 FEET, APPROVED FIRE APPARATUS ACCESS ROADS SHALL BE PROVIDED. FOR PURPOSES OF THIS SECTION, THE HIGHEST ROOF SURFACE SHALL BE DETERMINED BY MEASUREMENT TO THE EAVE OF A PITCHED ROOF, THE INTERSECTION OF THE ROOF TO EXTERIOR WALL, OR THE TOP OF PARAPET WALLS, WHICHEVER IS GREATER.


D105.2 - AERIAL FIRE APPARATUS ACCESS ROADS SHALL HAVE A MINIMUM UNOBSTRUCTED WIDTH OF 26 FEET, EXCLUSIVE OF SHOULDERS, IN THE IMMEDIATE VICINITY OF THE BUILDING OR PORTION THEREOF.

D105.3 - ONE OR MORE OF THE REQUIRED ACCESS ROUTES MEETING THIS CONDITION SHALL BE LOCATED NOT LESS THAN 15 FEET AND NOT GREATER THAN 30 FEET FROM THE BUILDING AND SHALL BE POSITIONED PARALLEL TO ONE ENTIRE SIDE OF THE BUILDING. THE SIDE OF THE BUILDING ON WHICH THE AERIAL FIRE APPARATUS ACCESS ROAD IS POSITIONED SHALL BE APPROVED BY THE FIRE CODE OFFICIAL.

THE PROPOSED DEVELOPMENT HAS A 20 FOOT WIDE PRIVATE ROAD THAT WOULD PROVIDE ACCESS TO THE INTERIOR OF THE SITE AND A DESIGNATED 20 FOOT WIDE PORTION OF THE ROAD FOR AERIAL FIRE ACCESS TO BUILDING 3 AND 4. ADDITIONALLY, BUILDING 3 AND 4 ARE SETBACK 15 FEET FROM THE EDGE OF THE FIRE ACCESS ROAD.



CODE REQUIREMENT: SNOWMELT

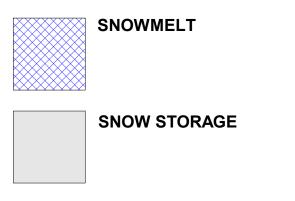

GRASS-CRETE PAVERS

H. SNOW STORAGE

- 1 SNOW STORAGE AREAS SHALL NOT BE LESS THAN THIRTY PERCENT (30%) OF THE IMPROVED PARKING AND PEDESTRIAN CIRCULATION AREAS. 2 - SNOW STORAGE AREAS SHALL BE PROVIDED ON SITE.
- 3 A DESIGNATED SNOW STORAGE AREA SHALL NOT HAVE ANY DIMENSION LESS THAN FIVE FEET (5') AND SHALL BE A MINIMUM OF TWENTY FIVE SQUARE FEET (25 SF) 4 IN LIEU OF PROVIDING SNOW STORAGE AREAS, SNOWMELT AND HAULING OF SNOW MAY BE ALLOWED.
- THE PROPOSED DEVELOPMENT WILL PROVIDE SITE SNOWMELT FOR ALL DRIVEWAYS, PATHWAYS, AND PRIVATE ROADS. SNOWMELT BOILER EQUIPMENT WILL BE SUBGRADE, LOCATED AT THE END OF THE PRIVATE ROAD AND SCREENED FROM VIEW OF NEIGHBORS. SEE MEP FOR DETAILED SNOWMELT PLANS.
- THERE IS 638 SF OF GRASS-CRETE SCHEDULED FOR FIRE ACCESS THAT WILL NOT HAVE SNOWMELT. THESE AREAS WILL BE SHOVELED AND AN ADDITIONAL 884 SF OF SNOW STORAGE HAS BEEN DESIGNATED ON SITE.

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BUE DESCRIPTION DATE
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WARM SPRINGS TOWNHOMES
KETCHUM, ID

108 & 110 RITCHIE DR. KETCHUM, IDAHO

DRAWING TITLE:

SITE PLAN - FIRE

SITE PLAN - FIRE ACCESS & SNOWMELT

SEAL:


PROJECT NUMBER

DRAWING NUMBER:

A-004

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1/16" = 1'-0" | SITE PLAN - FIRE ACCESS REQUIREMENTS | 2 | 1/16" = 1'-0" | SITE PLAN - SNOWMELT

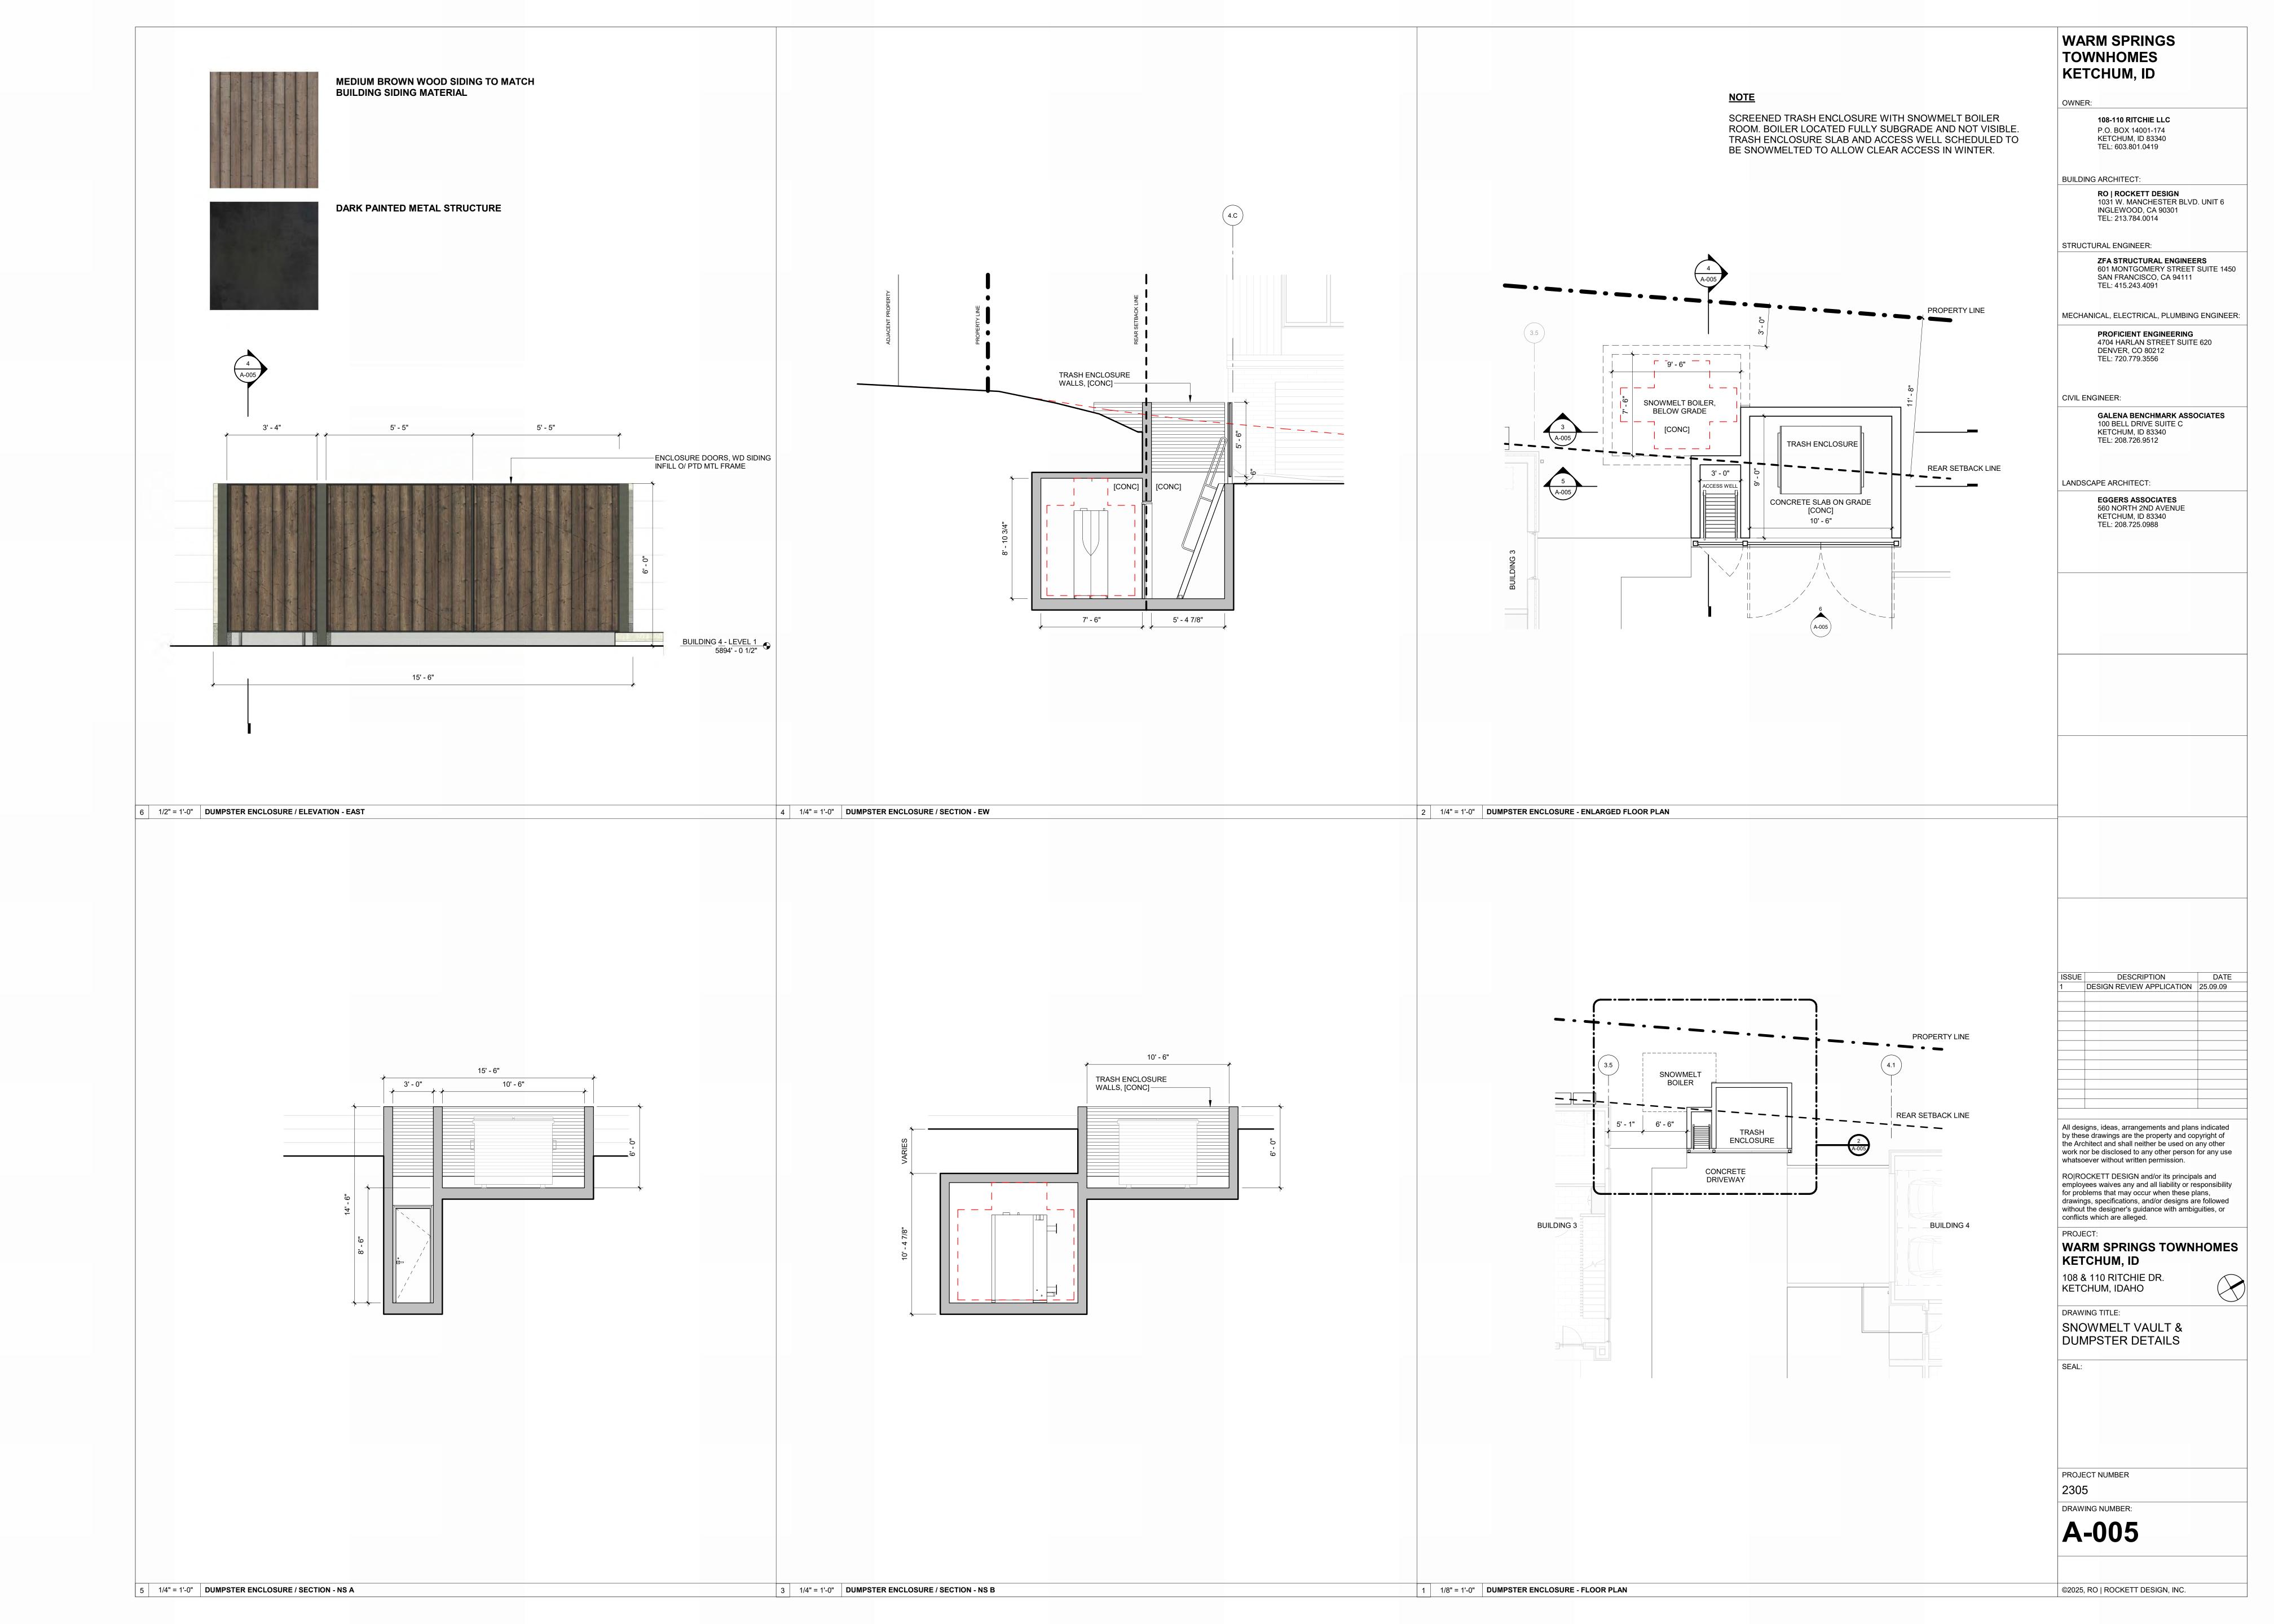

CLEAR CREEK DISPOSAL

PO Box 130 * Ketchum, ID 83340 * Phone 208.726.9600 * www.ccdisposal.com

June 14, 2024

Planning & Zoning City of Ketchum P O Box 2315 Ketchum, ID 83340

Via email:

Re: 108 Richie Drive

To whom It May Concern,

Please consider this letter as a will serve for the above address. Attached to this email are plans for a 12-unit townhome project to be built. When built according to the plans the enclosure is ample for a dumpster to service the project.

Conditions that will need to be maintained:

- Snow and Ice removal to and inside of the enclosure
- Access to the enclosure and the turn around area for egress
- Gates maintained in working order

Multiple pickup days may be necessary to accommodate the amount of waste generated depending on type(s) of occupancy.

CLEAR CREEK

Respectfully,

Clear Creek Disposal

.108 Richie Drive



www.intgas.com

Presidio Vista Properties Hank Moore Senior Development Manager 603-801-0419 hank@presidiovistaproperties.com May 13, 2024

RE: 108 & 110 Richie Dr., Ketchum Idaho 83340. Lots 3 & 4 Warm Springs Village Subdivision. County of Blaine.

This letter is to serve as verification of the availability of natural gas currently to the above referenced project in Ketchum, Idaho.

The total estimated cost of extending our natural gas infrastructure and satisfying current tariffs to serve the above entity is the responsibility of the contractor/ owner of said project and must be paid in advance of construction.

Extensions of our natural gas mains and services will be provided and installed in accordance with our current tariffs, guidelines, policies and provisions on file with the Idaho Public Utilities Commission.

If you need further information regarding this project, please call me at 208-737-6314.

Sincerely,

Lance D. McBride

Lance D. McBride Energy Services Representative Sr. lance.mcbride@intgas.com 208-737-6314

Hank Moore

Friday, May 17, 2024 10:27 AM Sent: To: Hank Moore

You can provide this email to the city of Ketchum for your application:

I have reviewed the proposed project by Presidio Vista Properties for 12 luxury townhomes on Ritchie Drive.

As this is in the preliminary stages, I have not finalized my design on the project. The proposed transformer locations may work, but I'll have to review when I get into my design phase. I have indicated where they may also be placed depending on the voltage drop, once I get into it. Additionally, we need 10' of clearance to the front of the transformers for safe electrical operation. They can be landscaped on side and rear, no matter where they are placed. We do have primary power on Ritchie Drive, but again, until I start my design, I will not know if I need another device to pick it up (sector) and/or have to cross Ritchie Drive to get to it.

Once the customer makes formal application for design the company will provide electrical service to the project subject to obtaining of any required easements, rights of way, and in compliance with the statues of the State of Idaho and the tariffs of the company on file with the Idaho Public Utilities Commission (PUC), in particular, the General Rules and Regulations, covering new service attachments and distribution line installations or alterations. The tariff is subject to change from time to time upon approval by the Idaho PUC.

Below is the initial review I have made. Please let me know if you have additional questions or comments.

Bennett, Cheryl < CBennett2@idahopower.com>

Cc: Erik de Bruijn Will Serve Email

Hank and Erik,

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WARM SPRINGS

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TOWNHOMES

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LANDSCAPE ARCHITECT:

OWNER:

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KETCHUM, ID 108 & 110 RITCHIE DR. KETCHUM, IDAHO

DRAWING TITLE: WILL SERVE LETTERS


PROJECT NUMBER


DRAWING NUMBER: **A-006**


NTS CLEAR CREEK DISPOSAL WILL SERVE LETTER

INTERMOUNTAIN GAS COMPANY WILL SERVE

1 NTS **IDAHO POWER WILL SERVE LETTER**

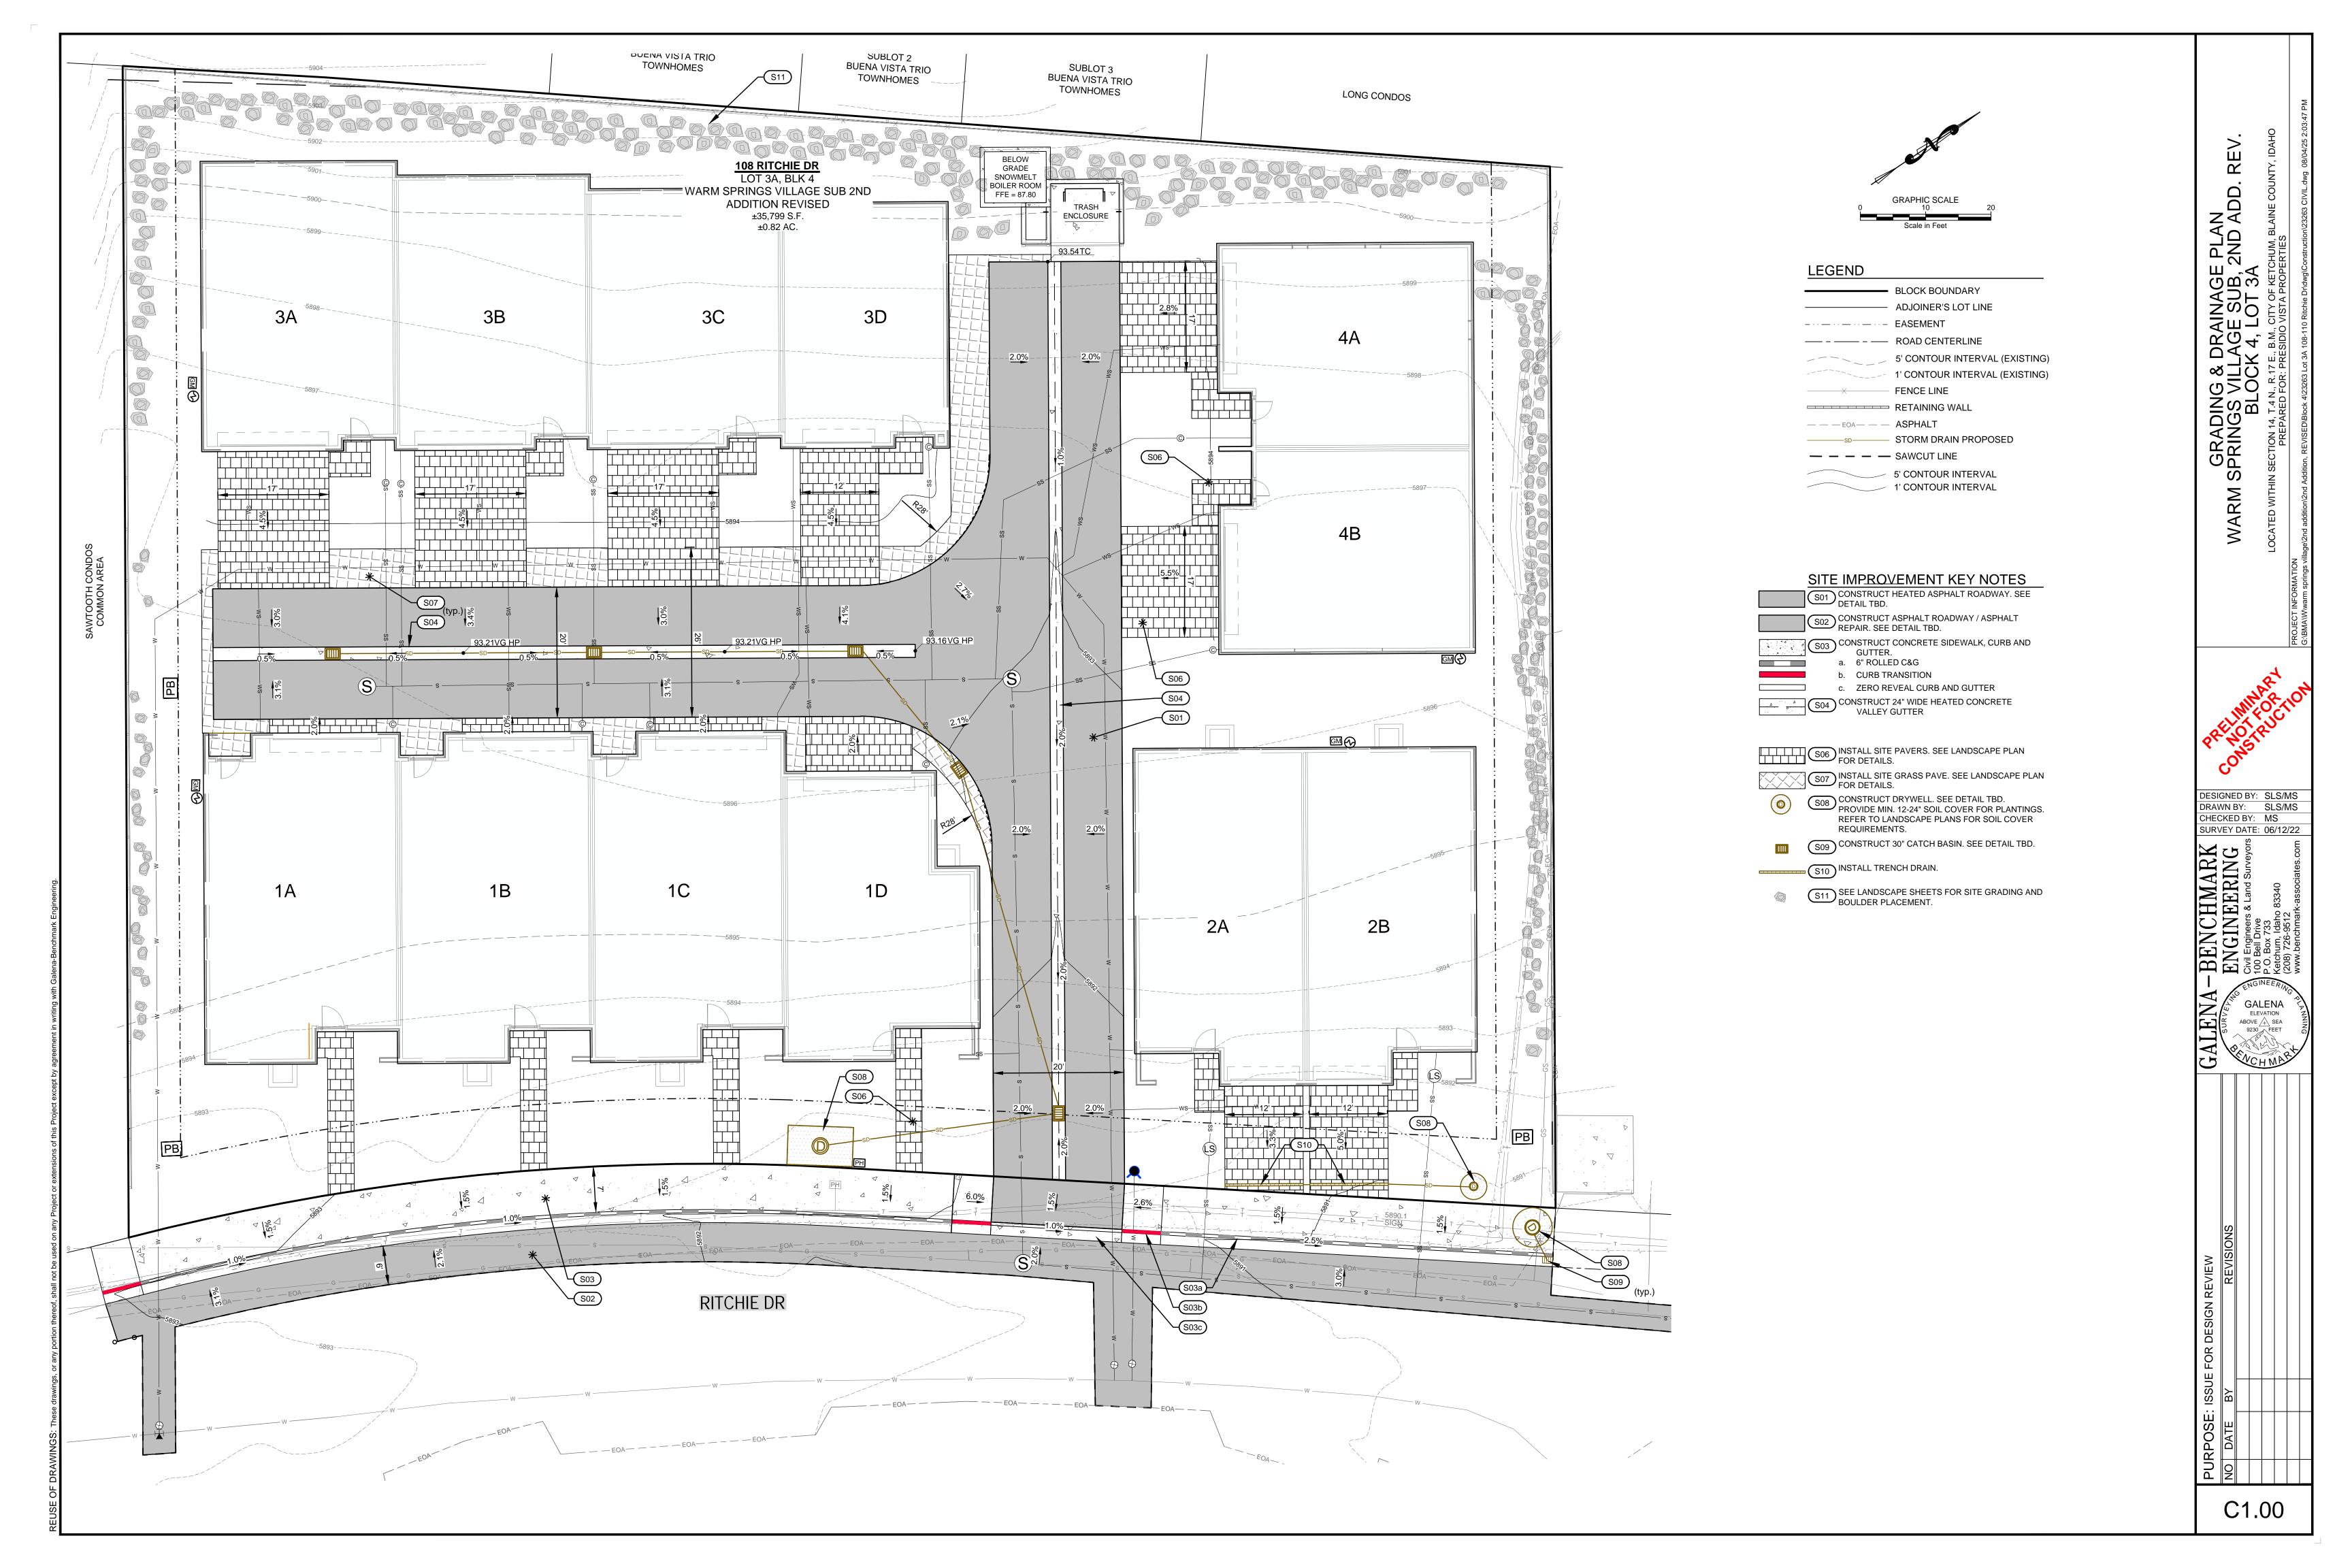

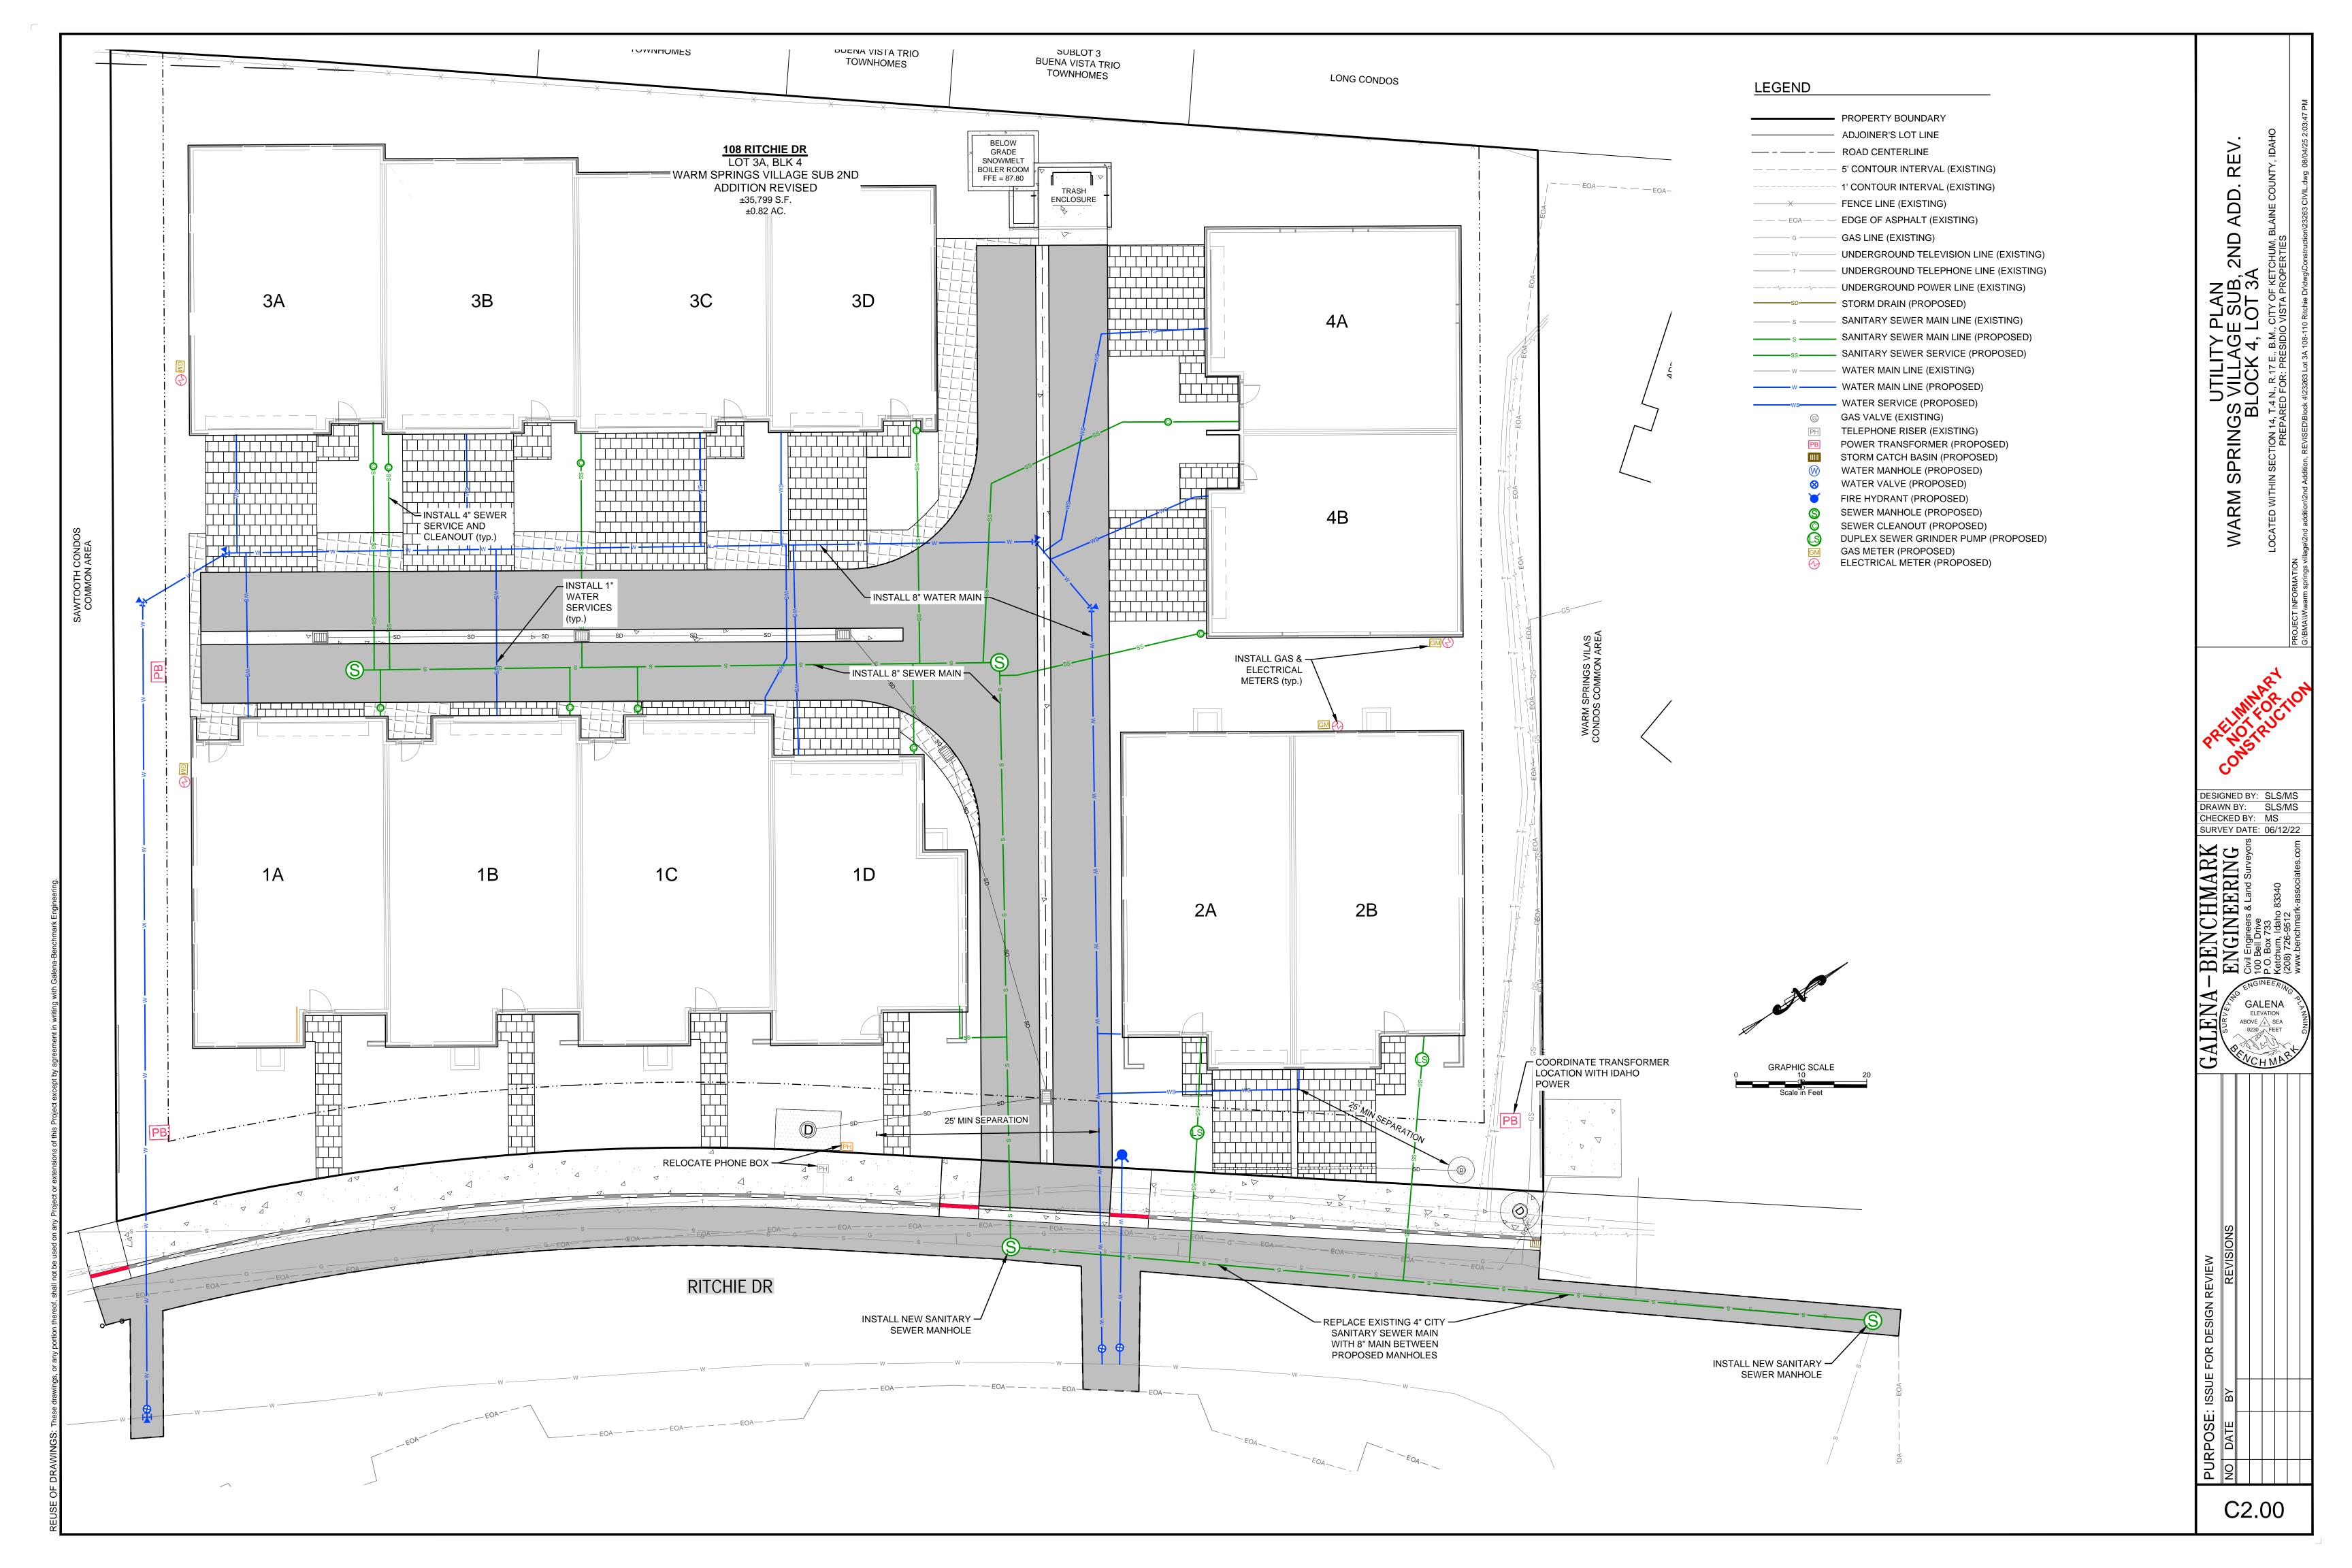

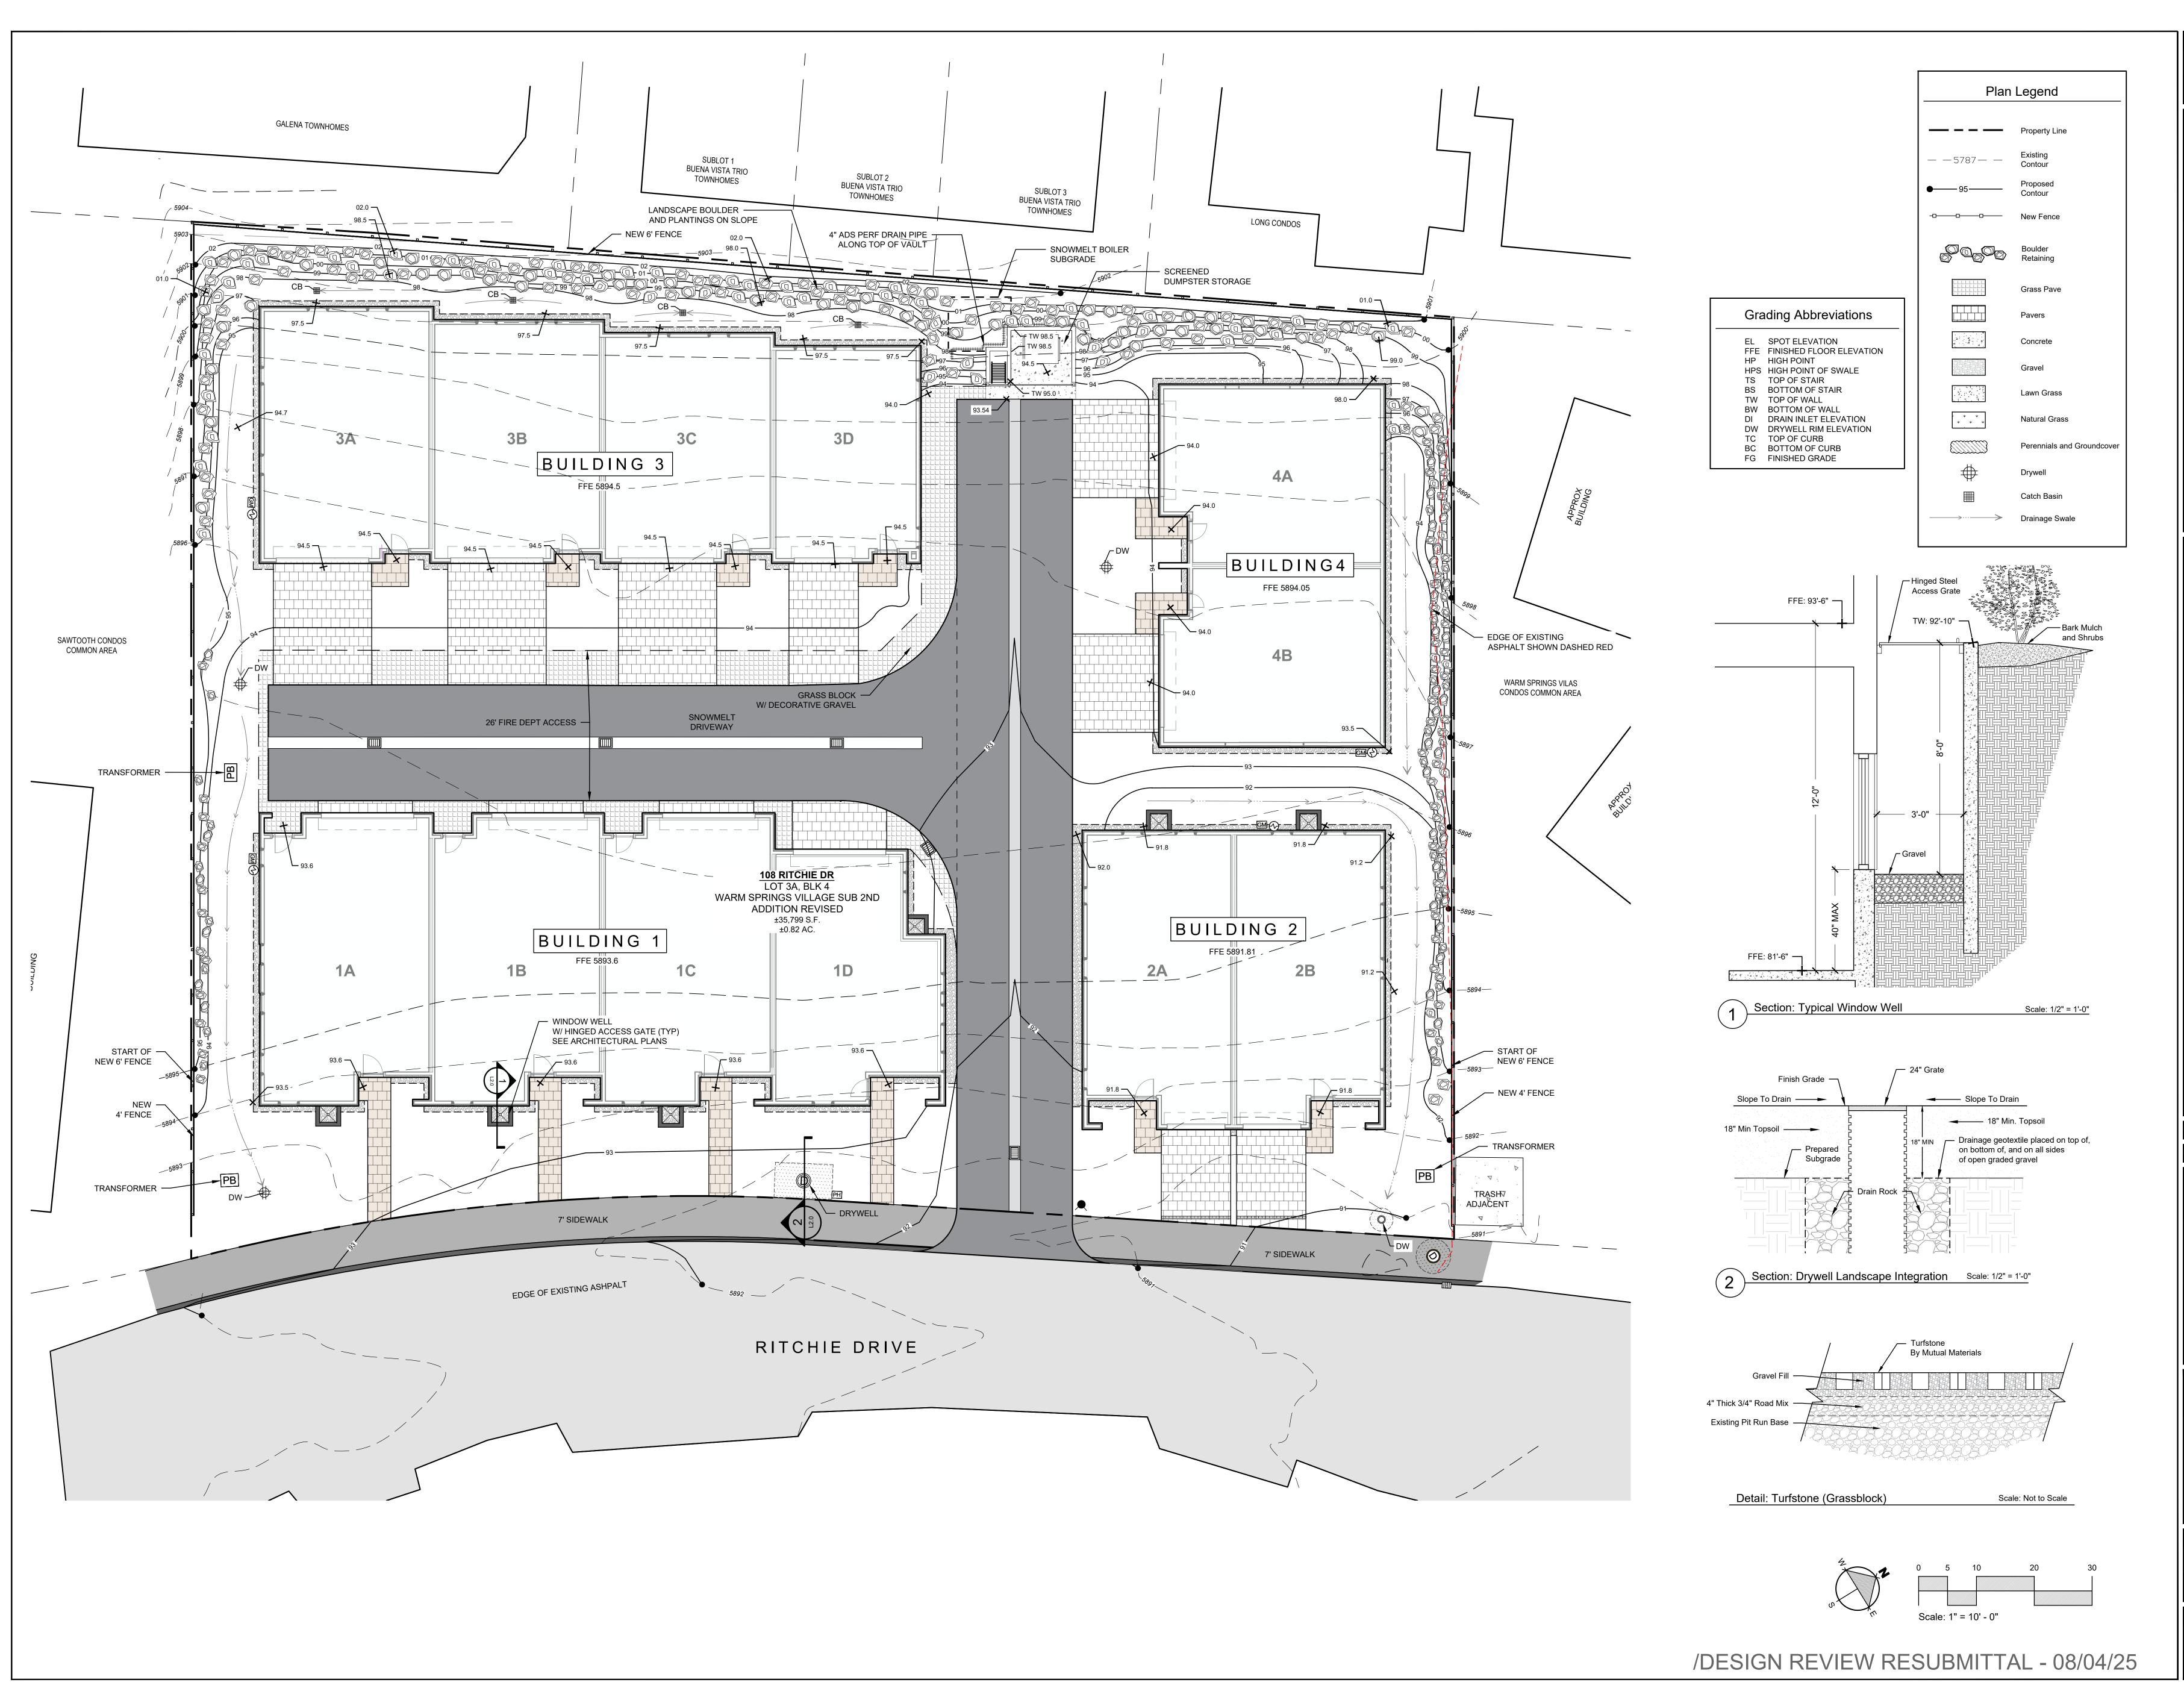


Warm Springs

Job No: 23.31 Scale: 1"=10'-0" ssue/Revisions: Date: Concept Update 07/10/ Design Review 11/06/

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DR Resubmission 08/04/2

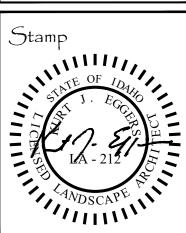

Sheet Title: Grading

Sheet No: 12.0



Warm Springs

EGGERS ASSOCIATES, P.A.

[landscape architecture]

7. Box 953

F(208) 725-0988

108 & 110 Kichie Drive
Lots 3 & 4
Warm Springs Village Subd.

Job No: 23.31

Scale: 1"=101-0"

Issue/Revisions: Date:

Concept Update 07/10/24

Design Review 11/06/24


DR Resubmission 03/14/25

DR Resubmission 06/25/25

DR Resubmission 07/17/25

DR Resubmission 08/04/25

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Sheet Title: Landscape Plan

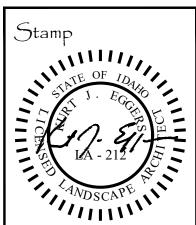Sheet No:



Warm Springs

GGERS ASSOCIATES, P.A.

[landscape architecture]

Box 953

T(208) 725-09

108 & 110 Kichie Drive Lots 3 & 4 Warm Springs Village Subd.

Job No: 23.31

Scale: 1"=10"-0"

Issue/Revisions: Date:

Concept Update 07/10/24

Design Review 11/06/24


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DR Resubmission 06/25/25

DR Resubmission 07/17/25

DR Resubmission 08/04/25


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Sheet Title: Fencing Plan


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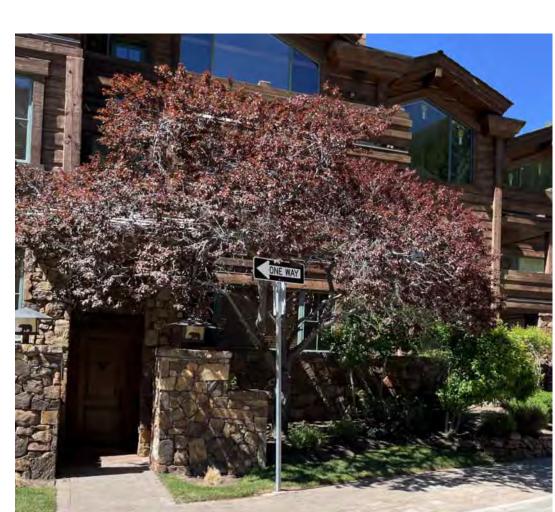
Sheet No:

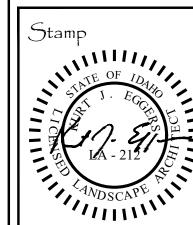

Sheet Title: Plant Materials

Sheet No:

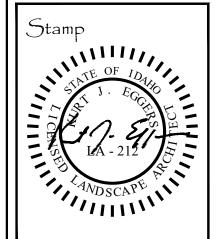


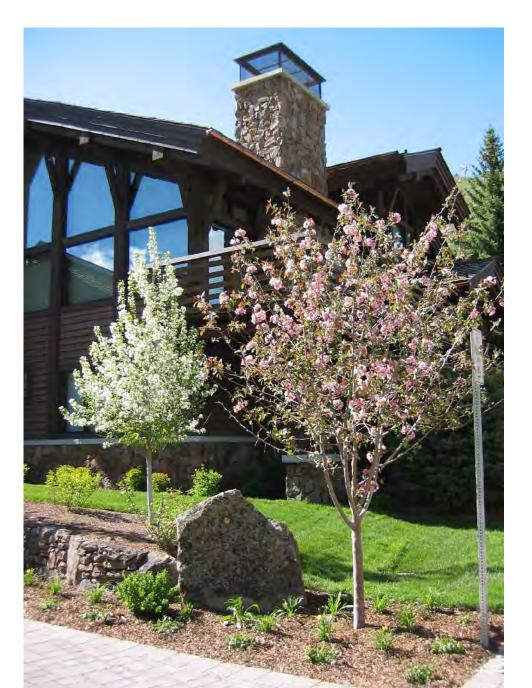







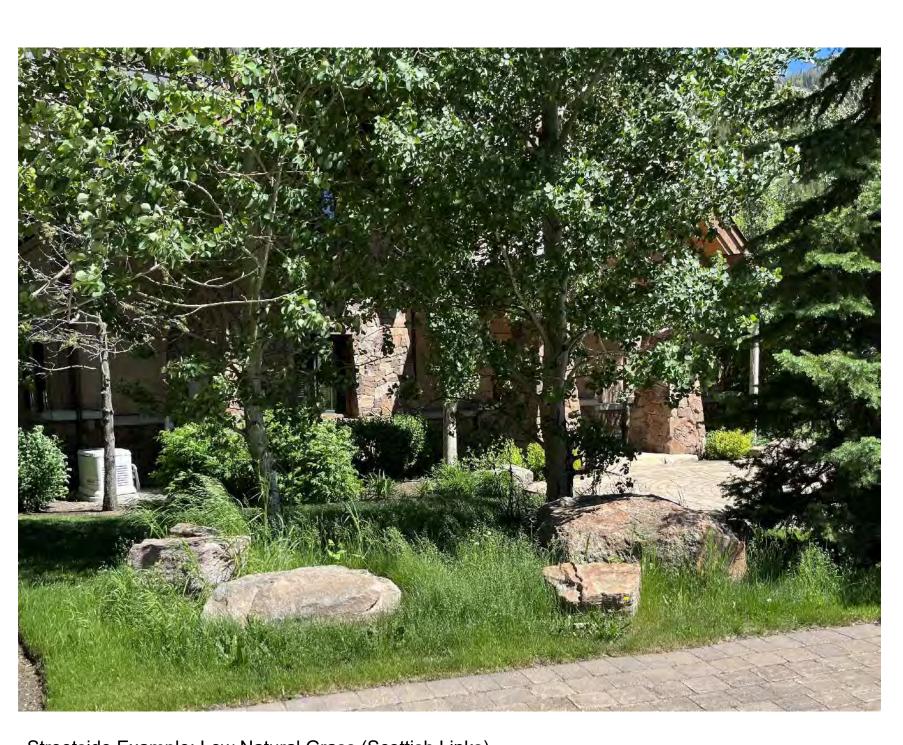

Mugo Pine Tree (6 - 8 Feet Installation Height)

Streetside Example: Low Natural Grass (Scottish Links)

PLANT MATERIALS

Flowering Crab Trees (8 Feet Installation Height)













STREET PLANTING EXAMPLES




Transformer Screening

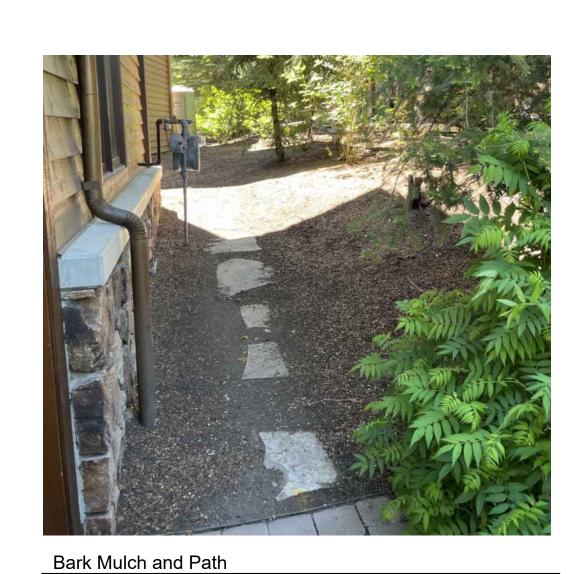

HARDSCAPE MATERIALS

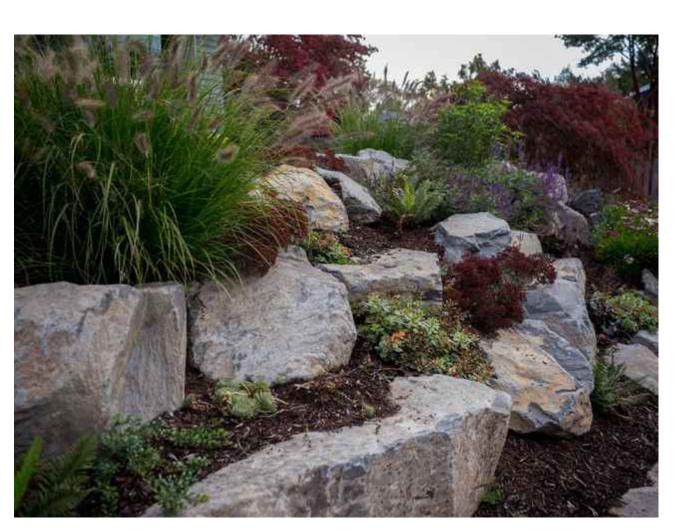

Landscape Boulders With Plantings

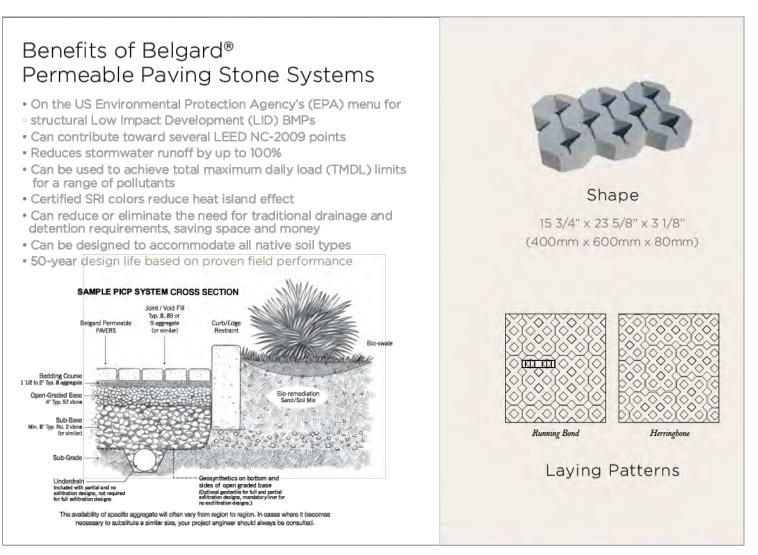

Driveable Permeable Pavers / Filled with Decorative Gravel

ABBF	REVIATIONS		
CD	CONDENSATE DRAIN	MV	MIXING VALVE
CONT	CONTINUATION	O/H	OVERHEAD
CW	COLD WATER	G	NATURAL GAS
DN	DOWN	PD	PUMPED DISCHARGE
ET	EXPANSION TANK	PRV	PRESSURE REDUCING VALVE
EWC	ELECTRIC WATER COOLER	RP	RECIRCULATION PUMP
ex.	EXISTING	S, SAN	SANITARY
FCO	FLOOR CLEANOUT	SH	SHOWER
FD	FLOOR DRAIN	SK	SINK
FHB	FREEZEPROOF HOSE BIBB	TP	TRAP PRIMER
FS	FLOOR SINK	TYP	TYPICAL
FRH	FREEZEPROOF ROOF HYDRANT	UR	URINAL
FWH	FREEZEPROOF WALL HYDRANT	V	VENT
GCO	GRADE CLEANOUT	VTR	VENT THROUGH ROOF
GI	GREASE INTERCEPTOR	WC	WATER CLOSET
НВ	HOSE BIBB	W.C.	WATER COLUMN
HD	HUB DRAIN	WCO	WALL CLEANOUT
HWS	HOT WATER SUPPLY	WHA	WATER HAMMER ARRESTER
HWR	HOT WATER RETURN	WMB	WASHING MACHINE BOX

LEGEND	
	COLD WATER PIPE
	HOT WATER PIPE
	HOT WATER RETURN PIPE
—— s——	SANITARY PIPE
	VENT PIPE
——— G ———	NATURAL GAS PIPE
——— GW ———	GREASE WASTE PIPE
o	PIPE UP / PIPE DOWN
——————————————————————————————————————	PIPE TEE FROM TOP / TEE FROM BOTTOM
E	PIPE CAP / PIPE CONTINUATION
	DIRECTIONAL FLOW ARROW
- 5 - -₹ -	BALL VALVE / CHECK VALVE
——————————————————————————————————————	MIXING VALVE / PRESSURE REDUCING VALVE
	FLOOR DRAIN / FLOOR SINK
	WATER HAMMER ARRESTOR
<u>-</u> ×-	GAS COCK / GAS SOLENOID VALVE
œ	P-TRAP
©c	HUB DRAIN
•	FLOOR CLEANOUT / GRADE CLEANOUT
8	VENT THROUGH ROOF
├	PIPE CLEANOUT / WALL CLEANOUT

LEGEND	
SYMBOLS	DESCRIPTION
	DUCT UP
	DUCT UP
	DUCT DOWN
UNIT #	EQUIPMENT TYPE EQUIPMENT NUMBER. WHERE A LETTER IS USED, THERE ARE MULTIPLE INSTANCES

SPECIFICATIONS

IT IS THE CONTRACTOR'S RESPONSIBILITY TO CONTACT THE LOCAL GAS UTILITY PROVIDER TO CONFIRM THE AVAILABILITY OF THE INDICATED DESIGN DELIVERY PRESSURE PRIOR TO COMMENCING WORK.

ALL GAS PIPING SHALL BE INSTALLED IN STRICT ACCORDANCE WITH THE INTERNATIONAL FUEL GAS CODE AND NFPA 54.

IFGC SECTION 402.11.2. PROVIDE MANUFACTURED RISER ASSEMBLY TO TRANSITION FROM TUBING TO ABOVEGROUND METALLIC PIPING.

ABOVE GRADE GAS PIPING SHALL BE SCHEDULE 40 BLACK STEEL (ASTM A53/A53M). FITTINGS SHALL BE ASME B16.3 MALLEABLE IRON OR ASTM A234/A234M WROUGHT STEEL WELDING TYPE. JOINTS SHALL BE THREADED OR WELDED TO ASME B31.1.

BELOW GRADE GAS PIPING SHALL BE FLEXIBLE POLYETHYLENE TUBING AND SHALL COMPLY WITH ASTM D2513 AND CSA B137.4, AND SHALL BE INSTALLED IN ACCORDANCE WITH

SHUTOFF VALVES SHALL BE PROVIDED AND LOCATED IN PLACES SO AS TO PROVIDE ACCESS FOR OPERATION AND SHALL BE INSTALLED SO AS TO BE PROTECTED FROM DAMAGE.

ALL GAS FIRED APPLIANCES ARE PROVIDED WITH A GAS PRESSURE OF 7"W.C. AT FINAL EQUIPMENT CONNECTION. IF 7"W.C. EXCEEDS EQUIPMENT'S SPECIFIC INLET PRESSURE REQUIREMENT, CONTRACTOR SHALL PROVIDE APPROPRIATE PRESSURE REGULATING VALVE.

GAS PIPING ON ROOF SURFACES SHALL BE ELEVATED NO LESS THAN 3½" INCHES ABOVE ROOF SURFACE AND SHALL BE CLAMPED TO RUBBER CHANNEL SUPPORTS (MIFAB C10 SERIES OR EQUAL). PROVIDE SUPPORT AT EVERY ELBOW. THE MAXIMUM SPACING OF SUPPORTS SHALL BE: ½" PIPE: 5'-O", ¾" TO 1½" PIPING: 6'-O", 1½" AND LARGER: 12'-O". VERTICAL PIPING SHALL BE SUPPORTED AT BASE, TOP AND AT 10' INTERVALS (MINIMUM).

ALL EXTERIOR GAS PIPING ON ROOF SHALL BE PRIMED AND PAINTED O.S.H.A. YELLOW. GAS PIPING RUNNING ON EXTERIOR WALLS SHALL BE PRIMED AND PAINTED TO MATCH BUILDING WALL.

EXPOSED GAS PIPING SHALL BE IDENTIFIED BY A YELLOW LABEL MARKED 'GAS' IN BLACK LETTERS. ALL PIPING GREATER THAN 7"W.C. SERVICE PRESSURE SHALL BE IDENTIFIED BY A YELLOW LABEL WITH BLACK LETTERS INDICATING THE PIPING SYSTEM PRESSURE. THE SYSTEM SHALL BE MARKED AT THE BEGINNING, ALL ENDS AND AT INTERVALS NOT EXCEEDING 5 FEET ALONG ITS EXPOSED LENGTH.

BALL VALVES: THREE PIECE BODY, FULL PORT, CHROME PLATED BALL, BLOWOUT PROOF STEM, TFE SEATS, UL LISTED FOR FLAMMABLE LIQUIDS, 600 PSI WOG, THREADED ENDS.

PRESSURE REGULATOR VALVE: SINGLE STAGE AND SUITABLE FOR NATURAL GAS, STEEL JACKET AND CORROSION RESISTANT COMPONENTS, THREADED FOR REGULATORS NPS 2 AND SMALLER. PROVIDE SHUTOFF VALVE IMMEDIATELY AHEAD OF REGULATOR, AND INSTALL TEST PORTS ON EITHER SIDE REGULATOR, WITH UPSTREAM TEST PORT DOWNSTREAM OF

SHUTOFF VALVE. REGULATORS SHALL BE INSTALLED PER IFGC SECTION 410. FOR 2PSI INLET, PROVIDE MAXITROL '325-L' SERIES. PROVIDE VENT PROTECTOR FOR EXTERIOR APPLICATIONS. FOR INTERIOR APPLICATIONS, VENT SHALL BE PIPED TO THE EXTERIOR WITH TURNDOWN AND SCREEN PROTECTOR (REGULATOR EQUIPPED WITH FACTORY PROVIDED VENT LIMITER IS ACCEPTABLE WHERE APPROVED BY THE LOCAL JURISDICTION).

SHUTOFF VALVES SHALL BE PROVIDED IN ACCORDANCE WITH IFGC 409. INSTALL MANUAL GAS SHUTOFF VALVE FOR EACH GAS APPLIANCE AHEAD OF CORRUGATED STAINLESS STEEL TUBING OR COPPER CONNECTOR. SHUTOFF SHALL BE WITHIN 6' OF APPLIANCE.

INSTALL UNIONS IN PIPES NPS 2 AND SMALLER, ADJACENT TO EACH VALVE, AT FINAL CONNECTION TO EACH PIECE OF EQUIPMENT.

ALL GAS PIPING INSTALLED BENEATH THE BUILDING SLAB SHALL BE ENCASED IN WROUGHT IRON CONDUIT. PIPING SHALL BE PROTECTED AND INSTALLED ACCORDING TO THE INTERNATIONAL FUEL GAS CODE SECTION 404.14.

TANK TYPE WATER HEATERS

WATER HEATERS SHALL BE U.L. LISTED AND SHALL MEET OR EXCEED THE STANDBY LOSS REQUIREMENTS OF U.S. DEPT. OF ENERGY AND CURRENT EDITION OF ASHRAE/IESNA 90.1.

WATER HEATERS SHALL HAVE 150PSI WORKING PRESSURE AND BE EQUIPPED WITH EXTRUDED HIGH DENSITY ANODE ROD AND HIGH TEMPERATURE CUTOFF SWITCH. WATER HEATERS SHALL BE THERMOSTATICALLY CONTROLLED AND SET TO 120° UNLESS OTHERWISE NOTED. WATER HEATERS SHALL BE INSTALLED ON SUSPENDED PLATFORM, STEEL STAND OR CONCRETE PAD, AS INDICATED ON DRAWINGS.

WATER HEATERS SHALL HAVE A MINIMUM 3 YEAR LIMITED WARRANTY.

WATER HEATERS SHALL BE INSTALLED LEVEL AND PLUMB. FIELD COORDINATE EXACT WATER HEATER LOCATION. MAINTAIN MANUFACTURER'S RECOMMENDED CLEARANCES, AND INSTALL SUCH THAT CONTROLS AND DEVICES ARE ACCESSIBLE FOR SERVICING.

INSTALL SHUTOFF VALVES IN COLD WATER INLET AND HOT WATER OUTLET. INSTALL THERMOMETER ON HOT WATER OUTLET. WATER HEATER SHALL HAVE ASME RATED COMBINATION TEMPERATURE AND PRESSURE RELIEF VALVE IN TOP PORTION OF TANK (FACTORY OR FIELD INSTALLED). PIPE RELIEF VALVE OUTLET TO FLOOR DRAIN, MOP SINK, INDIRECT WASTE RECEPTOR OR TO EXTERIOR. MAINTAIN CONTINUOUS DOWNWARD PITCH TOWARD DISCHARGE LOCATION, AND PROVIDE AIR GAP AT DISCHARGE LOCATION. WHERE WATER HEATER DRAIN PAN IS INDICATED ON PLANS, ROUTE DRAIN TO SAME LOCATION AS RELIEF VALVE AND DISCHARGE WITH AIR GAP.

HANGERS SHALL BE COMPLETE WITH RODS AND SUPPORTS PROPORTIONED TO THE SIZE OF PIPE TO BE SUPPORTED, IN ACCORDANCE WITH THE MANUFACTURER'S RECOMMENDATIONS.

SIZE HANGERS FOR INSULATED PIPING TO BEAR ON OUTSIDE OF INSULATION. PROVIDE INSULATION PROTECTORS AT HANGERS BEARING ON THE OUTSIDE OF INSULATION. PROVIDE A RIGID INSERT OR RIGID INSULATION AT EACH INSULATION PROTECTOR.

WHERE SEVERAL PIPES 2½" AND SMALLER RUN PARALLEL AND IN THE SAME PLANE, THEY MAY BE SUPPORTED ON GANG OR MULTIPLE HANGERS. LARGER PIPING SHALL BE INDEPENDENTLY HUNG, RUN PARALLEL AND BE EQUALLY SPACED.

PIPING SHALL BE SUPPORTED IN ACCORDANCE WITH IPC SECTION 308, AND SPACING OF HANGERS SHALL NOT EXCEED THE LIMITS SET FORTH IN TABLE 308.5. PIPES SHALL BE SUPPORTED WITHIN 1'-0" OF FACH FI BOW.

VERTICAL PIPE SUBJECT TO MOVEMENT SHALL BE SUPPORTED FROM THE WALL BY MEANS OF A PIPE CLAMP.

SUPPORT DOMESTIC WATER PIPING IN SPACES BEHIND PLUMBING FIXTURES BY BRACKETS AND U-BOLTS SECURED TO WASTE AND VENT STACKS. SIZE U-BOLTS TO BEAR ON THE

AFTER HANGER RODS ARE INSTALLED IN FINISHED CONCRETE CEILING, FILL THE REMAINING OPENING WITH CEMENT SO THAT NO HOLE SHOWS AT THE CEILING.

WHERE COPPER PIPING IS USED, NONFERROUS METAL SUPPORT(S) OR PROPER ISOLATION BETWEEN DISSIMILAR MATERIALS SHALL BE PROVIDED.

PIPE HANGERS AND SUPPORTS SHALL BE FURNISHED AND INSTALLED IN ACCORDANCE WITH RECOMMENDATIONS SET FORTH IN MANUFACTURER'S STANDARDIZATION SOCIETY STANDARD PRACTICES NO. SP-69 AND SP-58.

SLEEVES
SLEEVES SHALL BE PROVIDED WHERE PIPES PASS THROUGH WALLS, FLOORS AND ROOFS.
PROVIDE STANDARD WEIGHT STEEL SLEEVES IN CONCRETE AND MASONRY CONSTRUCTION, PROVIDE 26GA GALVANIZED SHEET METAL SLEEVES IN INTERIOR DRYWALL CONSTRUCTION. SLEEVES SHALL BE THE FULL THICKNESS OF WALLS AND SHALL ALLOW FOR THE FULL THICKNESS OF PIPE INSULATION, WHERE APPLICABLE.

SLEEVES MAY BE OMITTED WHEN OPENINGS ARE CORE DRILLED FOR CONCEALED VERTICAL AND HORIZONTAL PIPING. SLEEVES ARE NOT REQUIRED AT INDIVIDUAL PLUMBING FIXTURES OR IN CONCRETE FLOOR SLABS ON GRADE, UNLESS OTHERWISE NOTED.

SLEEVES FOR ALL PIPING PENETRATING FIRE RATED WALLS AND FLOORS SHALL BE PROVIDED WITH 3M PIPE BARRIER NO. CP-25 FIRE PROOFING CAULKING, OR EQUAL, IN ANNULAR SPACE BETWEEN SLEEVE AND PIPING. CONTRACTOR SHALL VERIFY THE RATING OF THE WALL AND CONFIRM THE PENETRATION PROTECTION PROVIDED MEETS THAT RATING.

PENETRATIONS THROUGH OUTSIDE WALLS SHALL BE WATERTIGHT. CAULK BETWEEN PLUMBING PIPE AND SLEEVE. PACK WITH FIBERGLASS AND CAULK, 1" DEEP AT EACH FACE WITH NON-HARDENING SEALANT BETWEEN PIPE AND SLEEVE.

WASTE AND VENT PIPING SYSTEMS AND ACCESSORIES

SANITARY PIPING SHALL BE PVC SCHEDULE 40 SOLID WALL PIPE AND DWV FITTING SYSTEM.

PIPE AND FITTINGS SHALL BE MANUFACTURED FROM PVC COMPOUND WITH A CELL CLASS OF 12454 PER ASTM D-1784 AND CONFORM WITH NATIONAL SANITATION FOUNDATION (NSF) STANDARD 14. PIPE SHALL BE IRON PIPE SIZE (IPS) CONFORMING TO ASTM D-1785 AND ASTM D-2665. INJECTION MOLDED FITTINGS SHALL CONFORM TO ASTM F-1866. SOLVENT CEMENTS SHALL CONFORM TO ASTM D-2564. PRIMER SHALL CONFORM TO ASTM F-656. BURIED PIPE SHALL CONFORM TO ASTM D-2321.

WASTE AND VENT PIPING SHALL BE TESTED IN ACCORDANCE WITH THE GOVERNING CODES. AT A MINIMUM, WASTE PIPING SHALL BE TESTED WITH AT LEAST 10 FOOT OF WATER HEAD PRESSURE APPLIED.

ALL VENTS THROUGH ROOF SHALL BE LOCATED AT LEAST 10'-0" AWAY FROM ANY AIR INTAKE, EVAPORATIVE COOLER, OR ANY OTHER DEVICE THAT WOULD DRAW AIR FROM THE VENT. FLASH AROUND ALL PIPES PENETRATING THROUGH ROOF WITH STANDARD MANUFACTURED FLASHINGS. FLASHING SHALL BE SHEET METAL WITH RUBBER GASKETS AND SHALL EXTEND INTO ROOFING AND UP PIPE DISTANCES IN ACCORDANCE WITH THE LOCAL CODE.

NO DOUBLE COMBINATION FITTINGS MAY BE UTILIZED IN THE HORIZONTAL.

WHERE TWO HORIZONTAL PIPES (BACK-TO-BACK WATER CLOSETS OR TWO SANITARY BRANCHES) COMBINE IN THE VERTICAL, A DOUBLE COMBINATION WYE EIGHTH BEND FITTING SHALL BE INSTALLED. DOUBLE SANITARY TEE OR SANITARY CROSS IS NOT ACCEPTABLE.

WHERE DRAWINGS REQUIRE CONNECTION TO EXISTING SANITARY SEWER PIPING IN BUILDING, IT IS THE CONTRACTOR'S RESPONSIBILITY TO FIELD DETERMINE EXACT LOCATION, DEPTH AND DIRECTION OF FLOW PRIOR TO COMMENCING WORK. CONTRACTOR SHALL ALERT ARCHITECT/ENGINEER IF THERE IS A POTENTIAL ISSUE MAINTAINING PROPER SLOPE IN CONNECTING TO EXISTING, OR IF THERE IS A MORE DIRECT CONNECTION POSSIBLE. CONTRACTOR SHALL CONFIRM THAT ANY EXISTING PIPING TO BE REUSED IS CLEAN, FREE OF DEFECTS, ADEQUATELY SLOPED (8"/FT MINIMUM) AND THAT THERE ARE NO DIPS THAT COULD HOLD WATER. PROVIDE CAMERA SCOPING TO DOCUMENT THIS INFORMATION. CONTRACTOR SHALL ALERT ARCHITECT/ENGINEER OF ANY DEFICIENCIES.

DOMESTIC WATER SYSTEMS AND ACCESSORIES
WATER PIPING ABOVE SLAB: TYPE 'L' HARD DRAWN COPPER TUBING, ASTM B88, WROUGHT SOLDER JOINTS, ANSI B16.22.

WATER PIPING BELOW SLAB: TYPE 'K' SOFT DRAWN COPPER TUBING, WITH NO JOINTS BELOW SLAB, ASTM B88.

ALL DOMESTIC HOT WATER PIPING SHALL HAVE A MINIMUM PRESSURE RATING OF 100PSI AT 180°F.

DOMESTIC WATER PIPING SHALL BE TESTED IN ACCORDANCE WITH ALL GOVERNING CODES. PIPING SHALL BE PURGED OF DELETERIOUS MATTER AND DISINFECTED PRIOR TO UTILIZATION. PIPING TO BE FLUSHED AND STERILIZED IN ACCORDANCE WITH IPC 610.1 AND ALL APPLICABLE LOCAL AND STATE HEALTH DEPARTMENT STANDARDS.

BALL VALVES SHALL BE TWO-PIECE BRONZE BODY, LARGE PORT WITH SOLID, SMOOTH BORE CHROME PLATED BRASS BALL. SEATS SHALL BE REINFORCED TFE WITH TEFLON PACKING RING AND THREADED ADJUSTABLE PACKING NUT. PROVIDE STEM EXTENSION AS NEEDED TO PROVIDE HANDLE ON OUTSIDE OF PIPE INSULATION. VALVES SHALL BE APOLLO 70 OR EQUAL.

BACKFLOW PREVENTERS SHALL BE INSTALLED IN ACCESSIBLE LOCATIONS FOR EASE OF TESTING AND SERVICING. FOR BACKFLOW PREVENTERS WITH VENT CONNECTIONS, ROUTE VENT LINE TO NEAREST DRAIN AND DISCHARGE WITH AIR GAP. BACKFLOW PREVENTERS SHALL BE TESTED IN ACCORDANCE WITH IPC 312.10.2. CONTRACTOR SHALL PROVIDE CERTIFICATIONS THAT STATE DEVICES HAVE BEEN TESTED AND APPROVED.

THERMOMETERS SHALL BE 9" ADJUSTABLE ANGLE, 30°-180°F RANGE (TRERICE BX9 OR EQUAL). PRESSURE GAUGES SHALL BE 4½" DIAL SIZE, 0-160PSI (TRERICE 600CB OR EQUAL). CONTRACTOR SHALL FIELD VERIFY INCOMING DOMESTIC WATER PRESSURE TO CONFIRM ADEQUATE PRESSURE TO SERVE THE DOMESTIC WATER SYSTEM. CONTRACTOR SHALL ALERT ENGINEER TO A POTENTIAL LOW PRESSURE CONDITION. WHERE PRESSURE EXCEEDS 80PSI, PROVIDE PRESSURE REGULATING VALVE (WATTS LF223) AND UPSTREAM STRAINER (WATTS LSF777).

CONTRACTOR SHALL FIELD COORDINATE LOCATION OF ACCESSIBLE ISOLATION VALVES ON DOMESTIC HOT & COLD WATER SUPPLIES TO FIXTURES OR GROUPS OF FIXTURES SUCH THAT THEY MAY BE SHUT OFF FOR SERVICING. SERVICE AND HOSE BIBB VALVES SHALL BE IDENTIFIED. ALL OTHER VALVES INSTALLED IN LOCATIONS THAT ARE NOT ADJACENT TO THE FIXTURE(S) SHALL BE IDENTIFIED, INDICATING THE FIXTURE(S) SERVED.

INSULATE ALL DOMESTIC HOT WATER AND HOT WATER RECIRCULATION PIPING IN ACCORDANCE WITH IECC TABLE C403.2.10. PIPE UP TO 1½": 1" THICK INSULATION. PIPE 1½" OR LARGER: 1½" THICK INSULATION

INSULATE ALL HORIZONTAL COLD WATER PIPING LOCATED ABOVE CEILING, VERTICAL PIPING LOCATED IN AN EXTERIOR WALL, EXPOSED PIPING (I.E. MECH ROOMS). PIPE UP TO 1": ½" THICK. PIPING 1½" AND OVER: 1" THICK INSULATION. ALL WATER AND DRAINAGE PIPING INSTALLED IN EXTERIOR WALLS SHALL BE WRAPPED IN 1" THICK PIPE INSULATION AND BE LOCATED ON THE INTERIOR SIDE OF THE BUILDING INSULATION. IF INSTALLED IN EXTERIOR BLOCK WALLS, INTERSTITIAL SPACES SHALL BE FILLED WITH FOAM INSULATION.

ALL JOINTS SHALL BE SEALED WITH MATCHING VAPOR BARRIER TAPE.

INSULATION SHALL HAVE A K-FACTOR (AVERAGE THERMAL CONDUCTIVITY) NOT TO EXCEED 0.27 BTU-IN/HR x SQFT x $^{\circ}$ F.

PIPING PASSING UNDER FOOTINGS OR THROUGH FOUNDATION WALLS SHALL BE PROVIDED WITH A SLEEVE TWICE THE DIAMETER OF THE PIPE. OPEN ENDS OF SLEEVES SHALL BE SEALED. PIPING PASSING THROUGH CONCRETE OR CINDER WALLS AND FLOORS OR OTHER CORROSIVE MATERIAL SHALL BE PROTECTED IN ACCORDANCE WITH IPC 305.1. ALL PIPING INSTALLED THROUGH HOLES OR NOTCHES IN STUDS, JOISTS, RAFTERS OR SIMILAR MEMBERS SHALL BE PROTECTED BY STEEL SHIELD PLATES IN ACCORDANCE WITH IPC 305.6. VERTICAL STACKS IN WOOD CONSTRUCTION SHALL BE PROTECTED FROM BUILDING SETTLING WITH COMPRESSION/EXPANSION FITTINGS AND PIPE CLAMPS INSTALLED PER MANUFACTURER'S RECOMMENDATIONS (FERNCO XJ SERIES OR EQUAL).

SPECIFICATIONS

APPLICABLE CODES:

GENERAL NOTES:

INTERNATIONAL FIRE CODE (IFC), 2018 EDITION

2020 IPC CO AMENDMENTS

2020 IFC CO AMENDMENTS
INTERNATIONAL PLUMBING CODE (IPC), 2018 EDITION

INTERNATIONAL MECHANICAL CODE (IMC), 2018 EDITION 2020 IMC CO AMENDMENTS

INTERNATIONAL FUEL GAS CODE (IFGC), 2018 EDITION

2020 IFGC CO AMENDMENTS
INTERNATIONAL ENERGY CONSERVATION CODE (IECC), 2018 EDITION

2020 SUPPLEMENTS AND AMENDMENTS

REFER TO ARCHITECTURAL REFLECTED CEILING PLANS FOR EXACT LOCATION OF ALL CEILING MOUNTED EQUIPMENT.

ALL DUCT DIMENSIONS INDICATED IN THESE DOCUMENTS ARE INSIDE-CLEAR DIMENSIONS.

PORTIONS OF DUCTWORK OR PIPING VISIBLE THROUGH GRILLES AND REGISTERS IN FINISHED

AREAS SHALL BE PAINTED FLAT BLACK. PAINT BLACK BEHIND ALL GRILLES.

ALL WIRING IN THE CEILING PLENUM SHALL BE PLENUM RATED CABLE.

MOUNTING FRAME OF CEILING MOUNTED AIR DISTRIBUTION DEVICES SHALL BE COMPATIBLE WITH CEILING TYPE. REFER TO ARCHITECTURAL DRAWINGS FOR CEILING TYPE.

ALL FIRE SEPARATIONS MUST BE PROTECTED WHEN APPLICABLE.

PROVIDE NEW FILTERS (MERV 7 OR BETTER PER OWNER) FOR ALL APPLICABLE HVAC EQUIPMENT AT THE END OF CONSTRUCTION.

ALL MATERIAL IN PLENUM MUST MEET FIRE AND SMOKE SPREAD AS REQUIRED BY NFPA 90A.

ALL ROOF PENETRATIONS TO BE 12" APART AND AT LEAST 12" AWAY FROM CURBS, WALLS, AND DRAIN SUMPS TO PROVIDE ROOFING CONTRACTOR WITH SUFFICIENT ACCESS FOR

SUBSTITUTIONS MUST BE APPROVED IN WRITING BY ARCHITECT PRIOR TO BID SUBMISSION.

CONTRACTOR SHALL REVIEW ALL CONTRACT DOCUMENTS AND SHALL BE FAMILIAR WITH THE SCOPE AND REQUIREMENTS OF THIS PROJECT. ANY DISCREPANCIES OR LACK OF CLARITY IN THE DOCUMENTS SHALL BE IDENTIFIED TO THE ARCHITECT OR ENGINEER PRIOR TO THE SUBMISSION OF PRICING BIDS. WITH A SUBMITTED BID, CONTRACTOR IS ACCEPTING THESE DOCUMENTS AS SUFFICIENT DEFINITION OF THE SCOPE OF WORK, AND ANY ADDITIONAL COSTS BASED ON UNCLARITY OF CONTRACT DOCUMENTS WILL NOT BE CONSIDERED.

THE CONTRACTOR SHALL REFERENCE THE FULL SET OF CONSTRUCTION DOCUMENTS DURING PRICING AND CONSTRUCTION FOR COORDINATION BETWEEN DISCIPLINES RELATIVE TO THE MECHANICAL SCOPE.

EXISTING CONDITIONS:

FLASHING EACH ROOF PENETRATION.

CONTRACTOR SHALL VISIT THE SITE AND UNDERSTAND JOB CONDITIONS BEFORE SUBMITTING A PROPOSAL. IT SHALL BE THE CONTRACTOR'S RESPONSIBILITY TO VERIFY LOCATIONS AND SIZES OF ALL EXISTING UTILITY SERVICES PRIOR TO SUBMITTING HIS PROPOSAL. NO CONSIDERATION WILL BE GIVEN TO CLAIMS FOR EXTRA COST ARISING FROM CONTRACTOR'S FAILURE TO BE FULLY COGNIZANT OF JOB OR SITE CONDITIONS EXISTING AT TIME OF ACCEPTANCE OF BID.

ACTIVE SERVICES: WHEN ENCOUNTERED IN WORK, PROTECT, BRACE, SUPPORT EXISTING ACTIVE SEWERS, GAS AND OTHER SERVICES REQUIRED FOR PROPER EXECUTION OF WORK. IF EXISTING ACTIVE SERVICES ARE ENCOUNTERED THAT REQUIRE RELOCATION, RELOCATE AS APPROVED. DO NOT PREVENT OR DISTURB OPERATION OF ACTIVE SERVICES THAT ARE TO REMAIN

INACTIVE SERVICES: WHEN ENCOUNTERED IN WORK, REMOVE, CAP OR PLUG INACTIVE SERVICES, AS INDICATED.

INTERRUPTION OF SERVICES: WHERE WORK MAKES TEMPORARY SHUT-DOWNS OF SERVICES UNAVOIDABLE, SHUT DOWN AT NIGHT, OR AT SUCH TIMES AS APPROVED BY OWNER, WHICH WILL CAUSE LEAST INTERFERENCE WITH ESTABLISHED OPERATING ROUTINE. ARRANGE WORK TO ASSURE THAT SERVICES WILL BE SHUT DOWN ONLY DURING TIME ACTUALLY REQUIRED TO MAKE NECESSARY CONNECTION TO EXISTING WORK.

WHERE EXISTING WALLS, CEILINGS, FLOORS, ETC., ARE CUT OR OTHERWISE DAMAGED DURING CONSTRUCTION, REPAIR ALL SURFACES TO THEIR ORIGINAL CONDITION.

SHOP DRAWINGS:

SUBMIT SHOP DRAWINGS FOR REVIEW. PDF FILES PREFERRED. SHOP DRAWINGS SHALL BE BOUND INTO VOLUMES (FILES), WITH EACH VOLUME (FILE) CONTAINING ONE COPY OF ALL SHOP DRAWINGS. ALL SHOP DRAWINGS SHALL BE SUBMITTED SIMULTANEOUSLY; NO SHOP DRAWINGS WILL BE CHECKED UNTIL ALL HAVE BEEN SUBMITTED.

SUBMITTALS SHALL BE SUPPORTED BY DESCRIPTIVE MATERIAL, SUCH AS CATALOG CUTS, DIAGRAMS, PERFORMANCE CURVES AND CHARTS PUBLISHED BY THE MANUFACTURER, TO SHOW CONFORMANCE TO SPECIFICATION AND DRAWING REQUIREMENTS; MODEL NUMBERS ALONE WILL NOT BE ACCEPTABLE. ALL LITERATURE SHALL CLEARLY INDICATE THE SPECIFIED MODEL NUMBER, DIMENSIONS, ARRANGEMENT, RATING AND CHARACTERISTICS OF THE PROPOSED EQUIPMENT. CAPACITIES AND RATINGS SHALL BE BASED ON CONDITIONS INDICATED OR SPECIFIED HEREIN. ANY DEVIATIONS FROM SPECIFIED EQUIPMENT (PARTICULARLY THOSE WHICH REQUIRE COORDINATION WITH OTHER TRADES) SHALL BE CLEARLY NOTED IN A CONCISE LIST ON A SEPARATE SHEET.

TEST AND BALANCE

TEST AND BALANCE (TAB) CONTRACTOR SHALL HOLD A CURRENT NATIONAL BALANCING COUNCIL (NBC) CERTIFICATION AND POSSESS ACCURATE AND CALIBRATED INSTRUMENTS. TAB WORK AND REPORTS SHALL BE PER NBC PRACTICAL STANDARDS, PROCEDURES AND FORMS. ACCEPTIBLE ALTERNATIVE TAB FIRM CERTIFICATIONS/PROCEDURES: NEBB, AABC, OR

PRIOR TO COMMENCEMENT OF THE TAB WORK, THE MECHANICAL SYSTEMS ARE TO BE STARTED AND FULLY FUNCTIONING. A CHECKLIST PRIOR TAB WORK IS TO BE SENT TO THE INSTALLING CONTRACTOR AND RETURNED ATTESTING TO THE READINESS OF THE SYSTEMS FOR BALANCING.

PREFERRED TAB FIRM: P-TAB.COM

GUARANTEE:

GUARANTEE THAT EACH PIECE OF APPARATUS SHALL BE OF THE CUSTOMARY STANDARD AND QUALITY FURNISHED BY THE DESIGNED MANUFACTURER FOR THAT CATALOG NUMBER.

GUARANTEE THAT THE AIR SYSTEMS SHALL OPERATE WITHOUT AERODYNAMIC NOISE GENERATED FROM THE FAULTY INSTALLATION OF DUCT WORK OR ANY COMPONENT OF THE AIR DISTRIBUTION SYSTEM.

GUARANTEE THAT ALL SYSTEMS AND COMPONENTS SHALL BE PROVIDED WITH A ONE YEAR WARRANTY FROM THE TIME OF DATE OF SUBSTANTIAL COMPLETION. THE WARRANTY SHALL COVER ALL MATERIALS AND WORKMANSHIP. DURING THIS WARRANTY PERIOD, ALL DEFECTS IN MATERIALS AND WORKMANSHIP SHALL BE CORRECTED BY REPAIR OR REPLACEMENT WITHOUT INCURRING ADDITIONS TO THE CONTRACT.

SNOW MELT BOILER WATER PIPING:

CONDENSER WATER PIPING SHALL BE SCHEDULE 40 STEEL PIPE; GROOVED, MECHANICAL JOINT COUPLING AND FITTINGS; AND GROOVED MECHANICAL JOINTS.

SNOW MELT BOILER WATER PIPING INSULATION:

CONDENSER WATER PIPING SHALL BE INSULATED WITH 1-1/2" CELLULAR GLASS WITH ALL SERVICE JACKET (ASJ) OR 1-1/2" MINERAL FIBER PREFORMED PIPE, TYPE i, WITH ASJ.

TOWN STAMP





WARM SPRINGS
TOWNHOMES

 REVISION

 No.
 Description
 Date

 1
 Design Review Resubmission
 11/5/2024

 2
 Design Review Resubmission
 3/14/2025

 3
 Design Review Resubmission
 6/25/2025

 Resubmission
 PROJECT NUMBER
 324050

 ISSUE DATE
 7/10/2024


DESIGN REVIEW APPLICATION

SHEET TITLE

GENERAL

SHEET NO.

MO.1

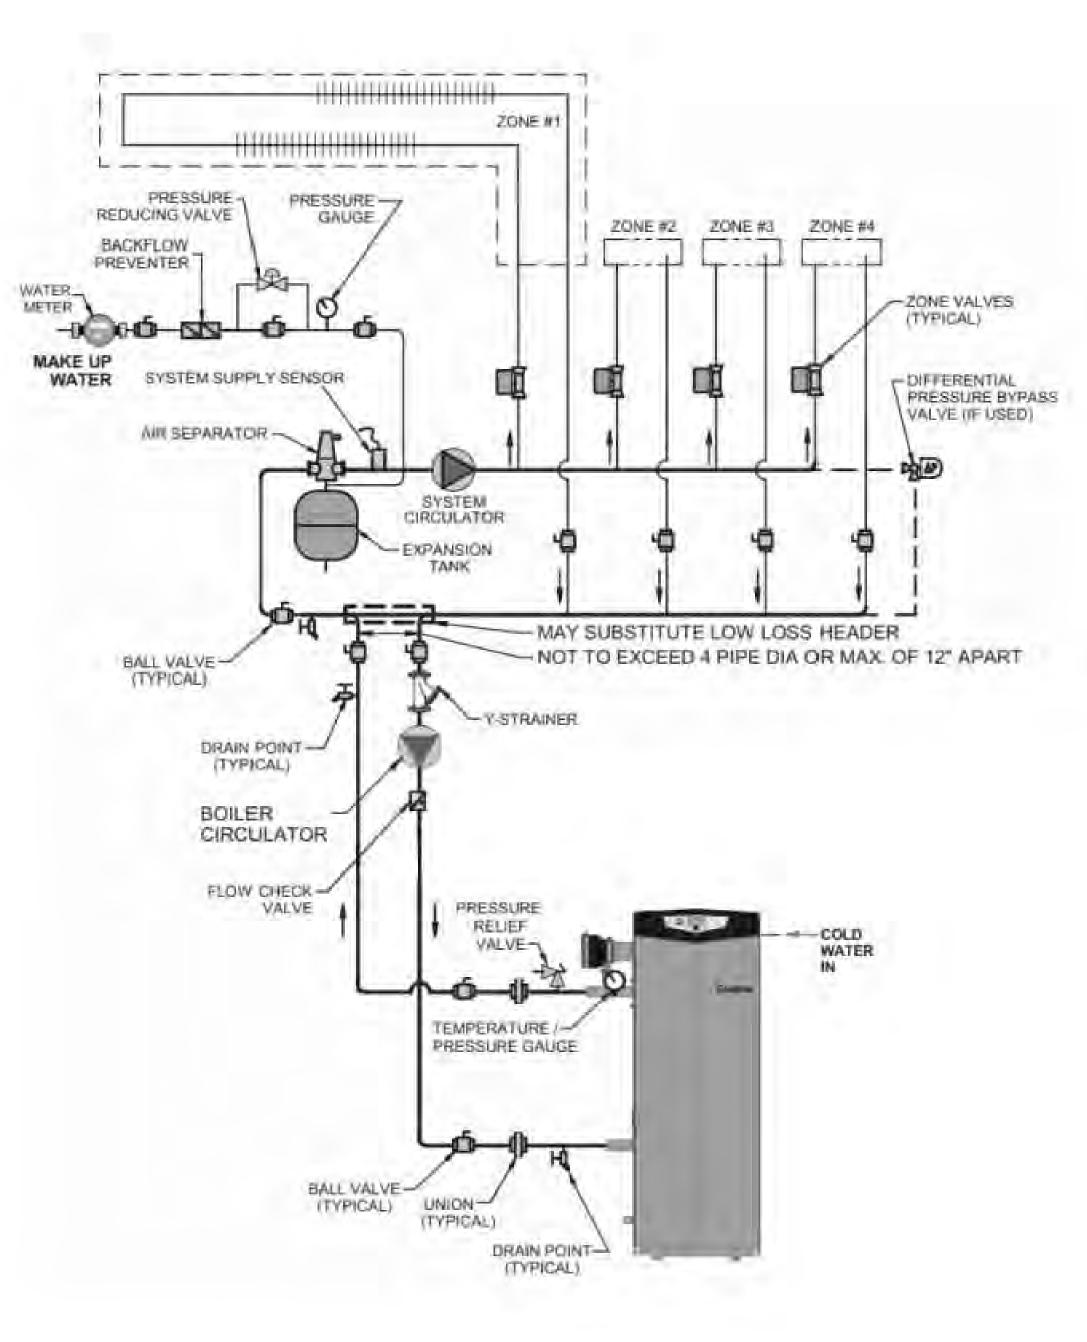

BOILER INSTALLATION DETAIL
NO SCALE

HOT WATER BOILER

				WATER		HEA	ATER		THERMAL	OPERATING					PEN /	ARKS			
MARK	SERVES	BASIS OF DESIGN	GPM	EWT	LWT	INPUT	OUTPUT	TURN DOWN	EFFICIENCY	1					I/LIVII				
			97 101	(ºF)	(ºF)	(MBH)	(MBH)		(%)	(LBS)	-	2	3	4	5	6	7	8	ć
B-1	BUILDING B RAMP	FB1751	145.0	40	121	1,751.0	1,684.0	25:1	96.2	250	Х	X	X	Х	X	X	X	X)

NOTES:

- A. SELECTIONS ARE BASED ON LOCHINVAR. EQUAL
- PRODUCTS BY AERCO, PATTERSON KELLEY, HYDROTHERM.
- B. SEE ELECTRICAL DRAWINGS FOR ELECTRICAL POWER INFORMATION.

C. THERMAL EFFICIENCY IS BASED ON AHRI EFFICIENCY 80°F TO 180°F .

REMARKS:

- 1. SINGLE POINT POWER CONNECTION.
- 2. DISCONNECT SWITCH PROVIDED BY THE ELECTRICAL SUBCONTRACTOR.
- 3. FACTORY PROVIDED MULTI-BOILER CONTROL SYSTEM.
- 4. OUTDOOR AIR RESET.
- 5. BAS INTERFACE (BACNET).
- 6. DIRECT VENT SEALED COMBUSTION CONFIGURATION.7. CONCENTRIC VENT KIT.
- 8. HIGH \$ LOW GAS PRESSURE SWITCHES WITH MANUAL RESET.
- 9. 50%-50% PROPYLENE GLYCOL AND WATER SOLUTION. PROVIDE ADVANTAGE
- CONTROLS 55 GALLON E-GLYCOL FEEDER. INSTALL PER MANUFACTURER'S INSTRUCTIONS. PROVIDE WITH BAS INTERFACE (BACNFT).

PUMP SCHEDULE

					IMPELLER	MAX		PUMP	PUMP	OPERATING	BASIS	REMARKS		PKS.		
MARK	SERVICE / DUTY	TYPE	GPM	HEAD	DIAMETER	NPSHR	MOTOR	SPEED	EEF	WEIGHT	OF DESIGN		1	(L. V / \	.11(3)	
				(FT)	(IN)	(PSI)	(HP)	(RPM)	(%)	(LBS)	MODEL	1 2	2 3	4	5 6	7 8
P-IA	B-4: PRIMARY LOOP	ECM HIGH-EFFICIENCY	145	11.000	1 O"	4.35	2.1	4760	36	52	TACO VR25MSF	X	×	X	XX	XX
P-1B	B-4: SECONDARY LOOP	ECM HIGH-EFFICIENCY	l 45	13.900	1 O"	4.4	50	4400	63	72	TACO SKV3009D	X	x x	X	XX	XX

NOTES (APPLY TO ALL):

- A. SEE ELECTRICAL DRAWINGS FOR ELECTRICAL POWER INFORMATION
- B. BASIS OF DESIGN: TACO AND GRUNDFOS
- ACCEPTABLE ALTERNATES: BELL & GOSSETT, ARMSTRONG, AURORA.

REMARKS: 1 . FLEXIBLE COUPLING.


- 2. DISCONNECT SWITCH BY THE ELECTRICAL SUBCONTRACTOR.
- 3. SUCTION DIFFUSER WITH INTEGRAL STRAINER.
- 4. INVERTER DUTY MOTOR WITH VFD. VFD PROVIDED BY THE ELECTRICAL SUBCONTRACTOR.
- 5. DDC CONTROL. INTERLOCK WITH BAS.
- 6. FIELD INSTALLED DIEFERENTIAL PRESSURE SENSOR AT MOST CRICITAL POINT.
- 7. PUMP \$ INERTIA BASE MOUNTED ON CONCRETE HOUSEKEEPING PAD PROVIDED BY OTHERS.

8. PUMP IS PROVIDED WITH BOILER AND IS SHOWN FOR REFERENCE ONLY

MANIFOLD SCHEDULE

				REQUIRED	SUPPLIED	MANIFOLD	MANIFOLD	CIRCUIT	S/R	TOTAL
MARK	BOILER	CIRCUITS	GPM	TEMP	TEMP	TYPE	HEAD LOSS	HEAD LOSS	HEAD LOSS	HEAD LOSS
				(°F)	(°F)	(FT)	(FT)	(FT)	(FT)	(FT)
MANIFOLD I	B- I	6	14.17	115	121	PRO-BALANCE 1-1/4" STAINLESS STEEL MANIFOLD WITH GAUGES	5.2	10.2	0	15
MANIFOLD 2	B- I	5	10.98	116	121	PRO-BALANCE 1-1/4" STAINLESS STEEL MANIFOLD WITH GAUGES	3.9	10.1	0	14
MANIFOLD 3	B- !	12	31.36	115	121	PRO-BALANCE 1-1/4" STAINLESS STEEL MANIFOLD WITH GAUGES	13.9	13.6	0	28
MANIFOLD 4	B- !	4	10.48	116	121	PRO-BALANCE 1-1/4" STAINLESS STEEL MANIFOLD WITH GAUGES	5.1	13.0	0	18
MANIFOLD 5	B- !	11	26.83	117	121	PRO-BALANCE 1-1/4" STAINLESS STEEL MANIFOLD WITH GAUGES	10.7	14.2	0	25
MANIFOLD 6	B-!	7	17.80	116	121	PRO-BALANCE 1-1/4" STAINLESS STEEL MANIFOLD WITH GAUGES	6.7	14.1	0	21
MANIFOLD 7	B- !	1	1.90	112	121	PRO-BALANCE 1-1/4" STAINLESS STEEL MANIFOLD WITH GAUGES	2.7	7.5	0	10
MANIFOLD 8	B- !	2	3.01	123	121	PRO-BALANCE 1-1/4" STAINLESS STEEL MANIFOLD WITH GAUGES	1.9	3.9	0	6
MANIFOLD 9	B- I	8	18.81	115	121	PRO-BALANCE 1-1/4" STAINLESS STEEL MANIFOLD WITH GAUGES	6.0	13.0	0	19
MANIFOLD 10	B- I	4	6.59	117	121	PRO-BALANCE 1-1/4" STAINLESS STEEL MANIFOLD WITH GAUGES	2.0	4.3	0	6
MANIFOLD	B- !	2	2.56	117	121	PRO-BALANCE 1-1/4" STAINLESS STEEL MANIFOLD WITH GAUGES	2.7	9.5	0	12


NOTES (APPLY TO ALL):

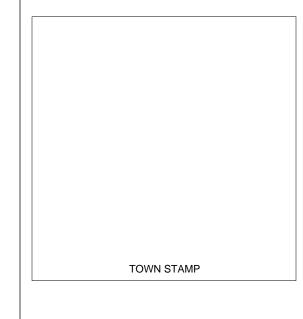





WARM SPRINGS
TOWNHOMES
108 RITCHIE DRIVE

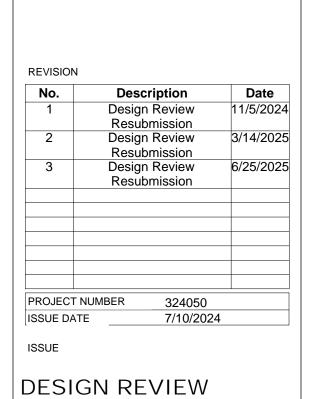

APPLICATION


SCHEDULES & DETAILS


SHEET NO.

SHEET TITLE

MO.2

A. REFER TO SNOW MELT SYSTEM LOOP DRAWINGS FOR MORE INFORMATION

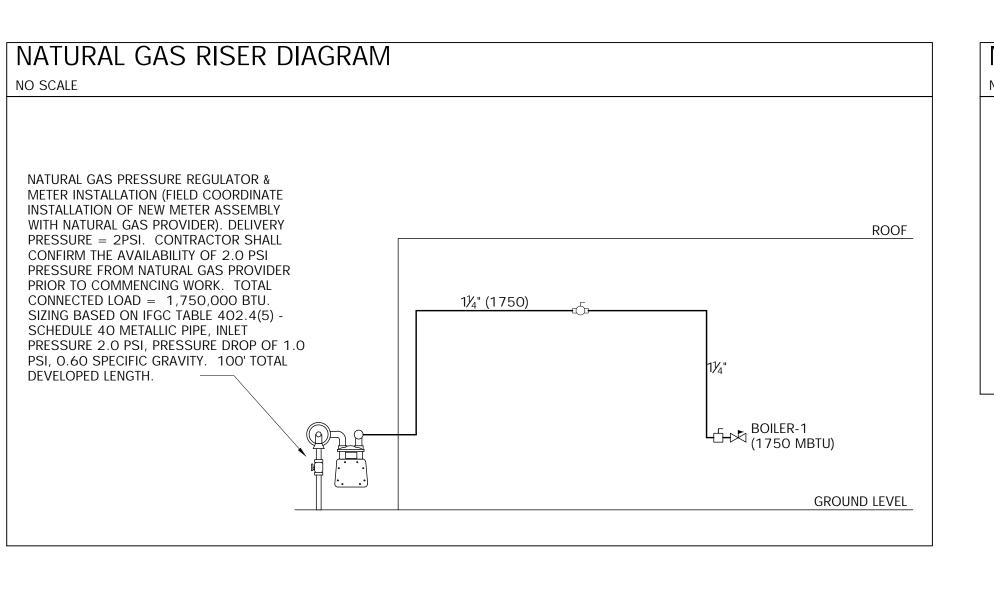

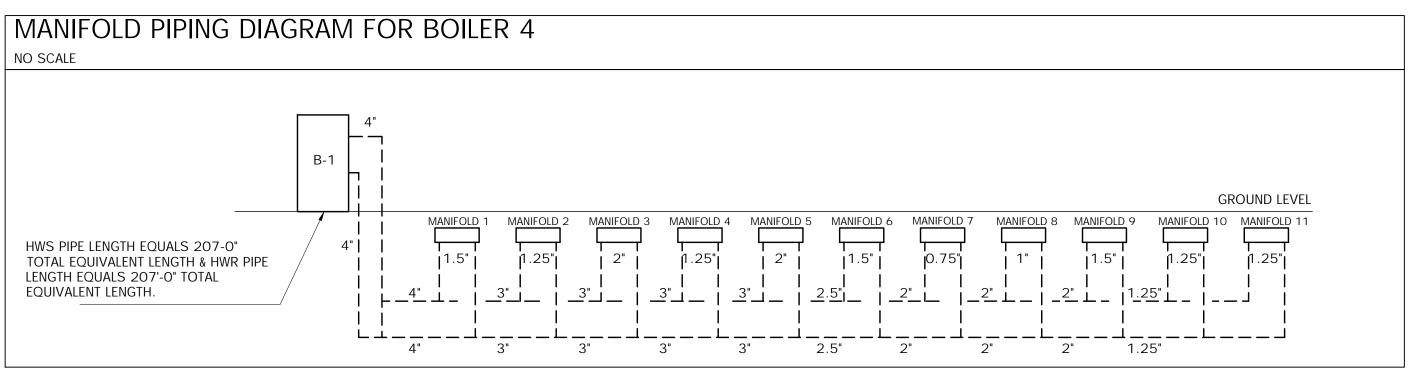

	GENERAL NOTES
	A. REFER TO SNOW MELT SYSTEM LOOP DRAWINGS FOR MORE INFORMATION ON SNOW MELT PIPING AND MANIFOLDS.
	B. REFER TO MANIFOLD PIPING DIAGRAM FOR BOILER 1 ON THIS SHEET FOR MORE INFORMATION ON BOILER SYSTEM PIPE SIZES.
GROUND LEVEL ANIFOLD 10 MANIFOLD 11	

KEYNOTES


- 1 NATURAL GAS DN TO BOILER WITH SHUTOFF VALVE, DIRT LEG & UNION. FIELD COORDINATE FINAL CONNECTION.
- 2 1" DOMESTIC WATER SERVICE B/G, SEE CIVIL DWG FOR CONT

 BOILER FLUE VENT TO EXTERIOR WALL TERMINATION PER MANUFACTURER'S INSTALLATION INSTRUCTIONS. REFER TO
- MANUFACTURER'S REQUIRED CLEARANCES LISTED ON THIS SHEET.


 4 ROUTE 4" HWS TO MANIFOLDS AND CONTINUE 4" HWR FROM MANIFOLDS BACK TO BOILER. REFER TO SNOW MELT SYSTEM LOOP DRAWING ON SHEET M3.0 FOR MANIFOLD LOCATIONS AND MANIFOLD PIPING DIAGRAM.
- NATURAL GAS DN TO NEW METER/PRV INSTALLATION, COORDINATE WITH UTILITY PROVIDER. SEE NATURAL GAS RISER DIAGRAM FOR ADDITIONAL INFORMATION AND SIZING CRITERIA.
- BOILER COMBUSTION PIPE TO EXTERIOR WALL TERMINATION PER MANUFACTURER'S INSTALLATION INSTRUCTIONS. REFER TO MANUFACTURER'S REQUIRED CLEARANCES LISTED ON THIS SHEET.

BOILER VENT CLEARANCES:


- AT LEAST 6 FEET (1.8 M) FROM ADJACENT WALLS.
- NO CLOSER THAN 12 INCHES (305 MM) BELOW ROOF OVERHANG.
- AT LEAST 7 FEET (2.1 M) ABOVE ANY PUBLIC WALKWAY.
- AT LEAST 3 FEET (.9 M) ABOVE ANY FORCED AIR
 INTAKE WITHIN 10 FEET (3 M).
- NO CLOSER THAN 4 FEET (1.2 M) BELOW OR HORIZONTALLY FROM ANY DOOR OR WINDOW OR ANY OTHER GRAVITY AIR INLET.
- B. AIR INLET MUST TERMINATE AT LEAST 12 INCHES (305 MM) ABOVE GRADE OR SNOW LINE; AT LEAST 3 FEET (.9 M) BELOW THE VENT TERMINATION (FIG. 4-1B); AND THE VENT PIPE MUST NOT EXTEND MORE THAN 24 INCHES (610 MM) VERTICALLY OUTSIDE THE BUILDING.
- C. DO NOT TERMINATE CLOSER THAN 4 FEET (1.2 M) HORIZONTALLY FROM ANY ELECTRIC METER, GAS METER, REGULATOR, RELIEF VALVE, OR OTHER EQUIPMENT. NEVER TERMINATE ABOVE OR BELOW ANY OF THESE WITHIN 4 FEET (1.2 M) HORIZONTALLY.

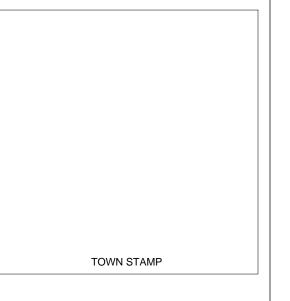



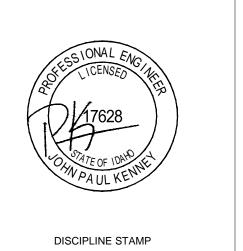

WARM SPRINGS
TOWNHOMES

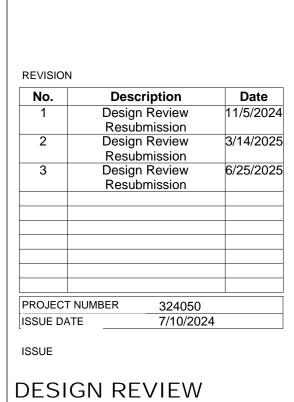


DESIGN REVIEW APPLICATION

SHEET TITLE

SNOW MELT DESIGN

SHEET NO

M1.0

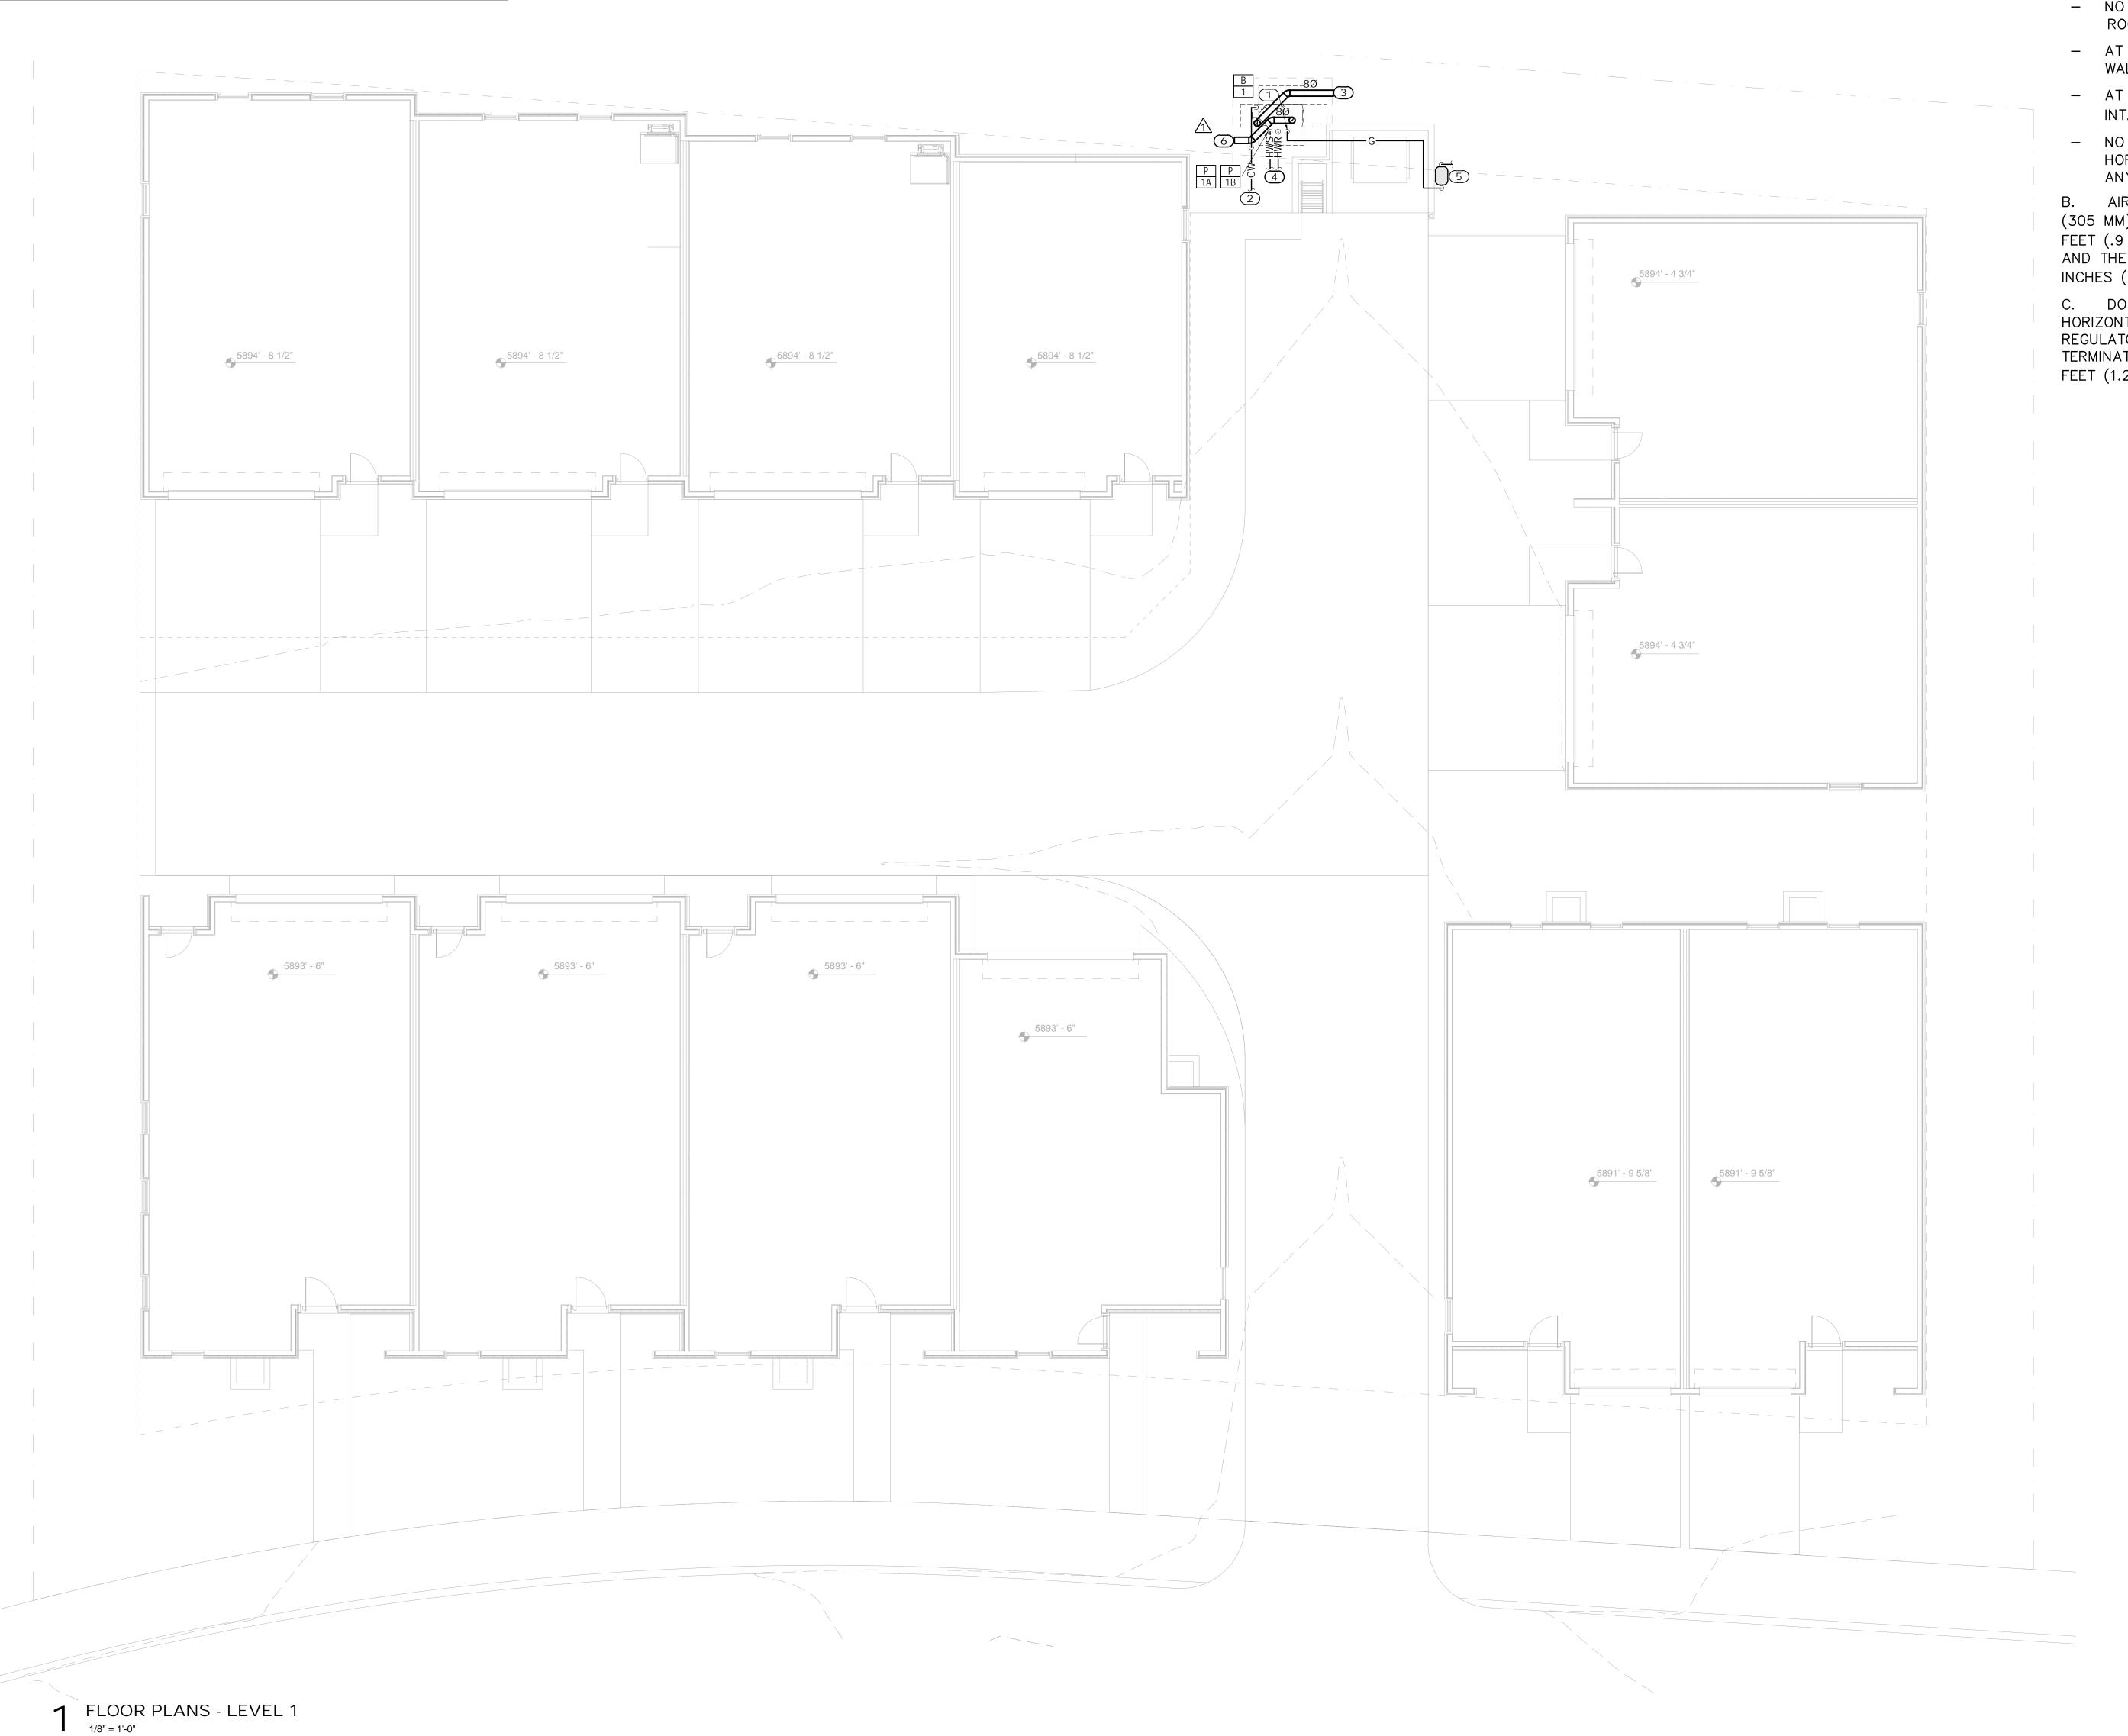



REVISION

No. Description Date

1 Design Review 11/5/2024
Resubmission

2 Design Review 3/14/2025
Resubmission

3 Design Review 6/25/2025
Resubmission

PROJECT NUMBER 324050
ISSUE DATE 7/10/2024

ISSUE

DESIGN REVIEW APPLICATION


EET TITLE

SNOW MELT SYSTEM

M3.0




TOWN STAMP

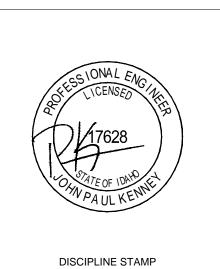

SPRINGS


WARM

Statistics						
Description	Symbol	Avg	Max	Min	Max/Min	Avg/Min
Calc Zone #1	+	0.9 fc	32.9 fc	0.0 fc	N/A	N/A

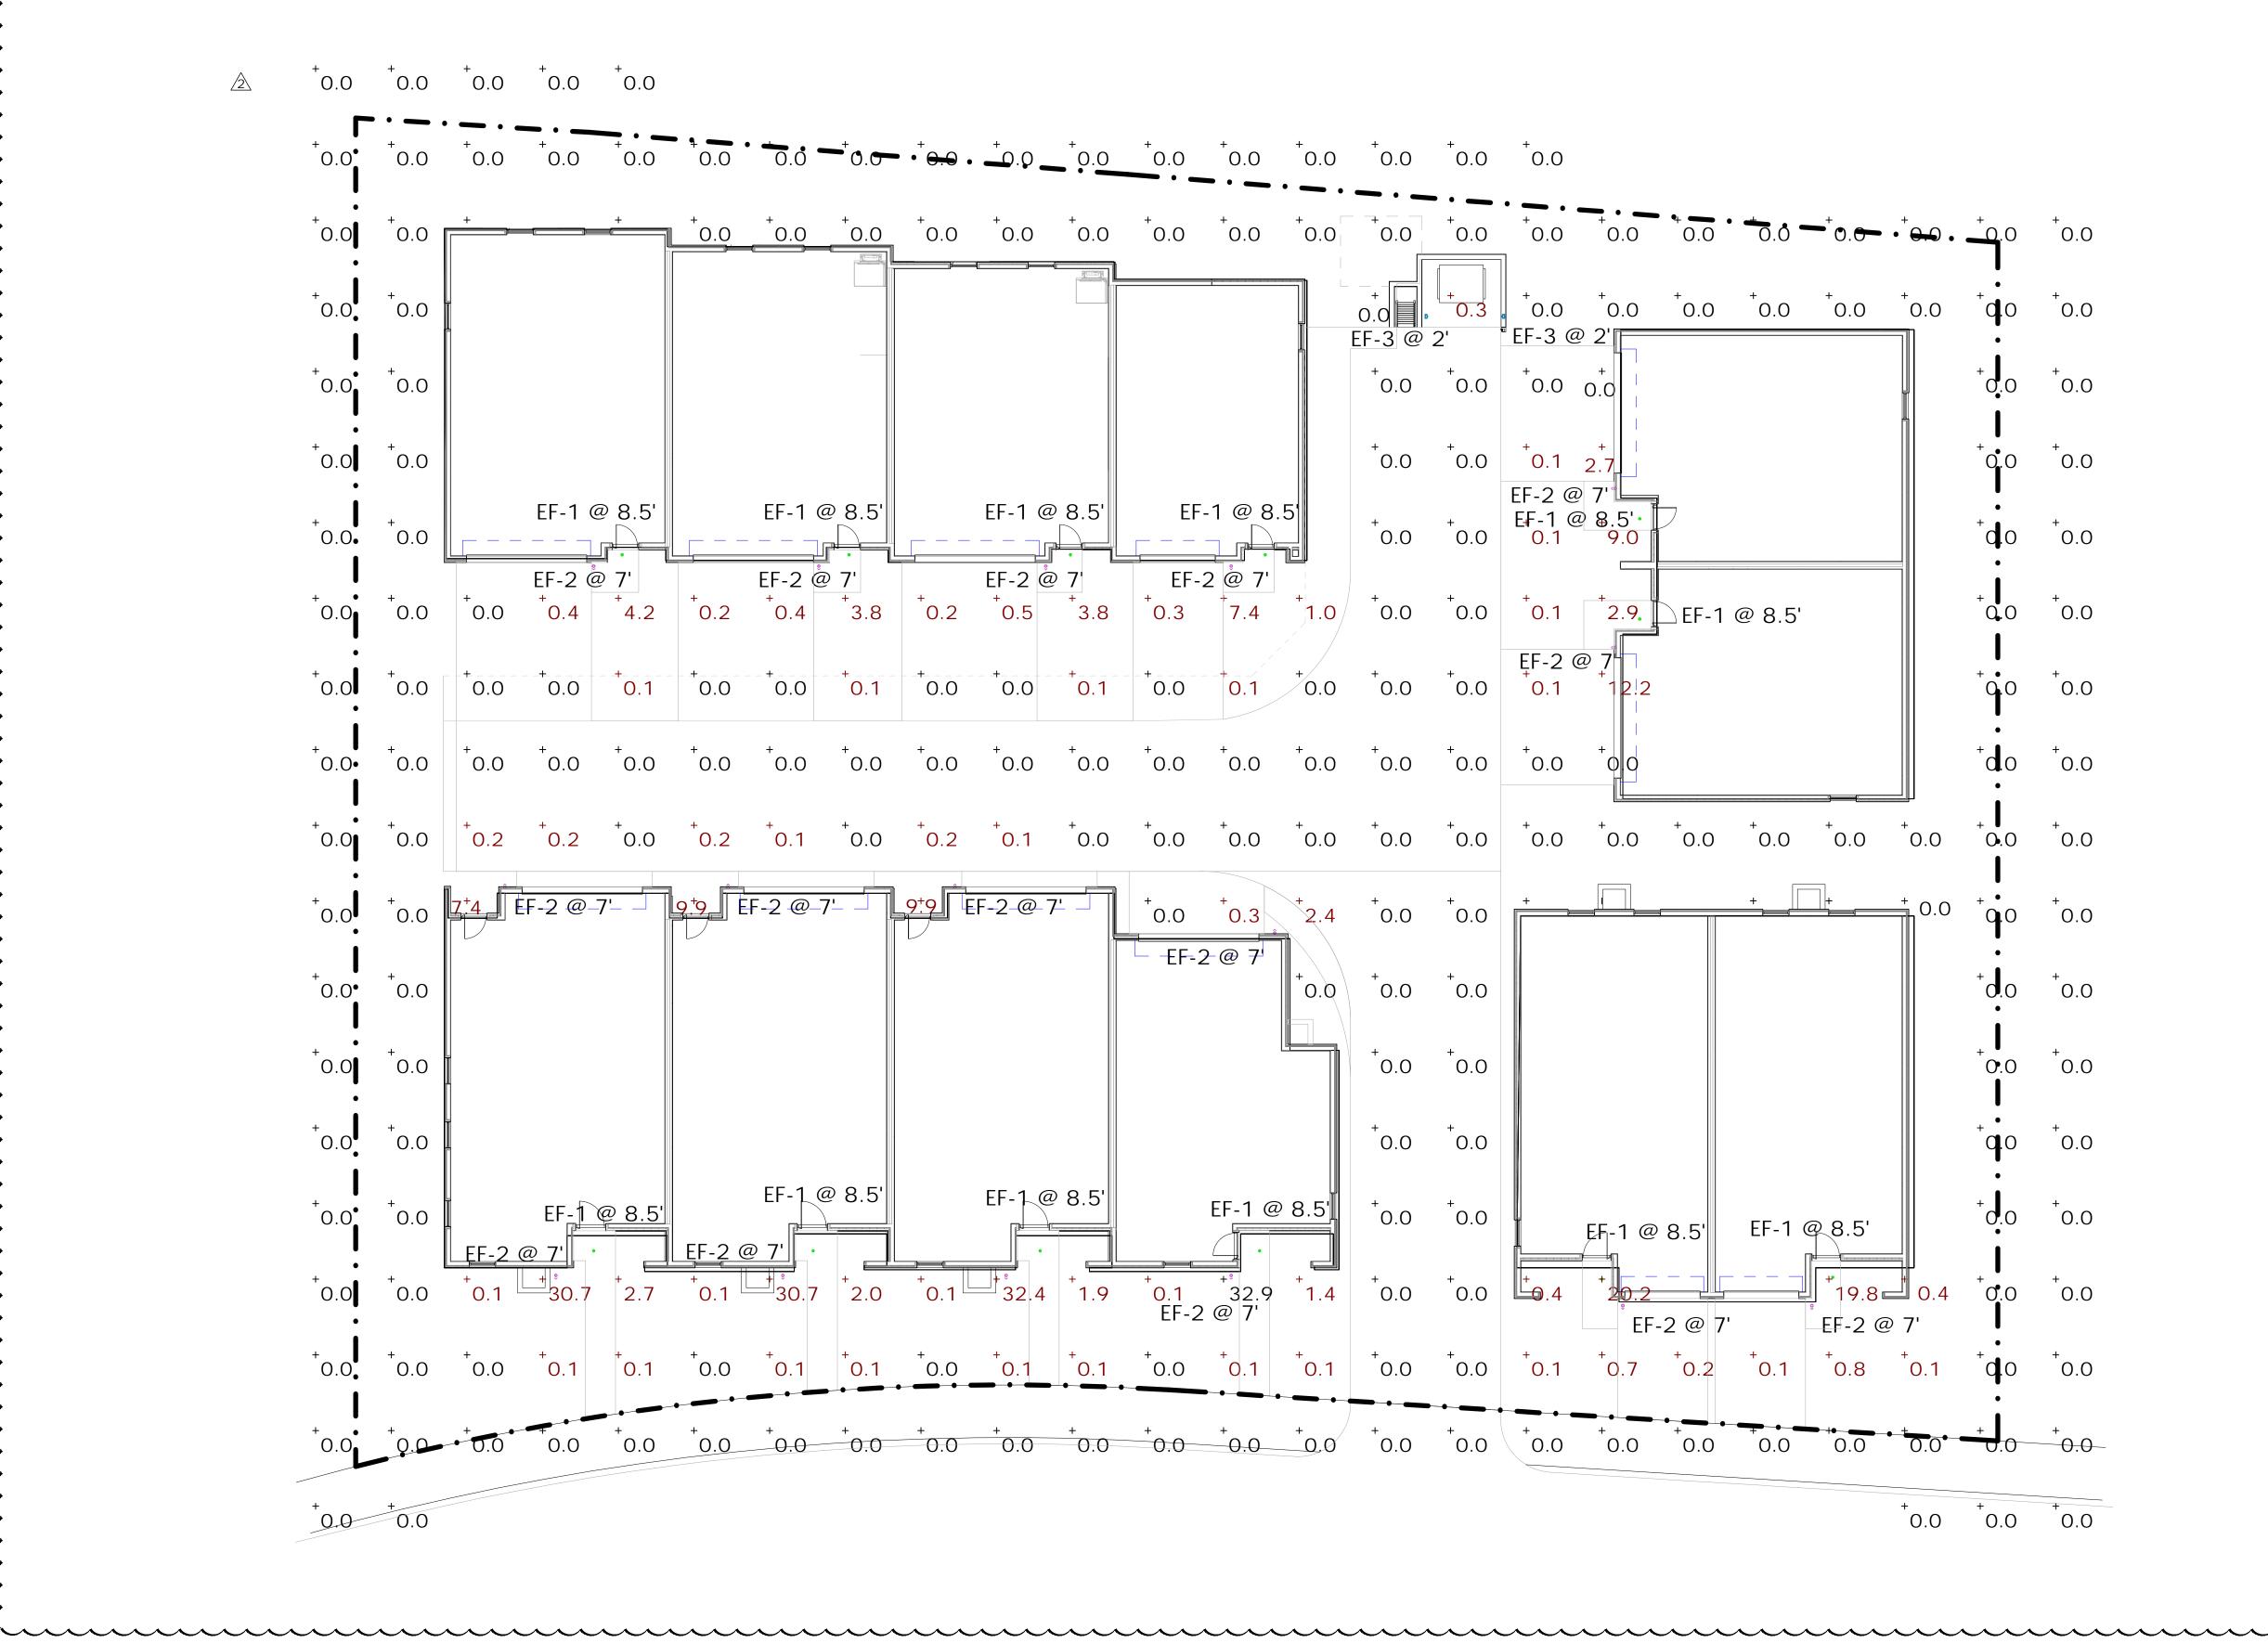

TOWN STAMP



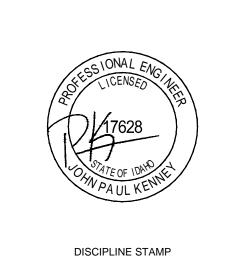

WARM SPRINGS
TOWNHOMES

108 RITCHIE DRIVE
KETCHUM, ID 83340



APPLICATION


SHEET TITLE

SITE PHOTOMETRIC

SHEET N

E0.10

1 FLOOR PLANS - LEVEL 1 3/32" = 1'-0"

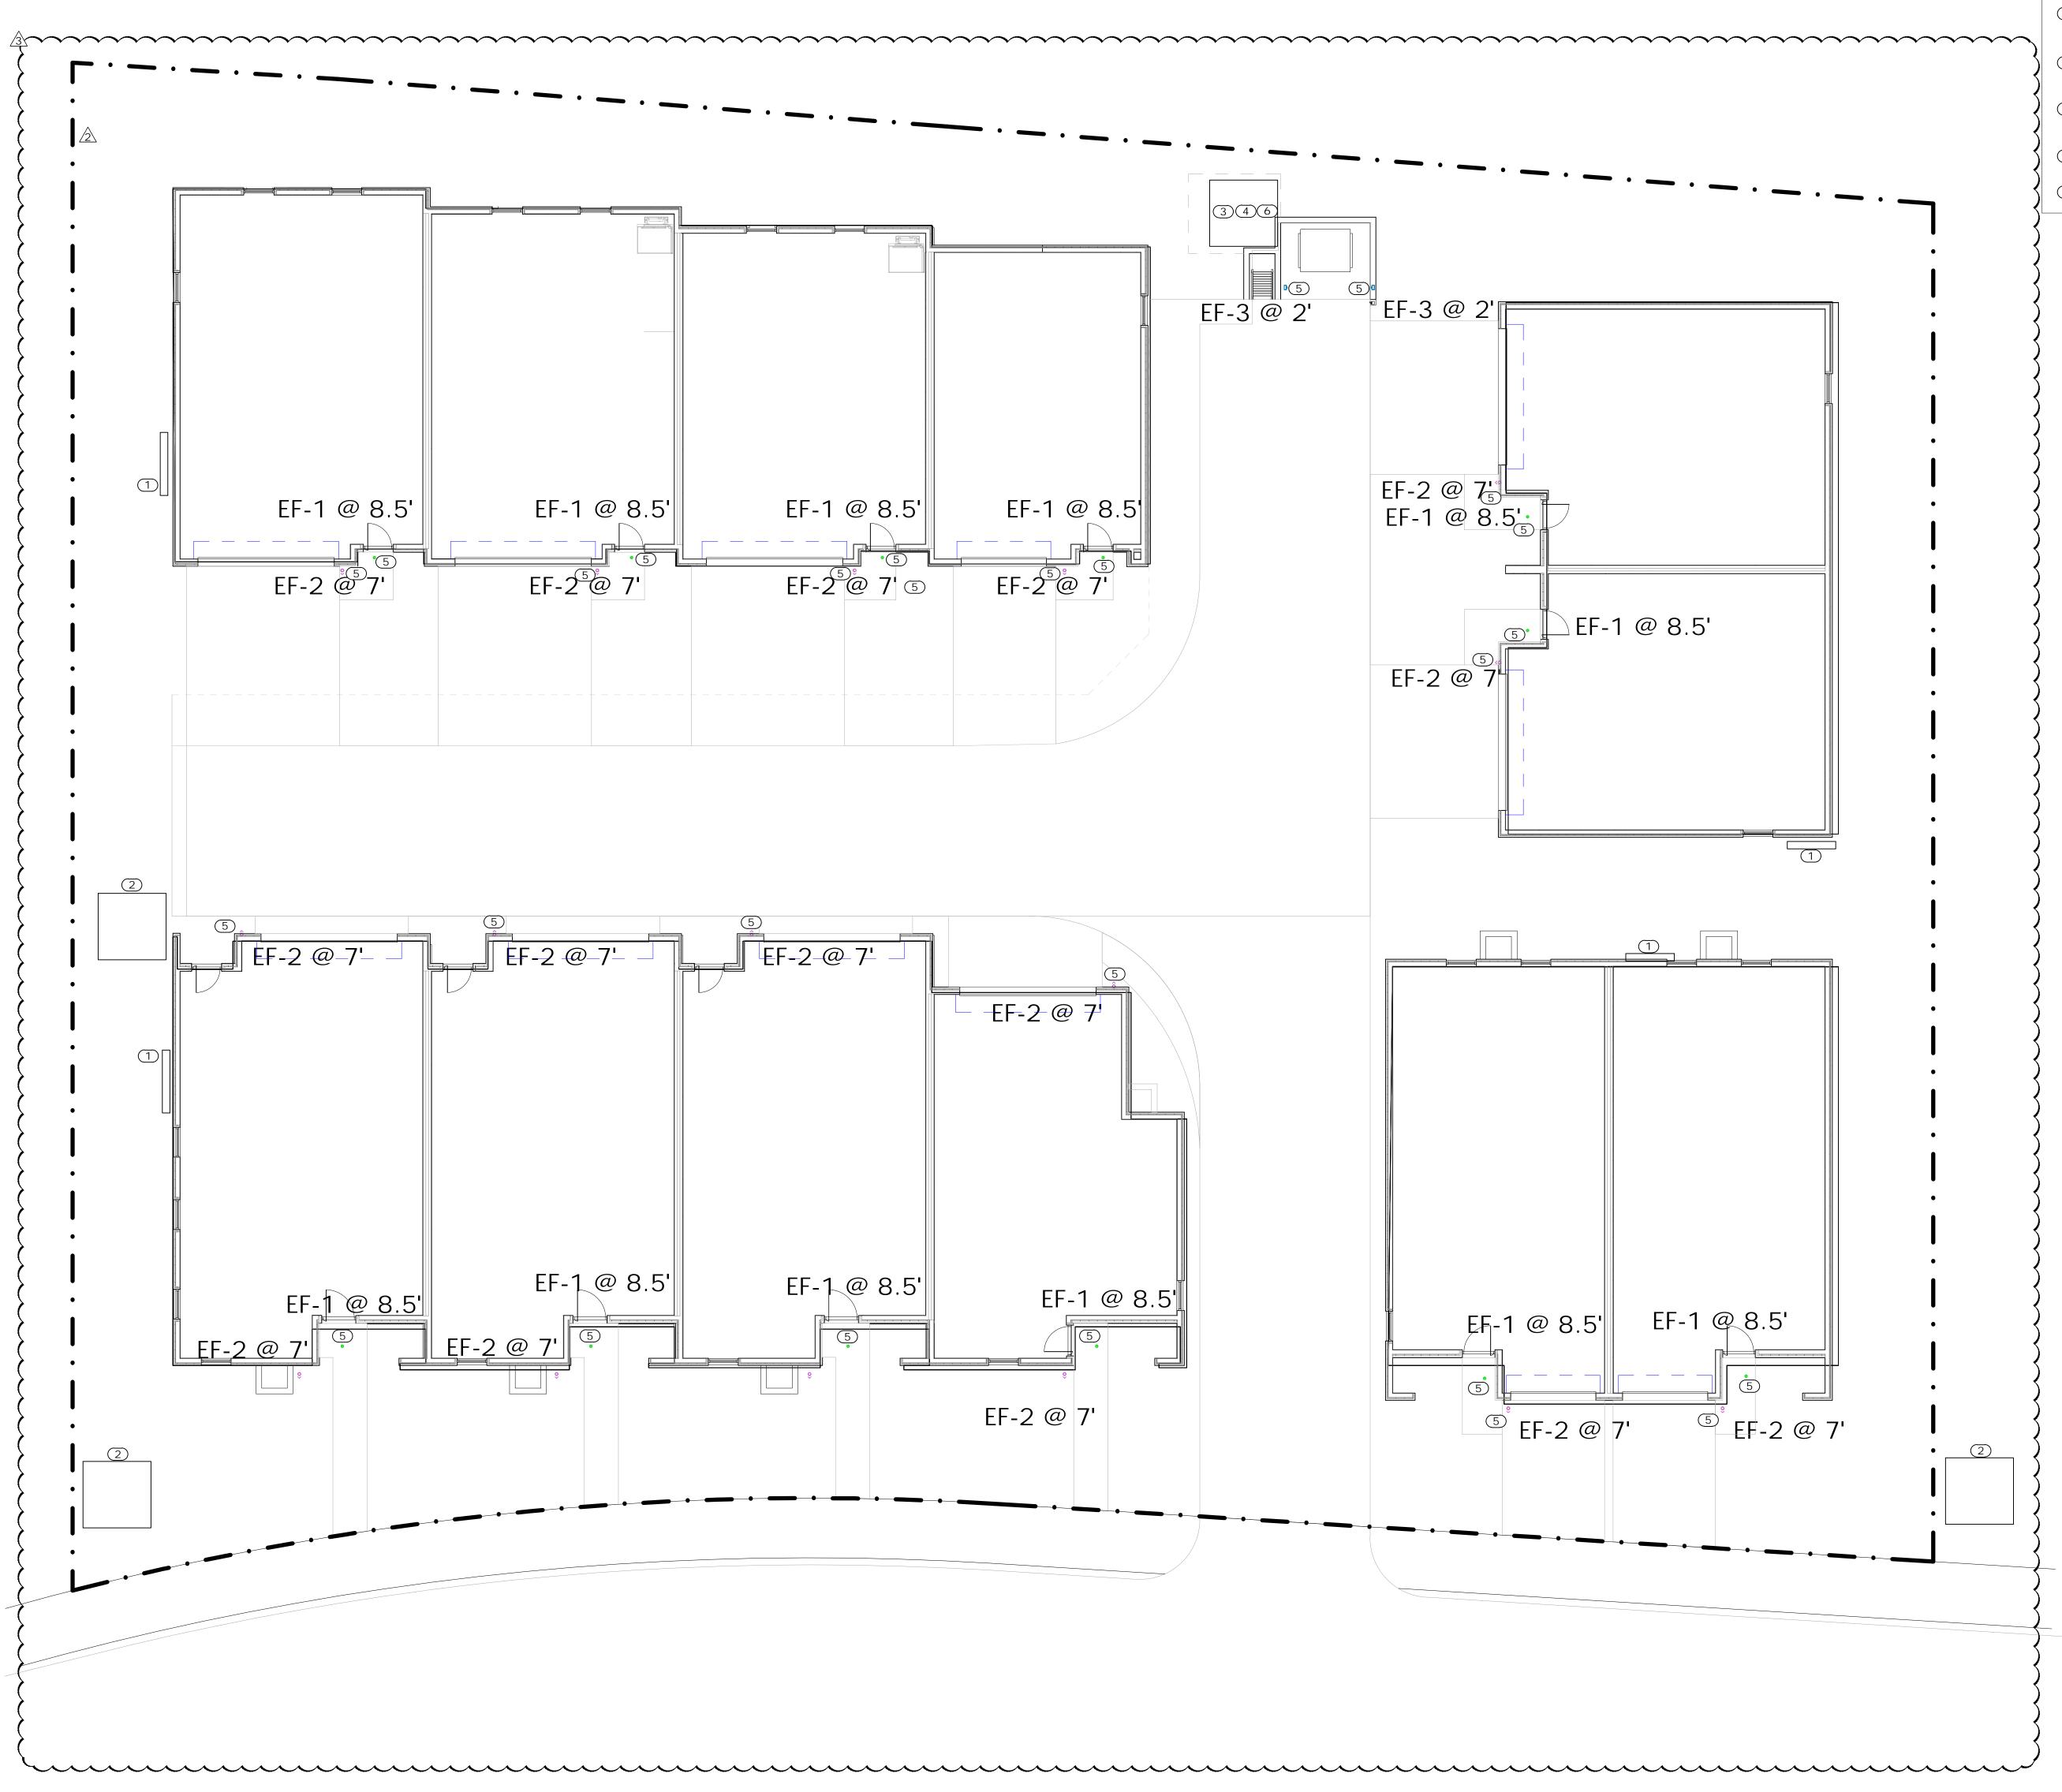

1 FLOOR PLANS - LEVEL 1
1/8" = 1'-0"

GENERAL NOTES


ALL SITE AND EXTERIOR BUILDING LIGHTING FIXTURES SHALL CONFORM TO DARK SKY REQUIREMENTS AS NECESSARY TO MEET LOCAL JURISDICTIONAL CODES.

KEYNOTES

- 1 PROPOSED LOCATION FOR MAIN SERVICE DISCONNECT AND UNIT METERING STACK. REFERENCE ARCHITECTURAL PLANS FOR EXACT LOCATION.
- 2 PROPOSED UTILITY TRANSFORMER LOCATION. COORDINATE UTILITY TRANSFORMER LOCATION WITH UTILITY PROVIDER AND BUILDING SERVICE DISCONNECT LOCATION PRIOR TO ROUGH-IN.
- PROVIDE 208, 1PH, 3W, 20A BRANCH CIRCUIT AND 30A/2P/NEMA 3R DISCONNECT FOR PRIMARY LOOP PUMP POWER. CIRCUIT FROM NEAREST HOUSE PANEL. COORDINATE CONNECTION LOCATION WITH PUMP VENDOR PRIOR TO ROUGH-IN.
- PROVIDE 208, 1PH, 3W, 20A BRANCH CIRCUIT AND 30A/2P/NEMA 3R DISCONNECT FOR SECONDARY LOOP PUMP POWER. CIRCUIT FROM NEAREST HOUSE PANEL. COORDINATE CONNECTION LOCATION WITH PUMP VENDOR PRIOR TO ROUGH-IN.
- 5 PROVIDE 120V, 20A BRANCH CIRCUIT VIA PHOTOCELL FOR LUMINARIE CONTROL TO EXTERIOR LUMINAIRE. CIRCUIT FROM TENANT PANEL.
- 6 PROVIDE 120V, 20A BRANCH CIRCUIT FOR BOILER POWER. CIRCUIT FROM NEAREST HOUSE PANEL.




TOWN STAMP

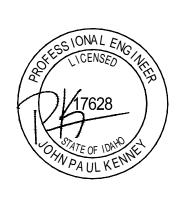

DISCIPLINE STAMP

WARM SPRINGS
TOWNHOMES


108 RITCHIE DRIVE
KETCHUM, ID 83340

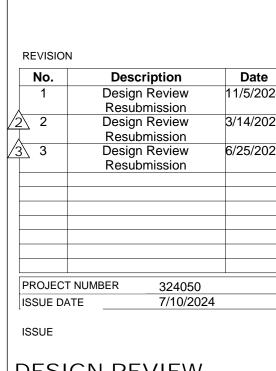



DESIGN REVIEW APPLICATION


SITE PLAN


E0.11

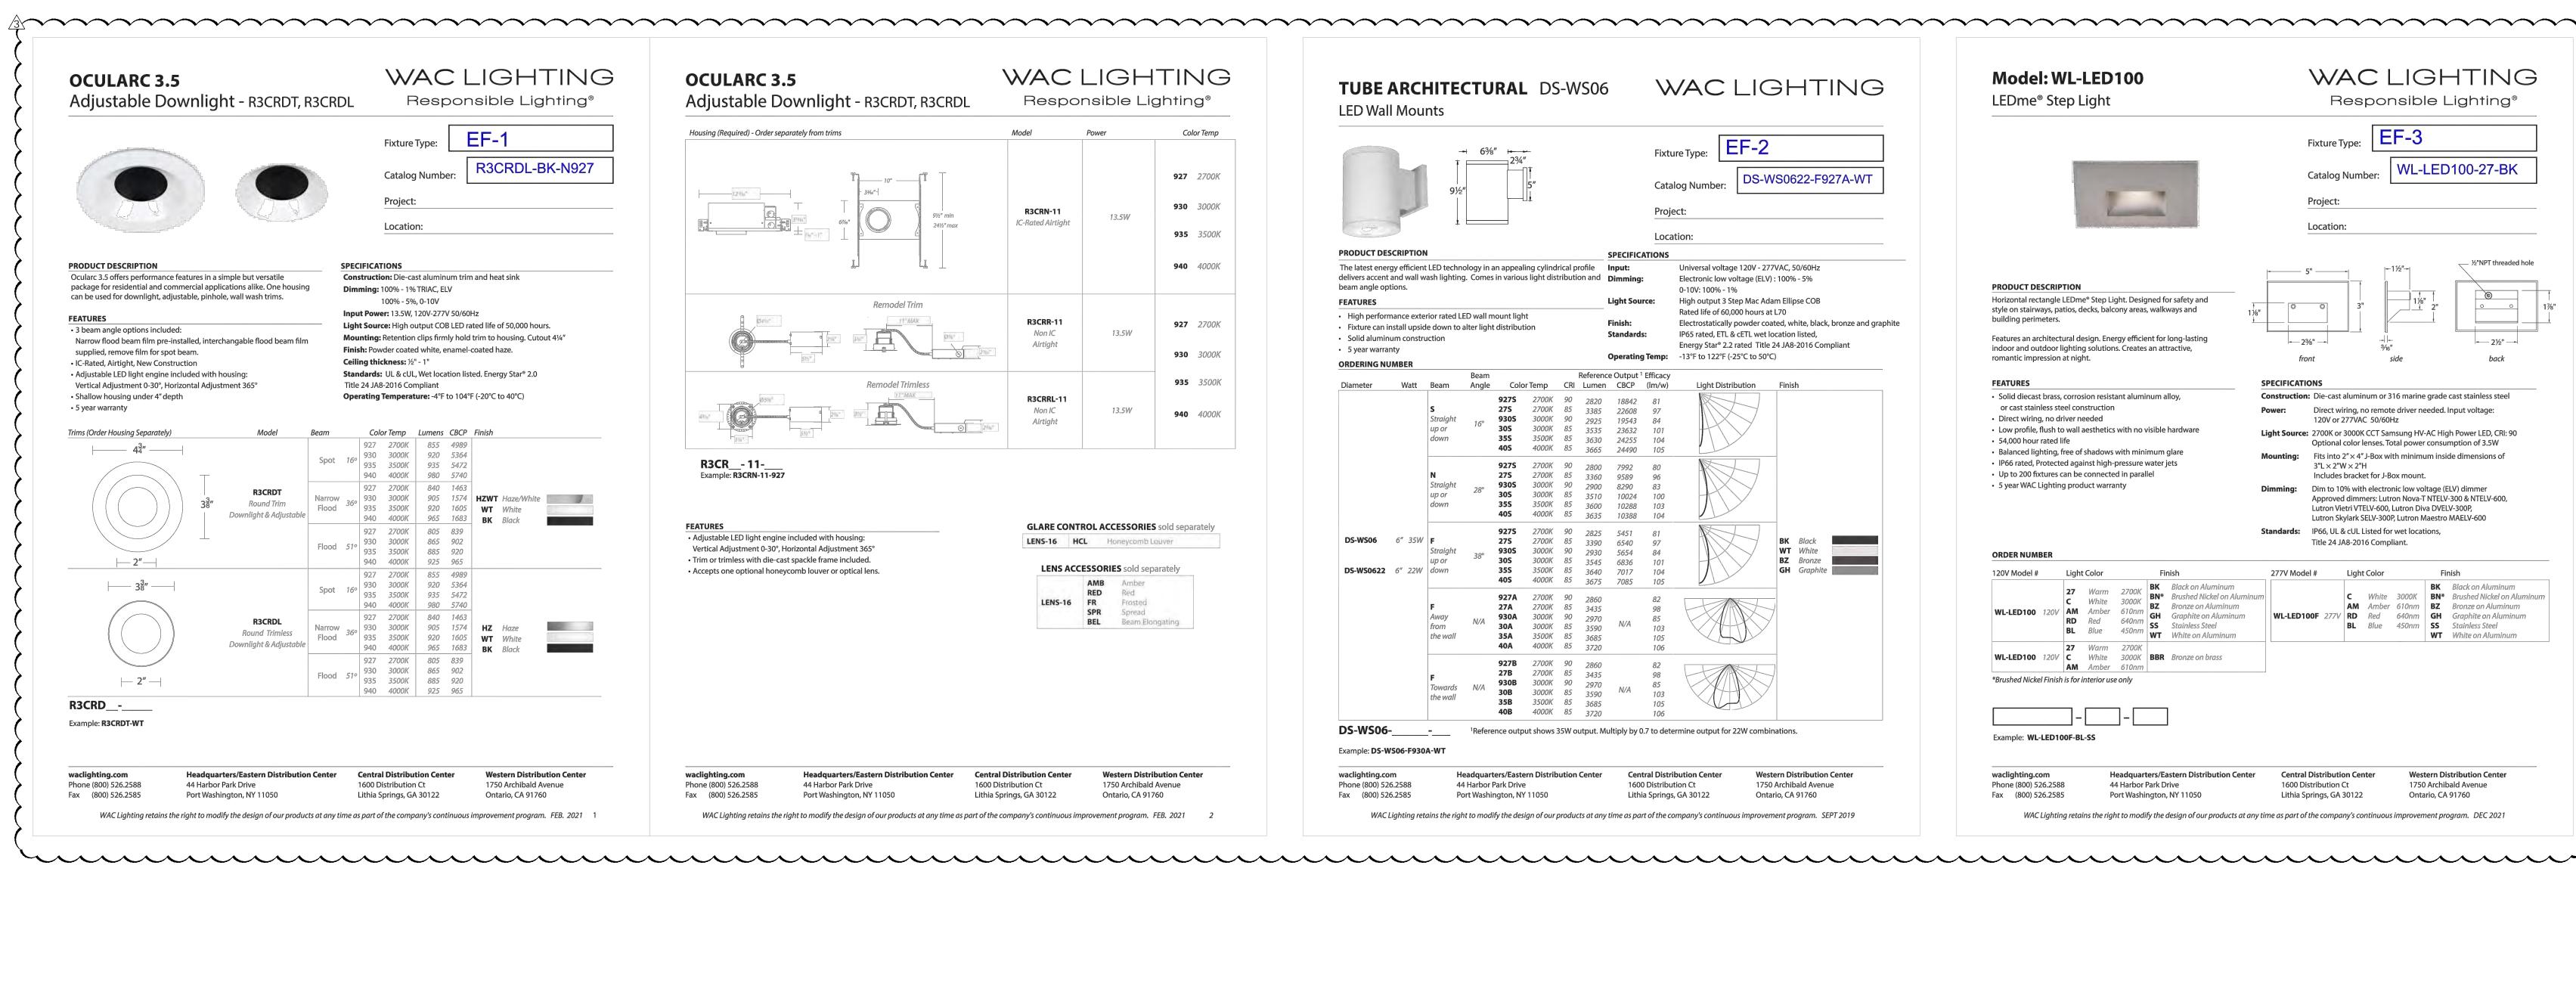

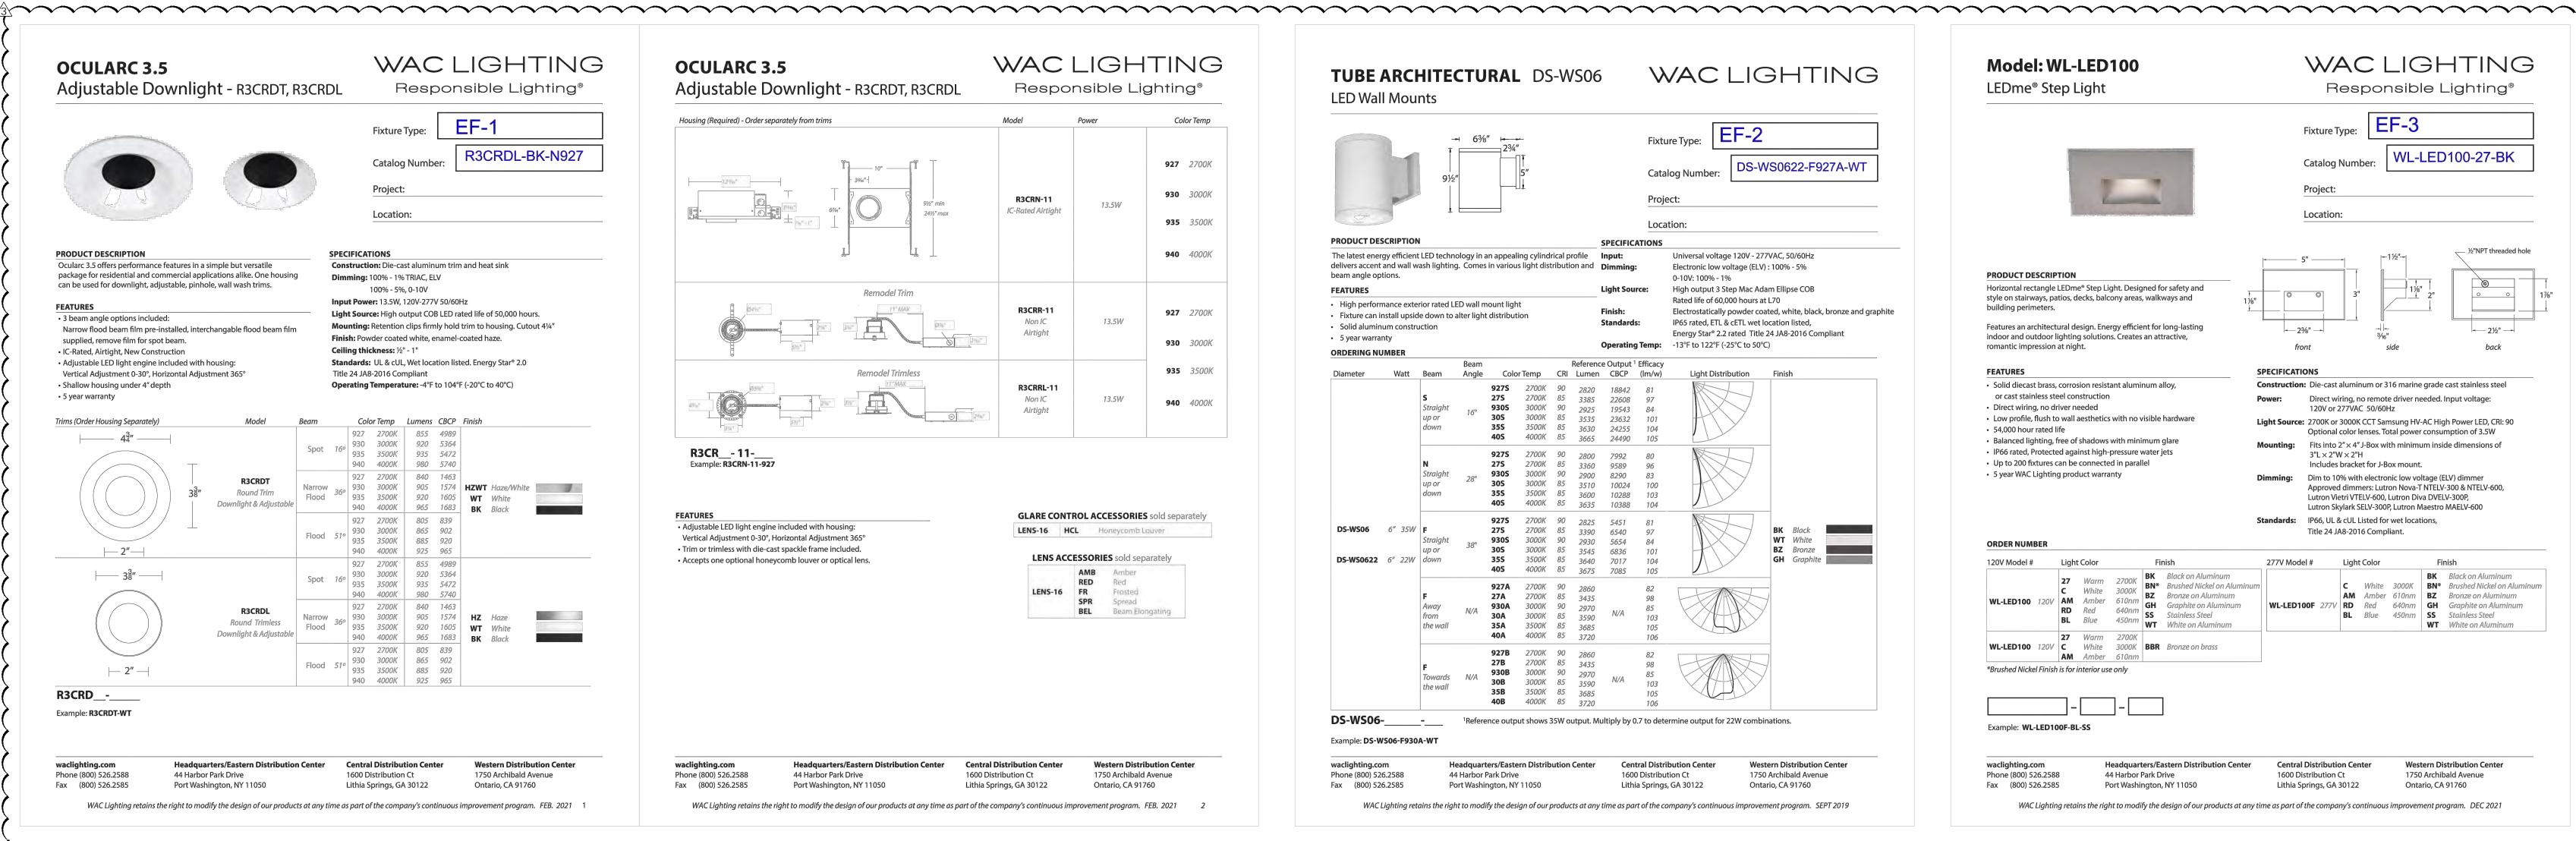

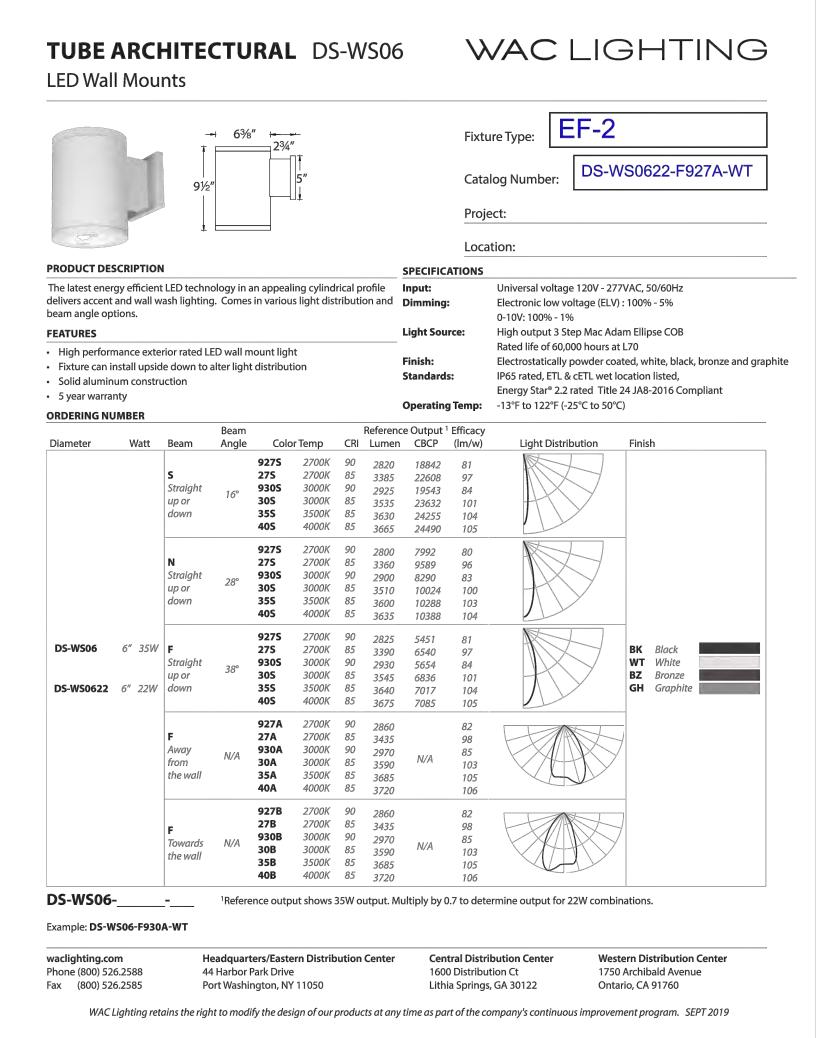

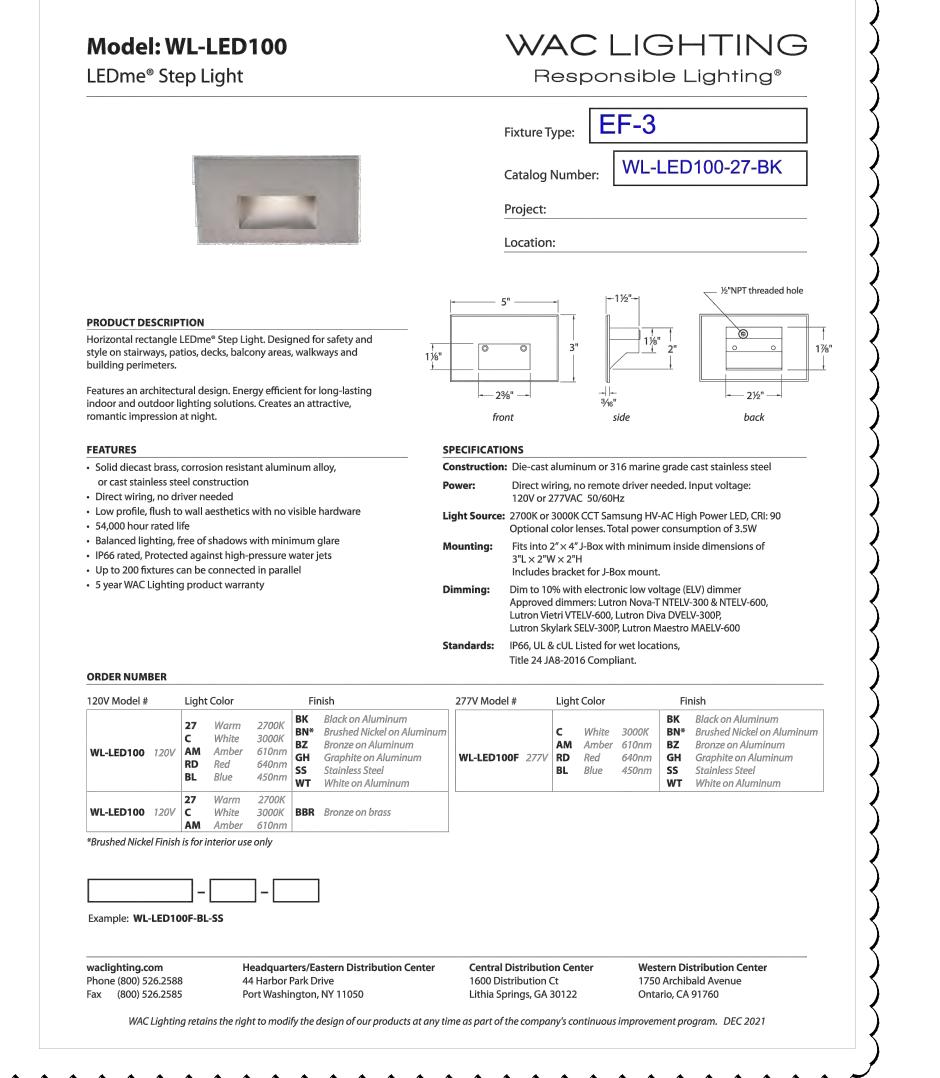


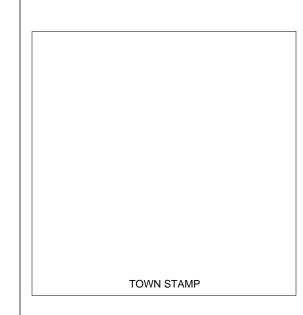






WARM SPRINGS OWNHOME

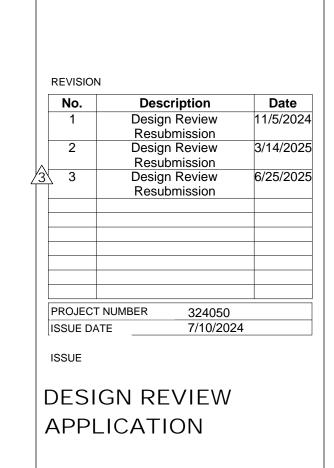

SHEET TITLE

SCHEDULES

E0.12

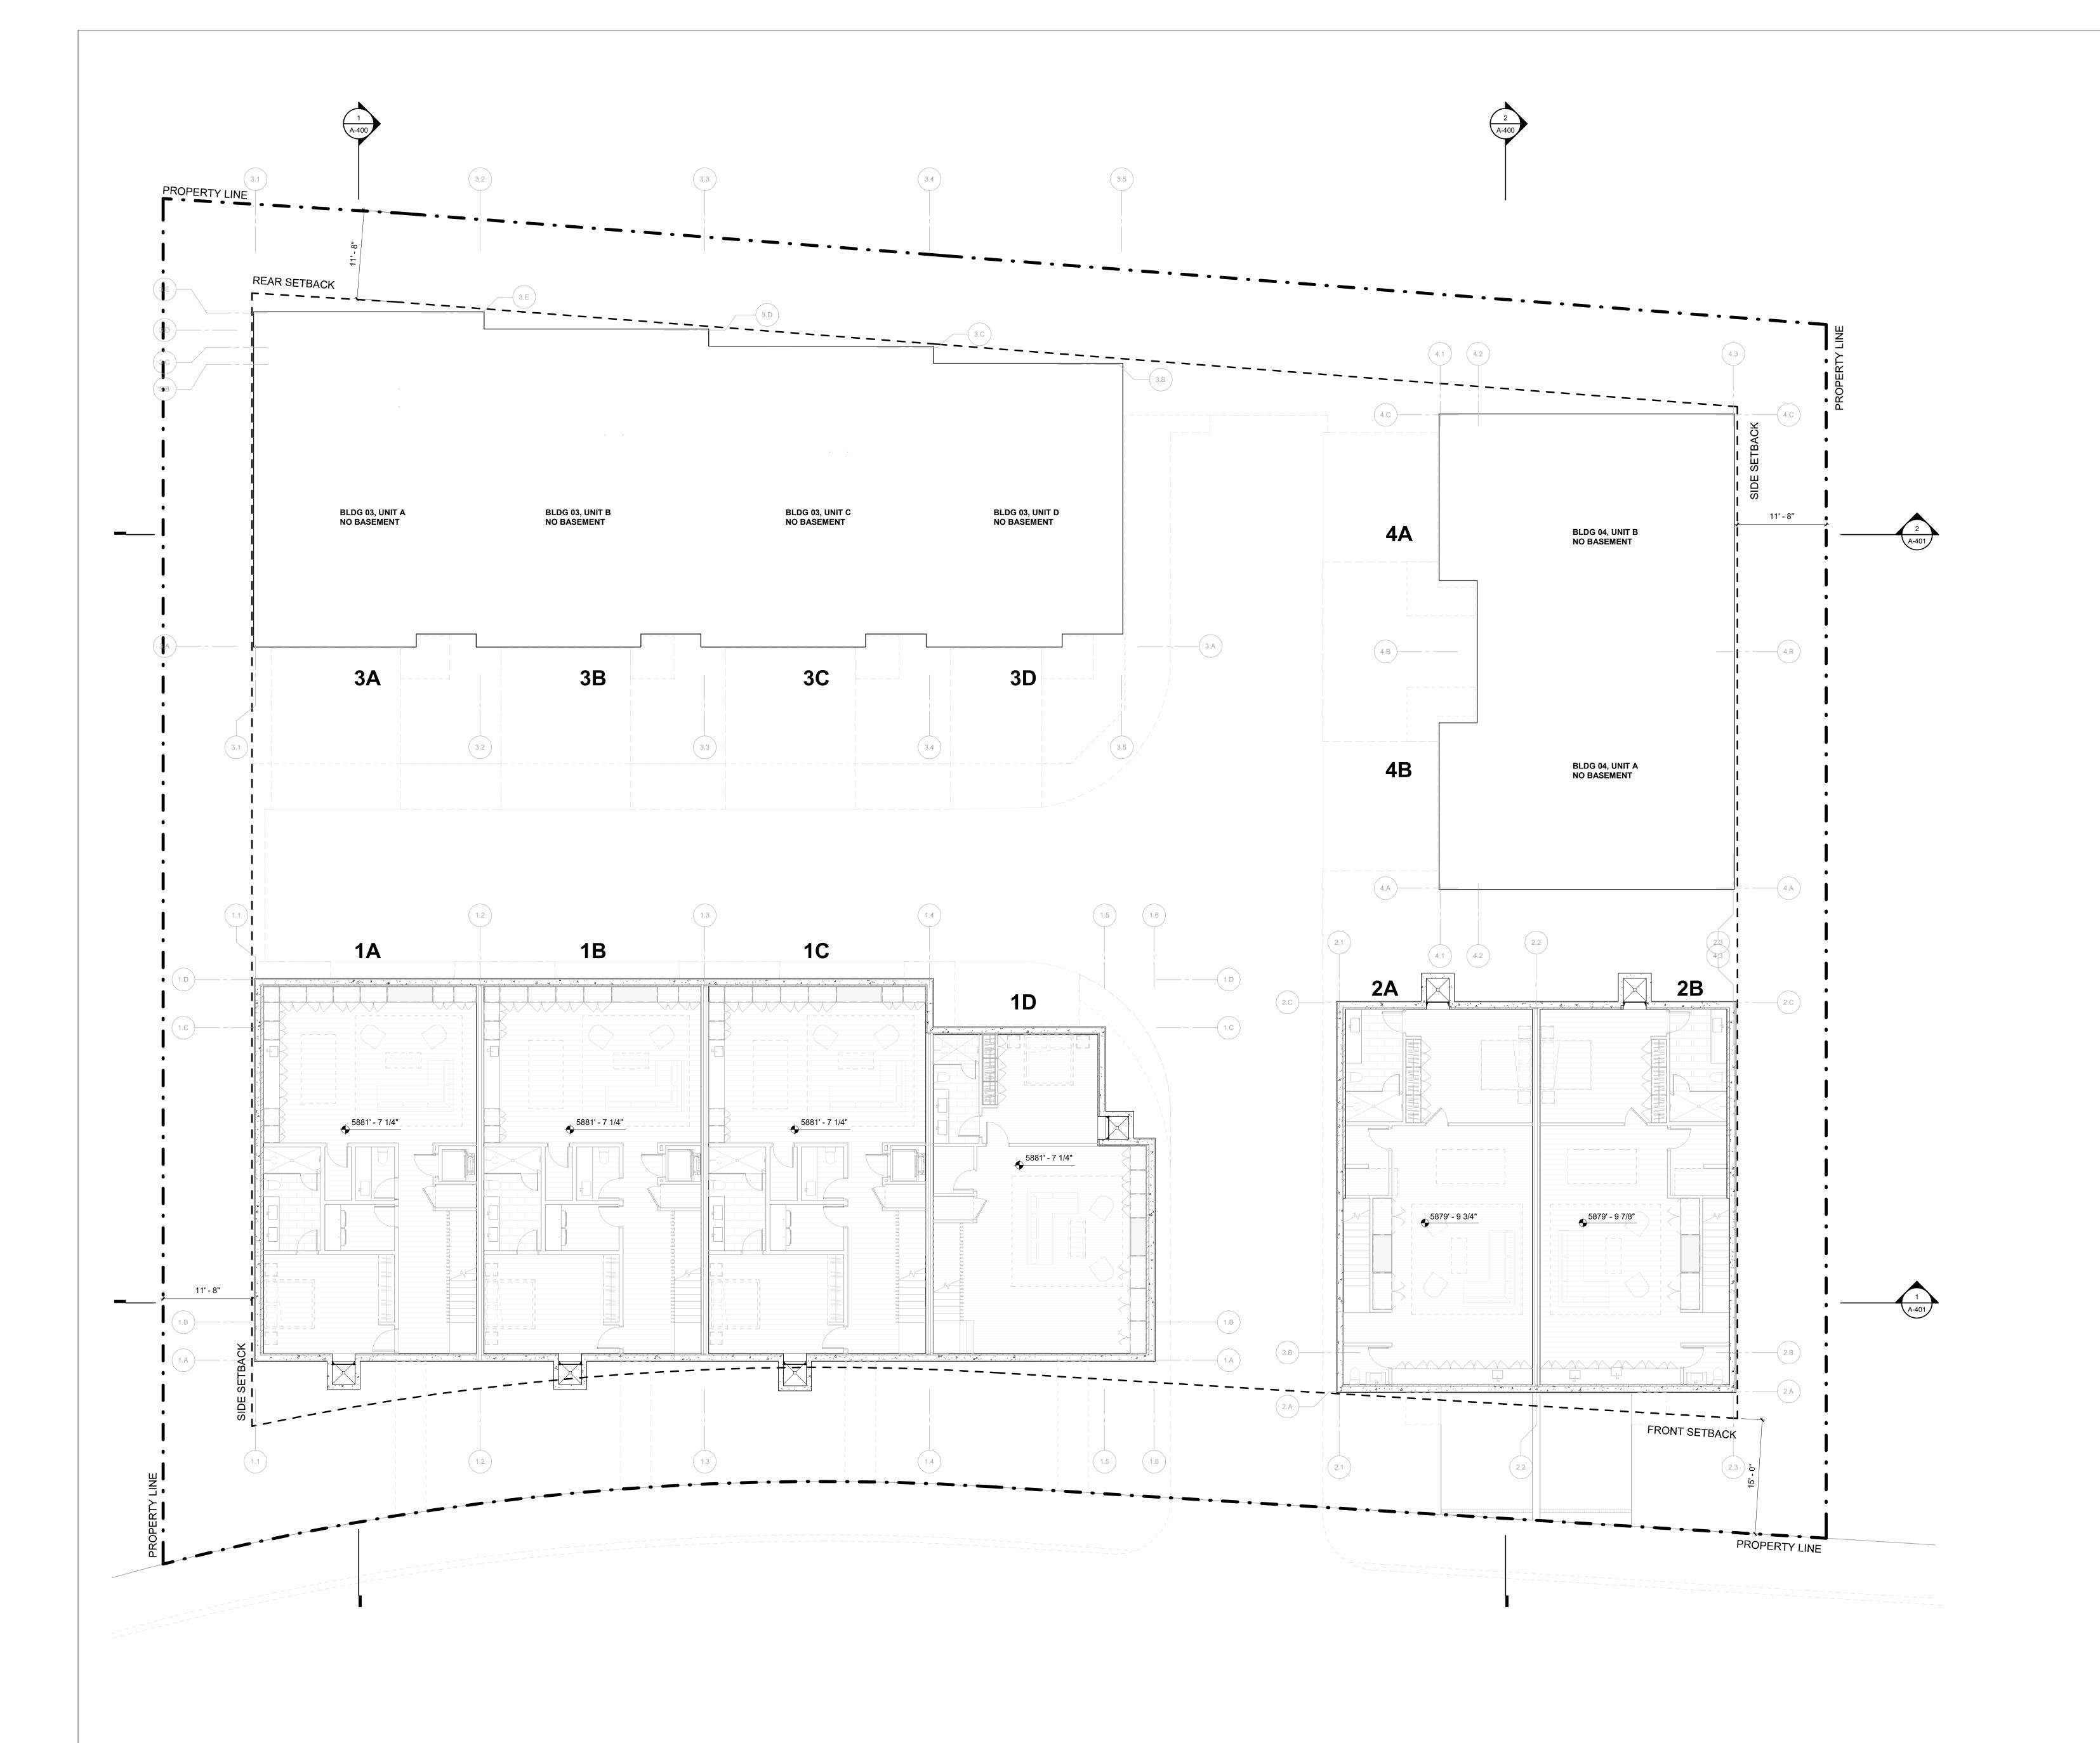

1 1/8" = 1'-0" **OVERALL PLAN - LEVEL 0**

WARM SPRINGS TOWNHOMES KETCHUM, ID

OWNER:

108-110 RITCHIE LLC P.O. BOX 14001-174 KETCHUM, ID 83340 TEL: 603.801.0419

BUILDING ARCHITECT:

RO | ROCKETT DESIGN 1031 W. MANCHESTER BLVD. UNIT 6 INGLEWOOD, CA 90301 TEL: 213.784.0014

STRUCTURAL ENGINEER:

ZFA STRUCTURAL ENGINEERS
601 MONTGOMERY STREET SUITE 1450
SAN FRANCISCO, CA 94111
TEL: 415.243.4091

MECHANICAL, ELECTRICAL, PLUMBING ENGINEER:

PROFICIENT ENGINEERING

4704 HARLAN STREET SUITE 620

DENVER, CO 80212 TEL: 720.779.3556

CIVIL ENGINEER:

GALENA BENCHMARK ASSOCIATES 100 BELL DRIVE SUITE C KETCHUM, ID 83340 TEL: 208.726.9512

LANDSCAPE ARCHITECT:

560 NORTH 2ND AVENUE KETCHUM, ID 83340 TEL: 208.725.0988

EGGERS ASSOCIATES

DESIGN REVIEW APPLICATION 25.09.09

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PROJECT:
WARM SPRINGS TOWNHOMES
KETCHUM, ID

108 & 110 RITCHIE DR. KETCHUM, IDAHO

DRAWING TITLE:


LEVEL 00 OVERALL FLOOR
PLAN

SEAL:

PROJECT NUMBER

DRAWING NUMBER:

A-100

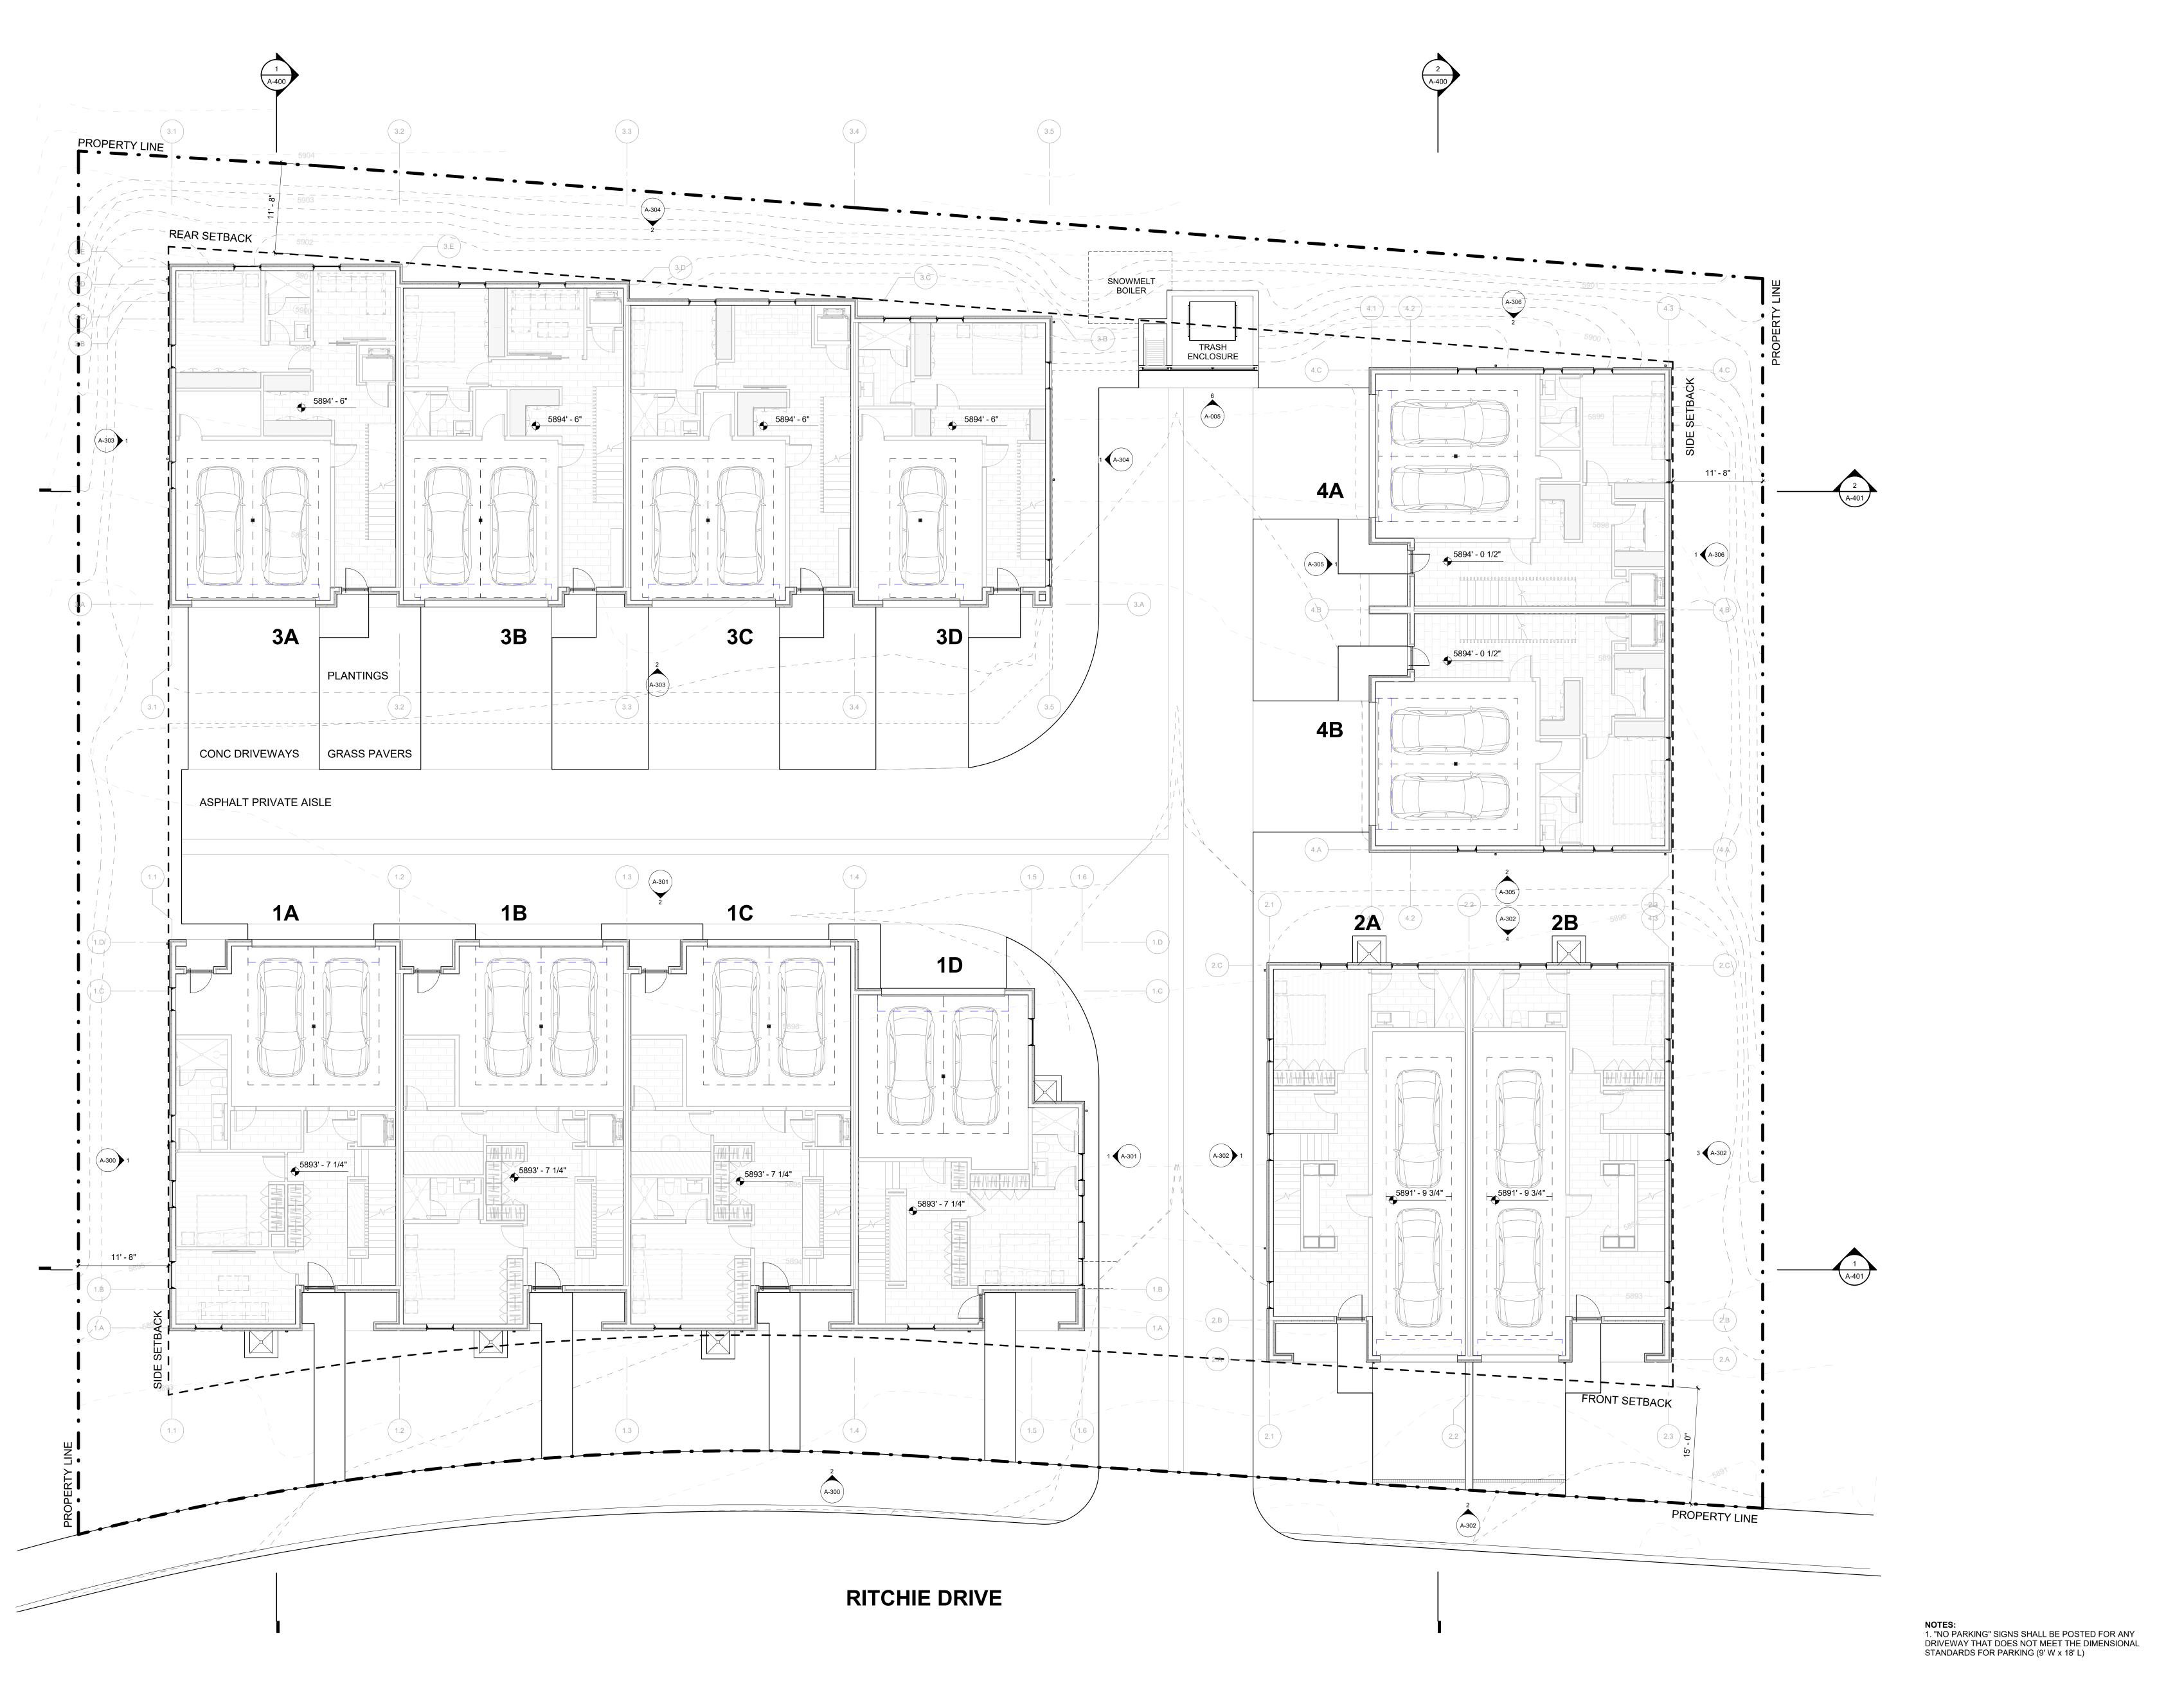

1/8" = 1'-0" **OVERALL PLAN - LEVEL 01**

WARM SPRINGS TOWNHOMES KETCHUM, ID

OWNER:

108-110 RITCHIE LLC P.O. BOX 14001-174 KETCHUM, ID 83340 TEL: 603.801.0419

BUILDING ARCHITECT:

RO | ROCKETT DESIGN 1031 W. MANCHESTER BLVD. UNIT 6 INGLEWOOD, CA 90301 TEL: 213.784.0014

STRUCTURAL ENGINEER:

ZFA STRUCTURAL ENGINEERS 601 MONTGOMERY STREET SUITE 1450 SAN FRANCISCO, CA 94111 TEL: 415.243.4091

MECHANICAL, ELECTRICAL, PLUMBING ENGINEER: PROFICIENT ENGINEERING 4704 HARLAN STREET SUITE 620

DENVER, CO 80212

TEL: 720.779.3556

CIVIL ENGINEER:

GALENA BENCHMARK ASSOCIATES 100 BELL DRIVE SUITE C KETCHUM, ID 83340 TEL: 208.726.9512

LANDSCAPE ARCHITECT:

EGGERS ASSOCIATES 560 NORTH 2ND AVENUE KETCHUM, ID 83340 TEL: 208.725.0988

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WARM SPRINGS TOWNHOMES KETCHUM, ID 108 & 110 RITCHIE DR.


KETCHUM, IDAHO

DRAWING TITLE: LEVEL 01 OVERALL FLOOR

PROJECT NUMBER

DRAWING NUMBER:

A-101

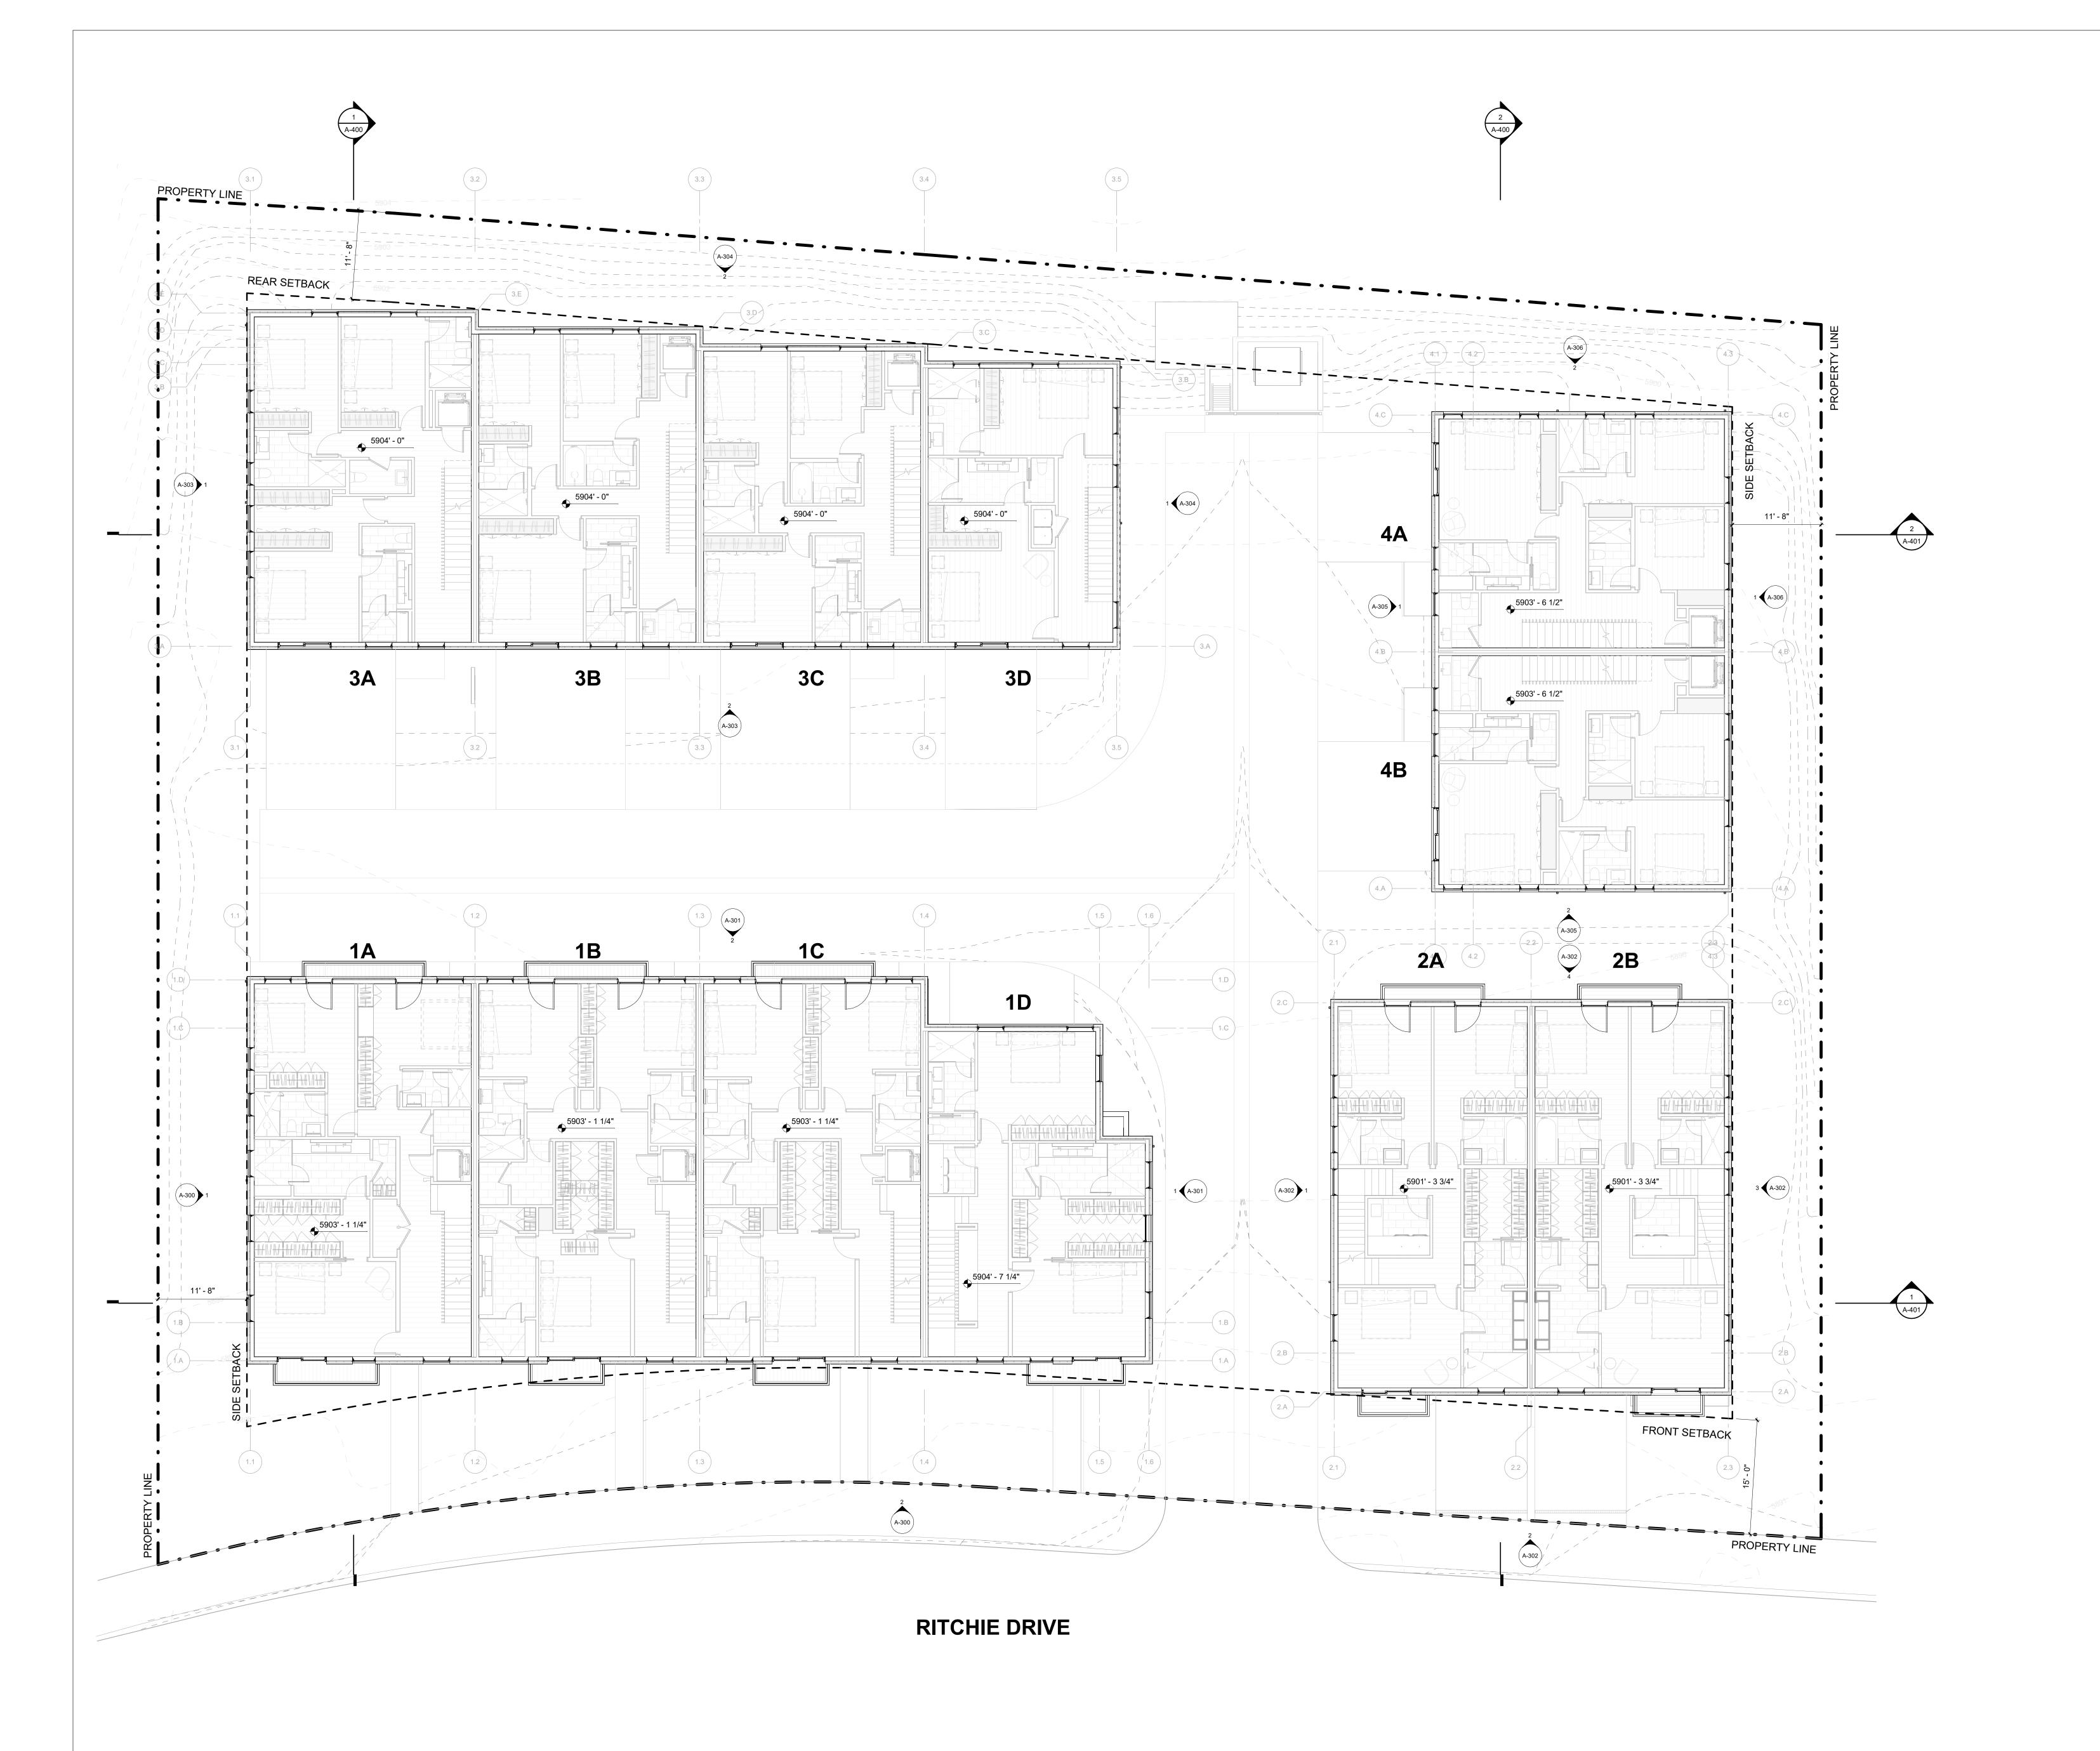

1/8" = 1'-0" **OVERALL PLAN - LEVEL 02**

WARM SPRINGS TOWNHOMES KETCHUM, ID

OWNER:

108-110 RITCHIE LLC P.O. BOX 14001-174 KETCHUM, ID 83340 TEL: 603.801.0419

BUILDING ARCHITECT:

RO | ROCKETT DESIGN 1031 W. MANCHESTER BLVD. UNIT 6 INGLEWOOD, CA 90301 TEL: 213.784.0014

STRUCTURAL ENGINEER:

ZFA STRUCTURAL ENGINEERS
601 MONTGOMERY STREET SUITE 1450
SAN FRANCISCO, CA 94111
TEL: 415.243.4091

MECHANICAL, ELECTRICAL, PLUMBING ENGINEER:

PROFICIENT ENGINEERING

4704 HARLAN STREET SUITE 620

DENVER, CO 80212 TEL: 720.779.3556

CIVIL ENGINEER:

GALENA BENCHMARK ASSOCIATES 100 BELL DRIVE SUITE C KETCHUM, ID 83340 TEL: 208.726.9512

LANDSCAPE ARCHITECT:

EGGERS ASSOCIATES 560 NORTH 2ND AVENUE KETCHUM, ID 83340 TEL: 208.725.0988

SUE DESCRIPTION DATE
DESIGN REVIEW APPLICATION 25.09.09

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WARM SPRINGS TOWNHOMES KETCHUM, ID

108 & 110 RITCHIE DR.

KETCHUM, IDAHO


LEVEL 02 OVERALL FLOOR
PLAN

SEAL:

PROJECT NUMBER

DRAWING NUMBER:

A-102

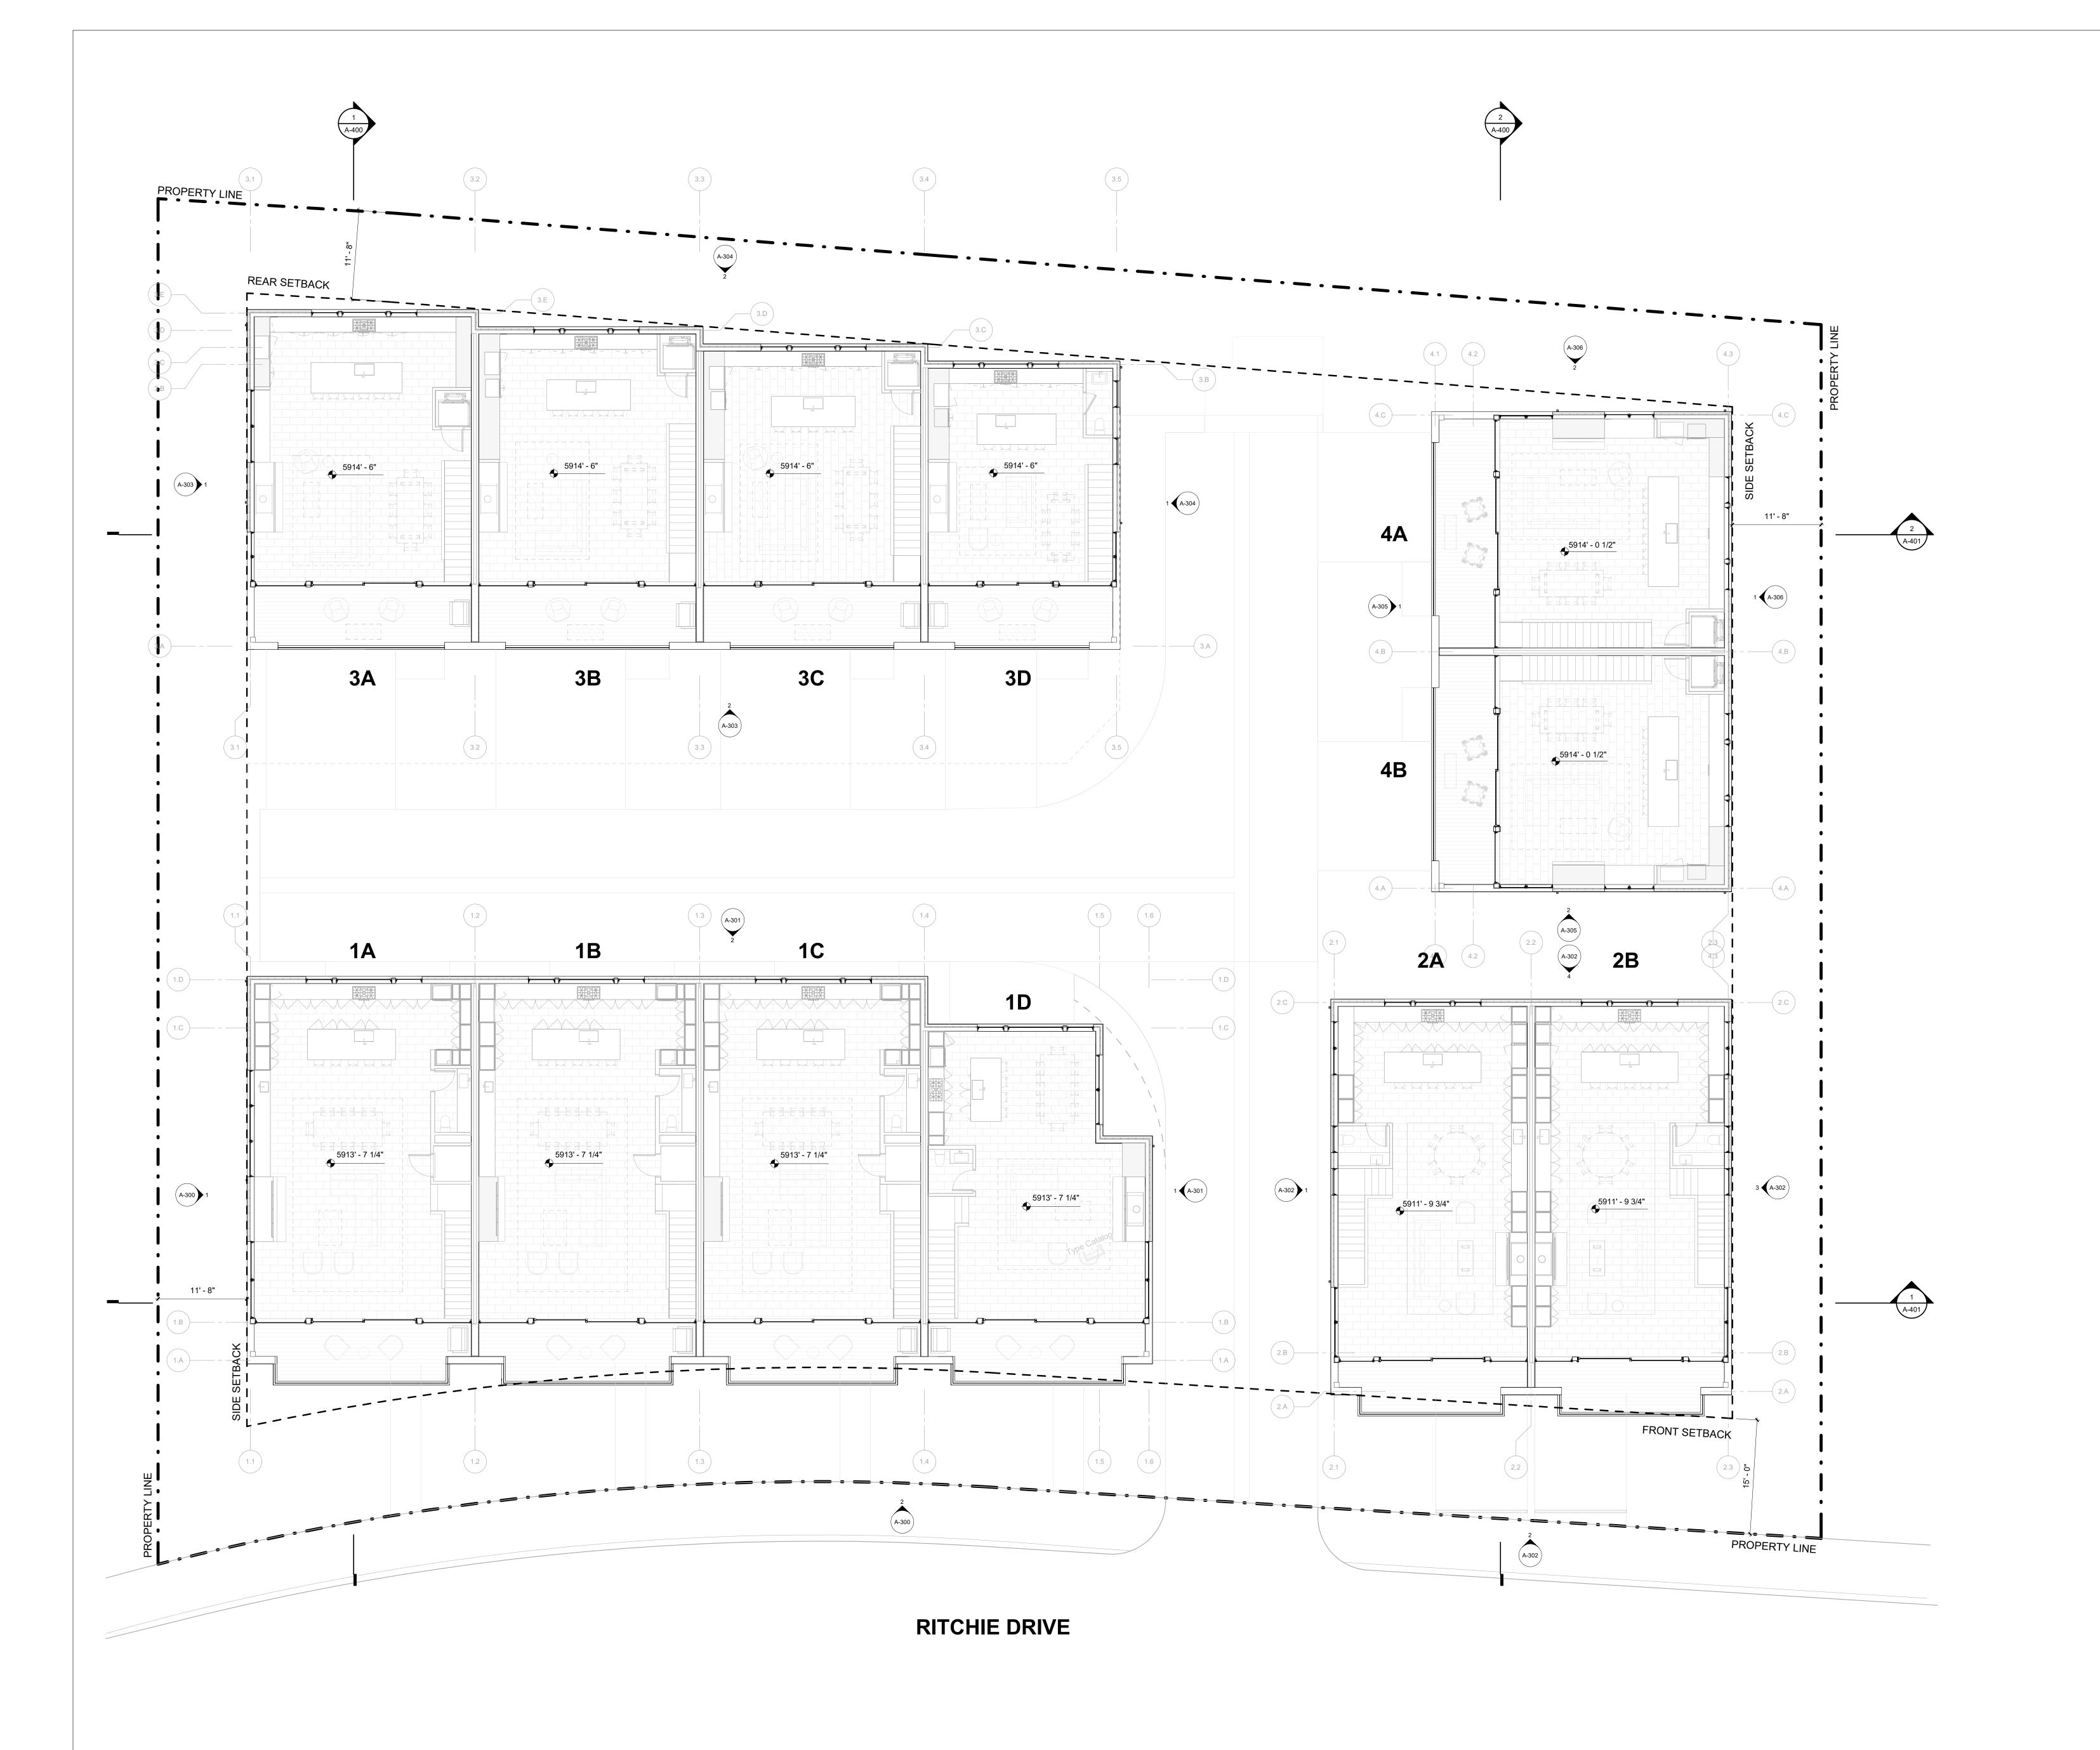

1/8" = 1'-0" **OVERALL PLAN - LEVEL 03**

WARM SPRINGS TOWNHOMES KETCHUM, ID

OWNER:

108-110 RITCHIE LLC P.O. BOX 14001-174 KETCHUM, ID 83340 TEL: 603.801.0419

BUILDING ARCHITECT:

RO | ROCKETT DESIGN 1031 W. MANCHESTER BLVD. UNIT 6 INGLEWOOD, CA 90301 TEL: 213.784.0014

STRUCTURAL ENGINEER:

ZFA STRUCTURAL ENGINEERS 601 MONTGOMERY STREET SUITE 1450 SAN FRANCISCO, CA 94111 TEL: 415.243.4091

MECHANICAL, ELECTRICAL, PLUMBING ENGINEER: PROFICIENT ENGINEERING 4704 HARLAN STREET SUITE 620 DENVER, CO 80212

TEL: 720.779.3556

CIVIL ENGINEER:

GALENA BENCHMARK ASSOCIATES 100 BELL DRIVE SUITE C KETCHUM, ID 83340 TEL: 208.726.9512

LANDSCAPE ARCHITECT:

EGGERS ASSOCIATES 560 NORTH 2ND AVENUE KETCHUM, ID 83340 TEL: 208.725.0988

DESCRIPTION DESIGN REVIEW APPLICATION 25.09.09

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WARM SPRINGS TOWNHOMES KETCHUM, ID 108 & 110 RITCHIE DR.


KETCHUM, IDAHO

DRAWING TITLE: LEVEL 03 OVERALL FLOOR

PROJECT NUMBER

DRAWING NUMBER:

A-103

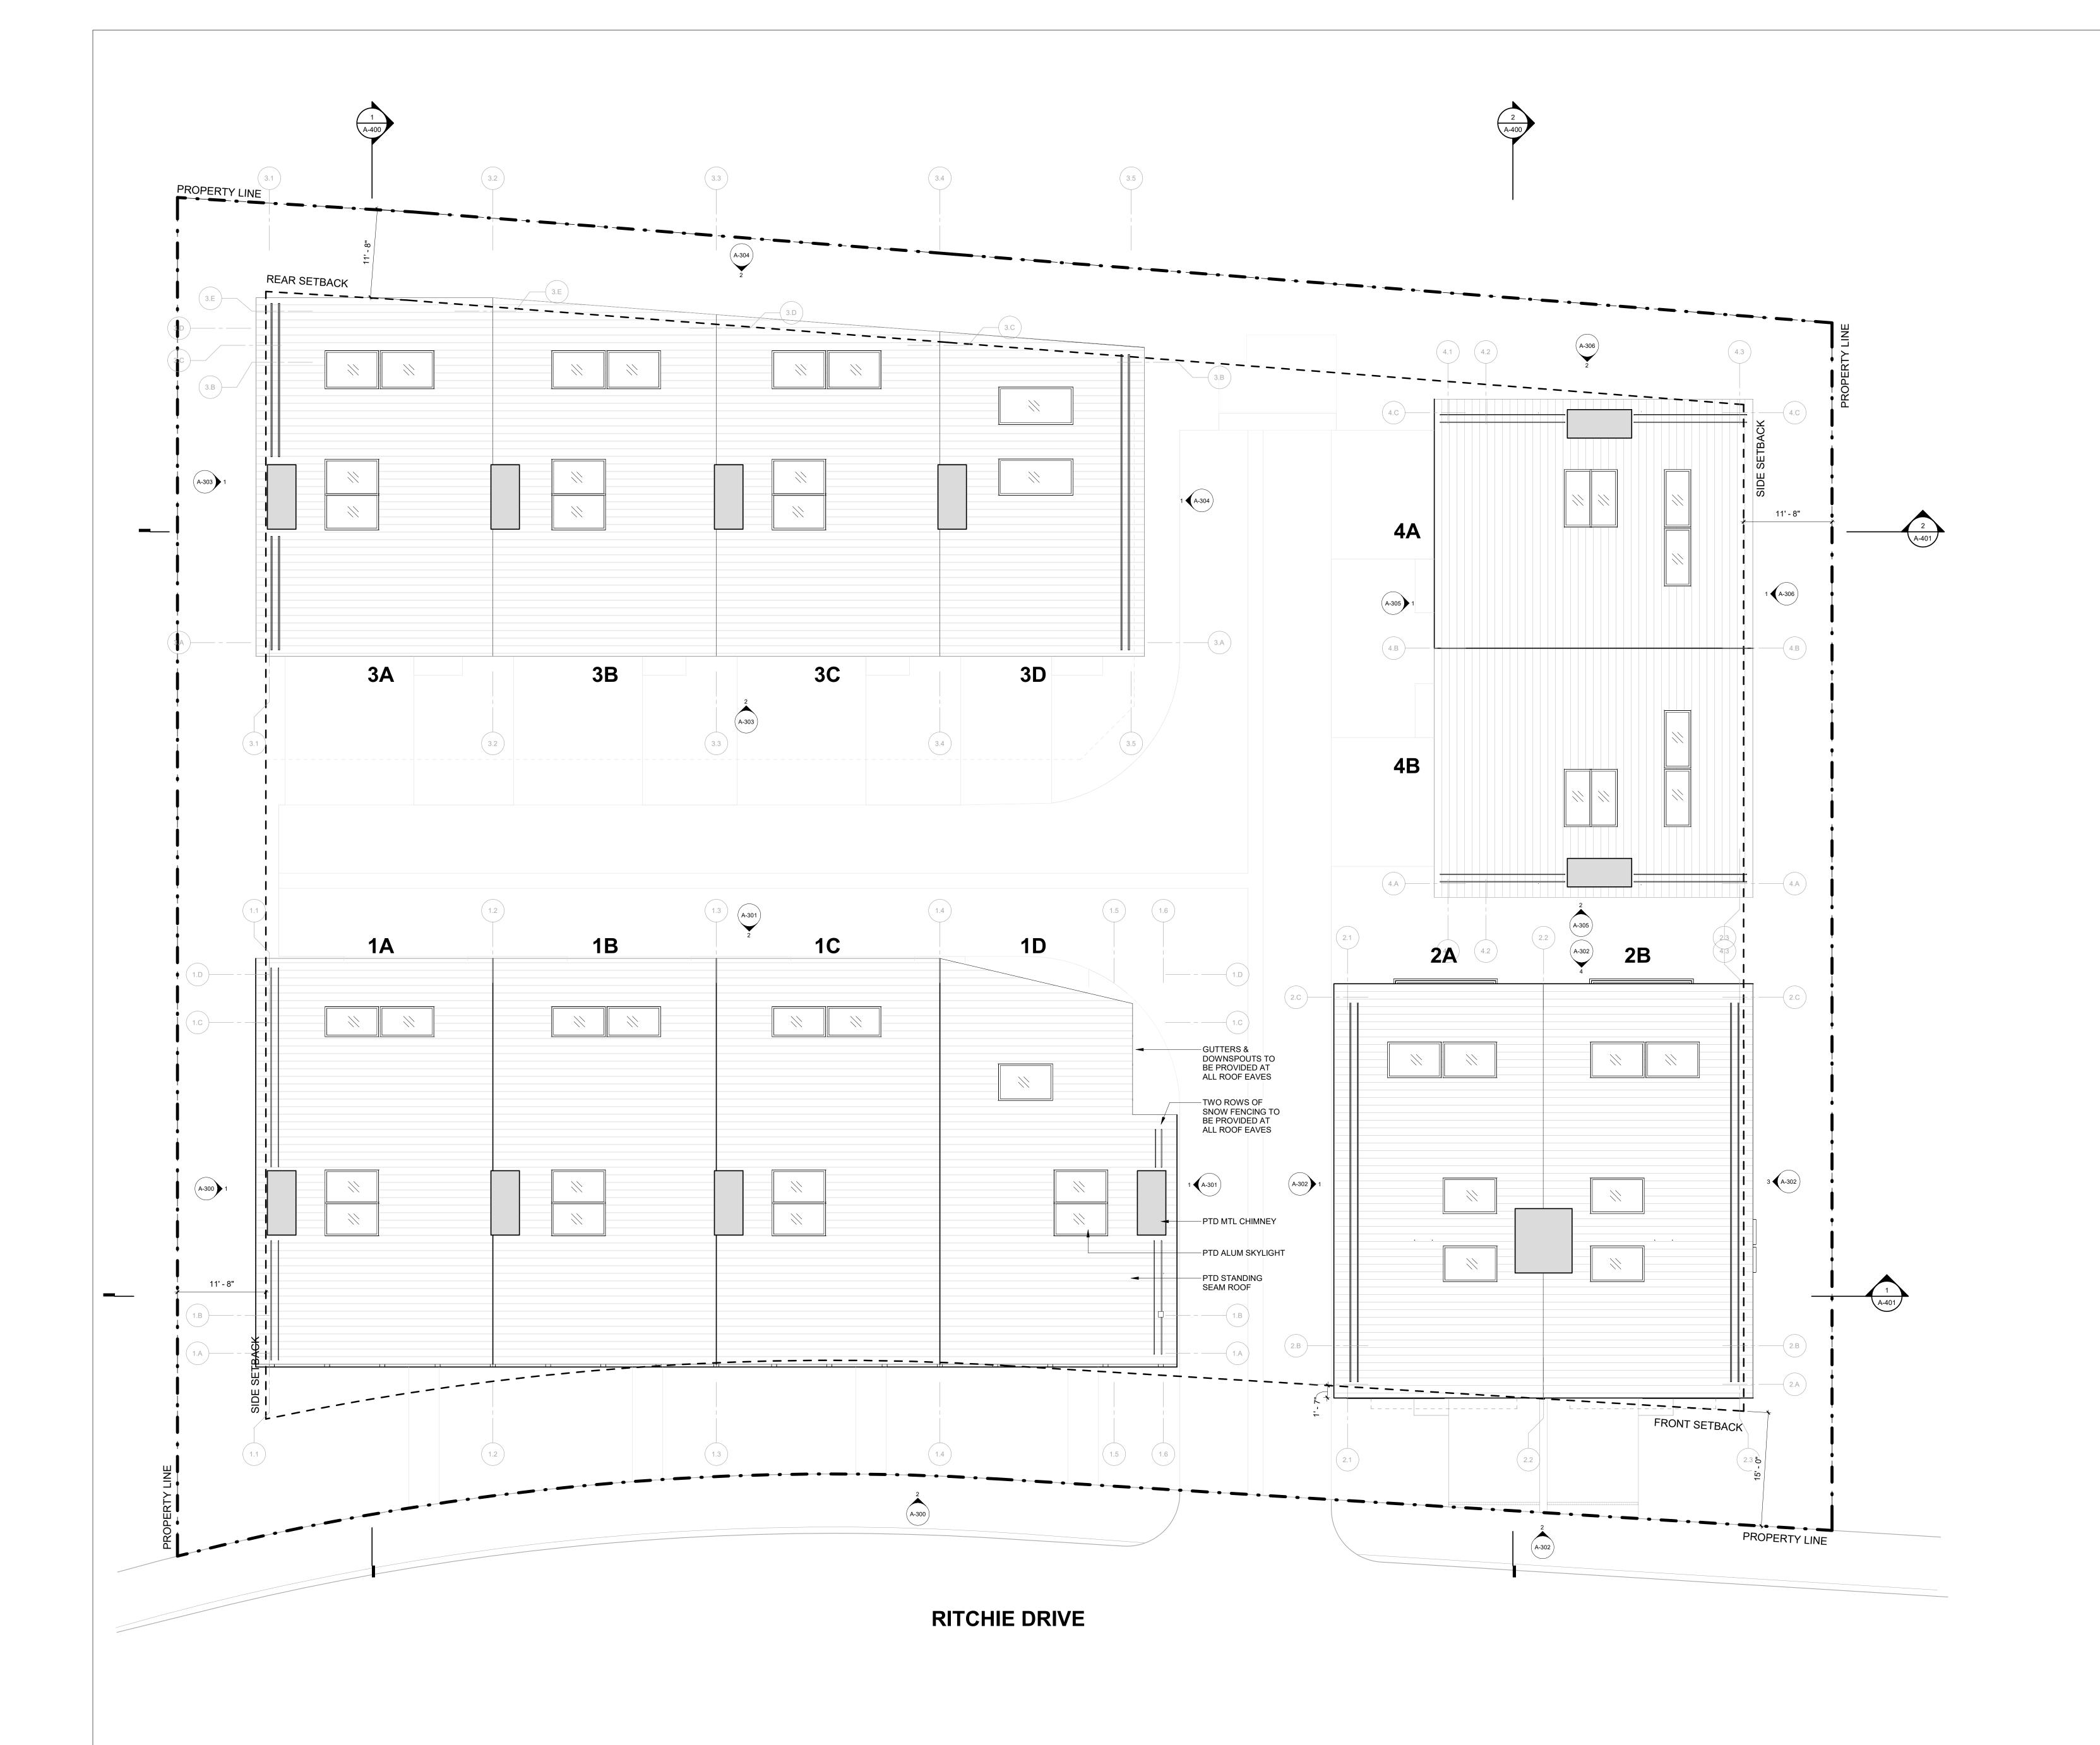

1 1/8" = 1'-0" **OVERALL PLAN - ROOF**

WARM SPRINGS TOWNHOMES KETCHUM, ID

OWNER:

108-110 RITCHIE LLC P.O. BOX 14001-174 KETCHUM, ID 83340 TEL: 603.801.0419

BUILDING ARCHITECT:

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STRUCTURAL ENGINEER:

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TEL: 415.243.4091

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4704 HARLAN STREET SUITE 620
DENVER, CO 80212

CIVIL ENGINEER:

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TEL: 720.779.3556

LANDSCAPE ARCHITECT:

EGGERS ASSOCIATES 560 NORTH 2ND AVENUE KETCHUM, ID 83340 TEL: 208.725.0988

E DESCRIPTION DATE
DESIGN REVIEW APPLICATION 25.09.09

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PROJECT:
WARM SPRINGS TOWNHOMES
KETCHUM, ID

108 & 110 RITCHIE DR. KETCHUM, IDAHO

DRAWING TITLE:

OVERALL ROOF PLAN

SEAL:

PROJECT NUMBER

A-104












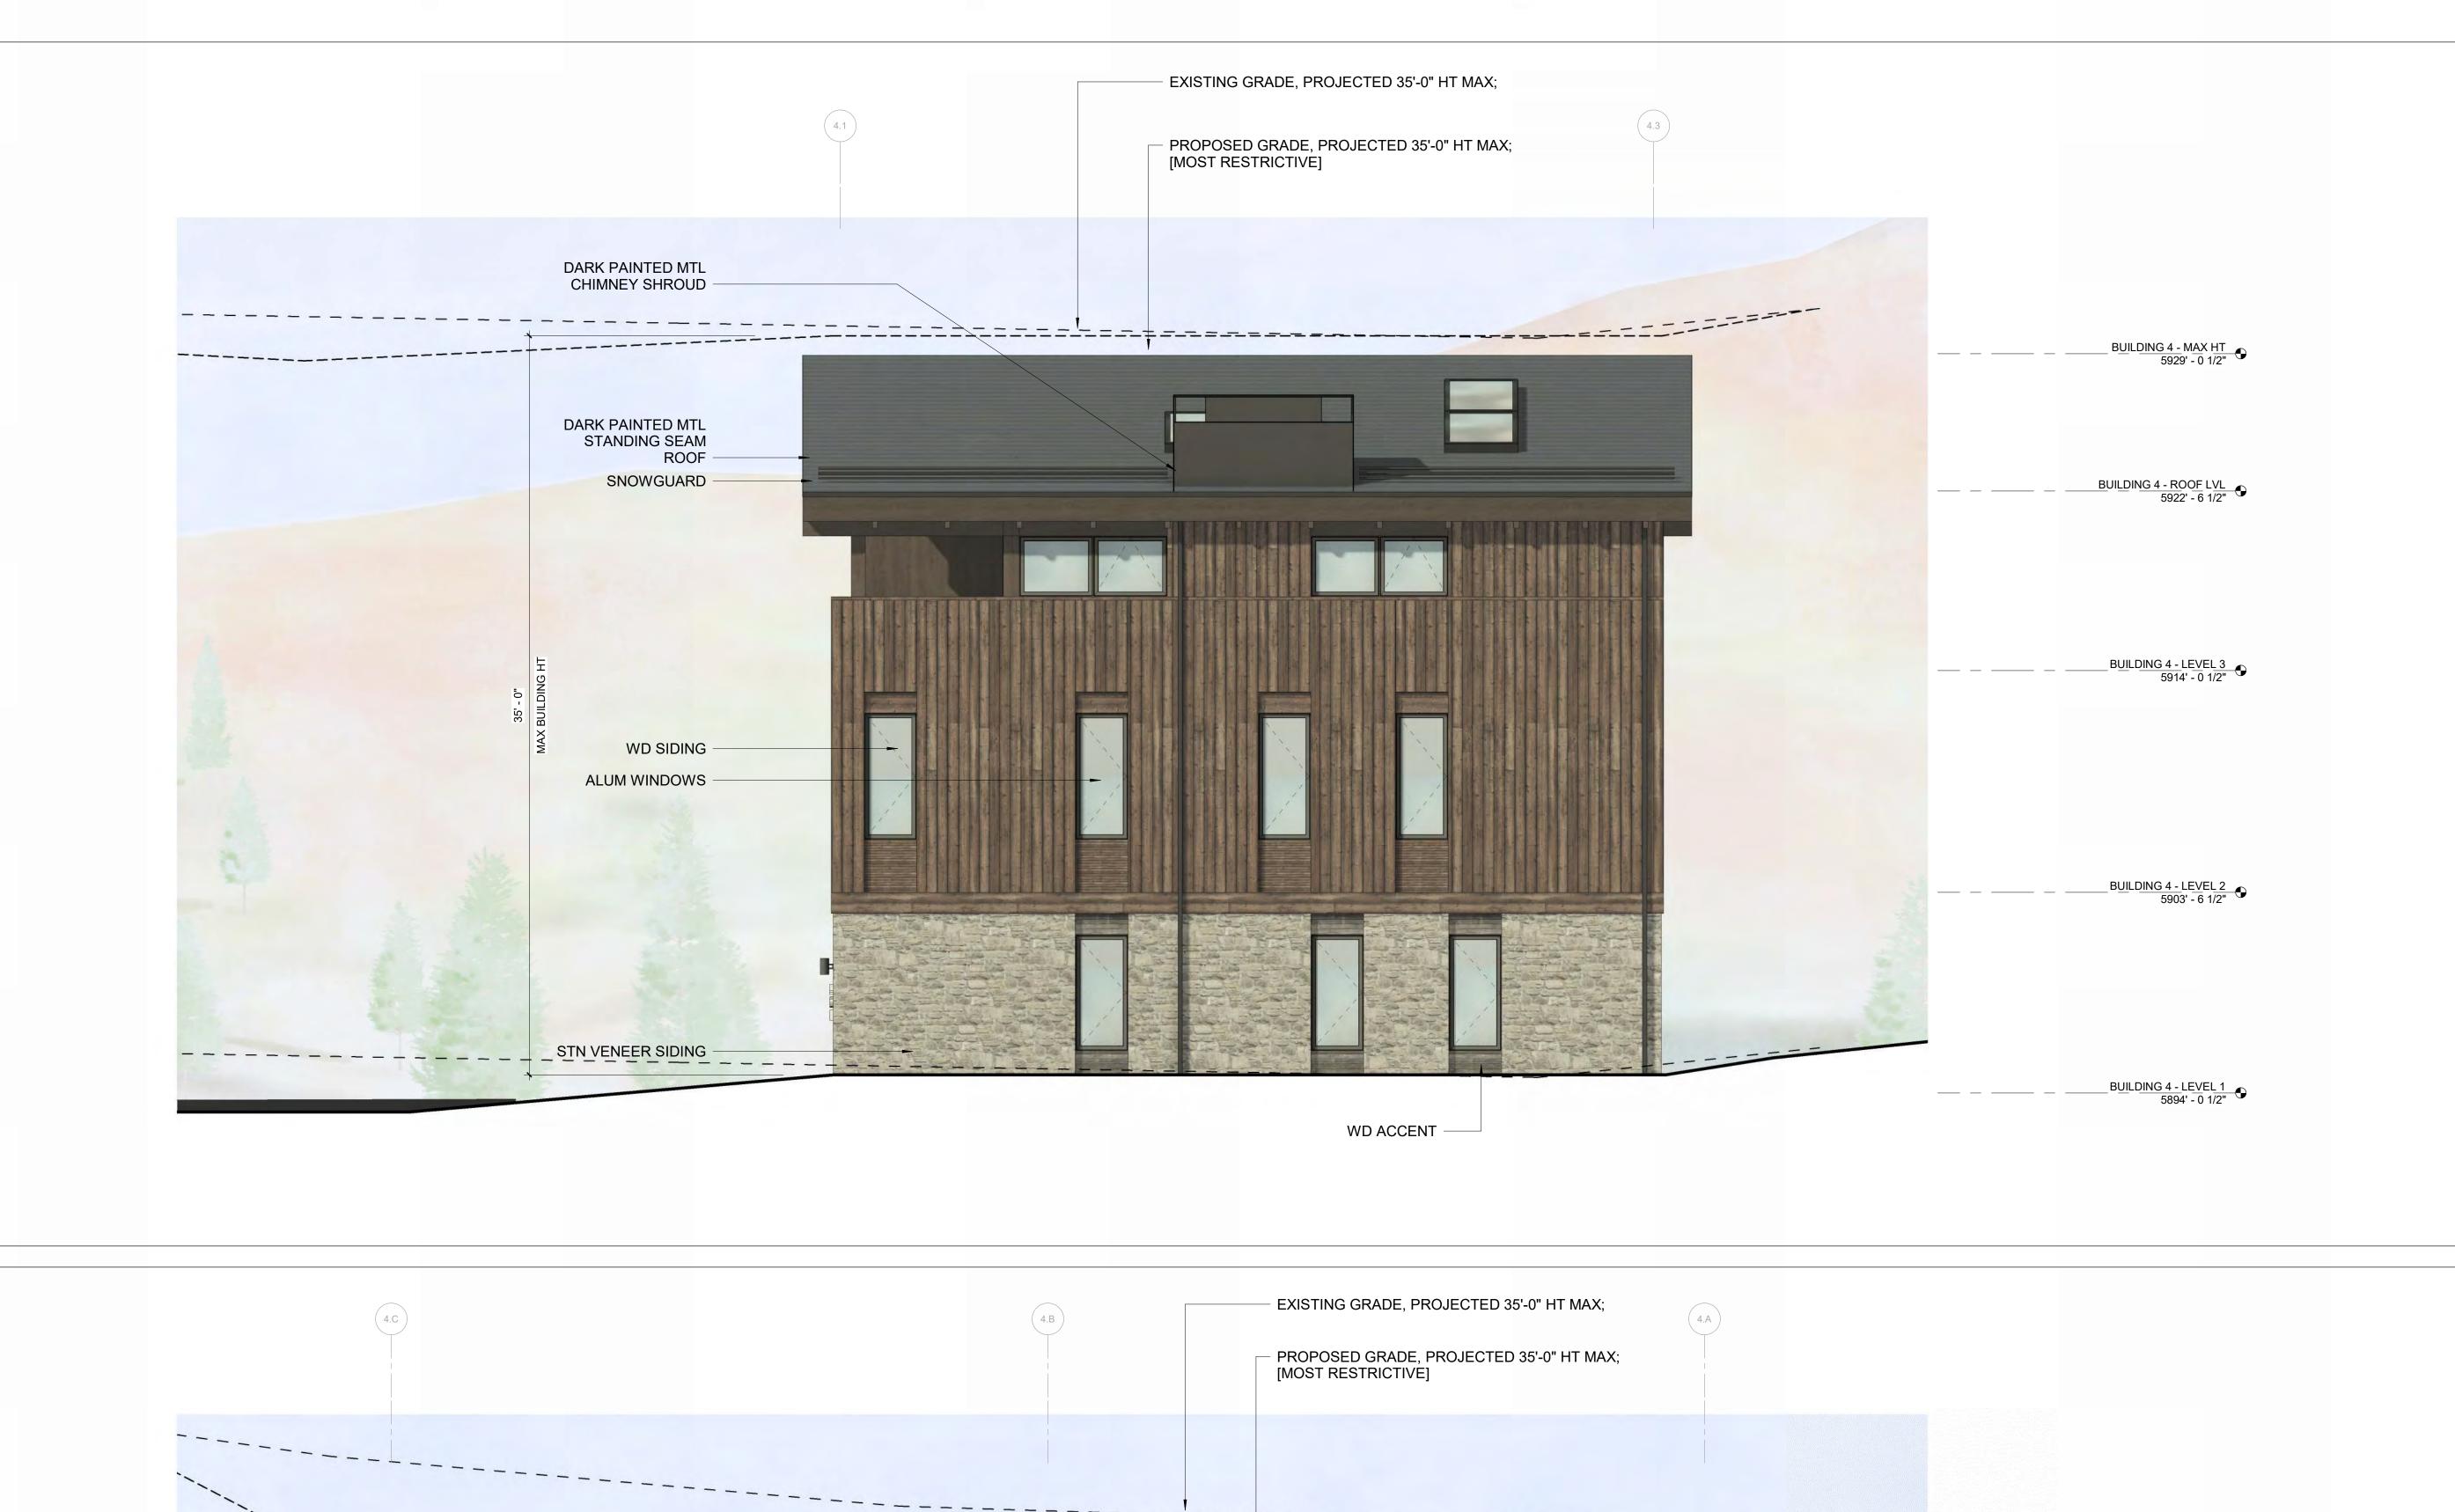

- WD ACCENT

2 1/4" = 1'-0" **BUILDING 4 / ELEVATION - EAST**

1 1/4" = 1'-0" **BUILDING 4 / ELEVATION - SOUTH**

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BUILDING 4 - MAX HT 5929' - 0 1/2"

BUILDING 4 - ROOF LVL 5922' - 6 1/2"

B<u>UILDING 4 - LEVEL 3</u>
5914' - 0 1/2"

B<u>UILDING 4 - LEVEL 2</u> 5903' - 6 1/2"

B<u>UILDING 4 - LEVEL 1</u>
5894' - 0 1/2"

- GL GUARDRAIL

WD SIDING

ALUM WINDOWS

STN VENEER SIDING

DARK SECTIONAL GARAGE DOOR

- DARK PAINTED MTL

UNIT ADDRESS

SHIELDED LIGHT FIXTURE

WARM SPRINGS

108-110 RITCHIE LLC P.O. BOX 14001-174 KETCHUM, ID 83340 TEL: 603.801.0419

TEL: 213.784.0014

TEL: 415.243.4091

DENVER, CO 80212 TEL: 720.779.3556

KETCHUM, ID 83340 TEL: 208.726.9512

EGGERS ASSOCIATES 560 NORTH 2ND AVENUE KETCHUM, ID 83340 TEL: 208.725.0988

RO | ROCKETT DESIGN 1031 W. MANCHESTER BLVD. UNIT 6 INGLEWOOD, CA 90301

ZFA STRUCTURAL ENGINEERS

MECHANICAL, ELECTRICAL, PLUMBING ENGINEER:

PROFICIENT ENGINEERING 4704 HARLAN STREET SUITE 620

GALENA BENCHMARK ASSOCIATES
100 BELL DRIVE SUITE C

601 MONTGOMERY STREET SUITE 1450 SAN FRANCISCO, CA 94111

TOWNHOMES

KETCHUM, ID


BUILDING ARCHITECT:


STRUCTURAL ENGINEER:

CIVIL ENGINEER:

LANDSCAPE ARCHITECT:

OWNER:

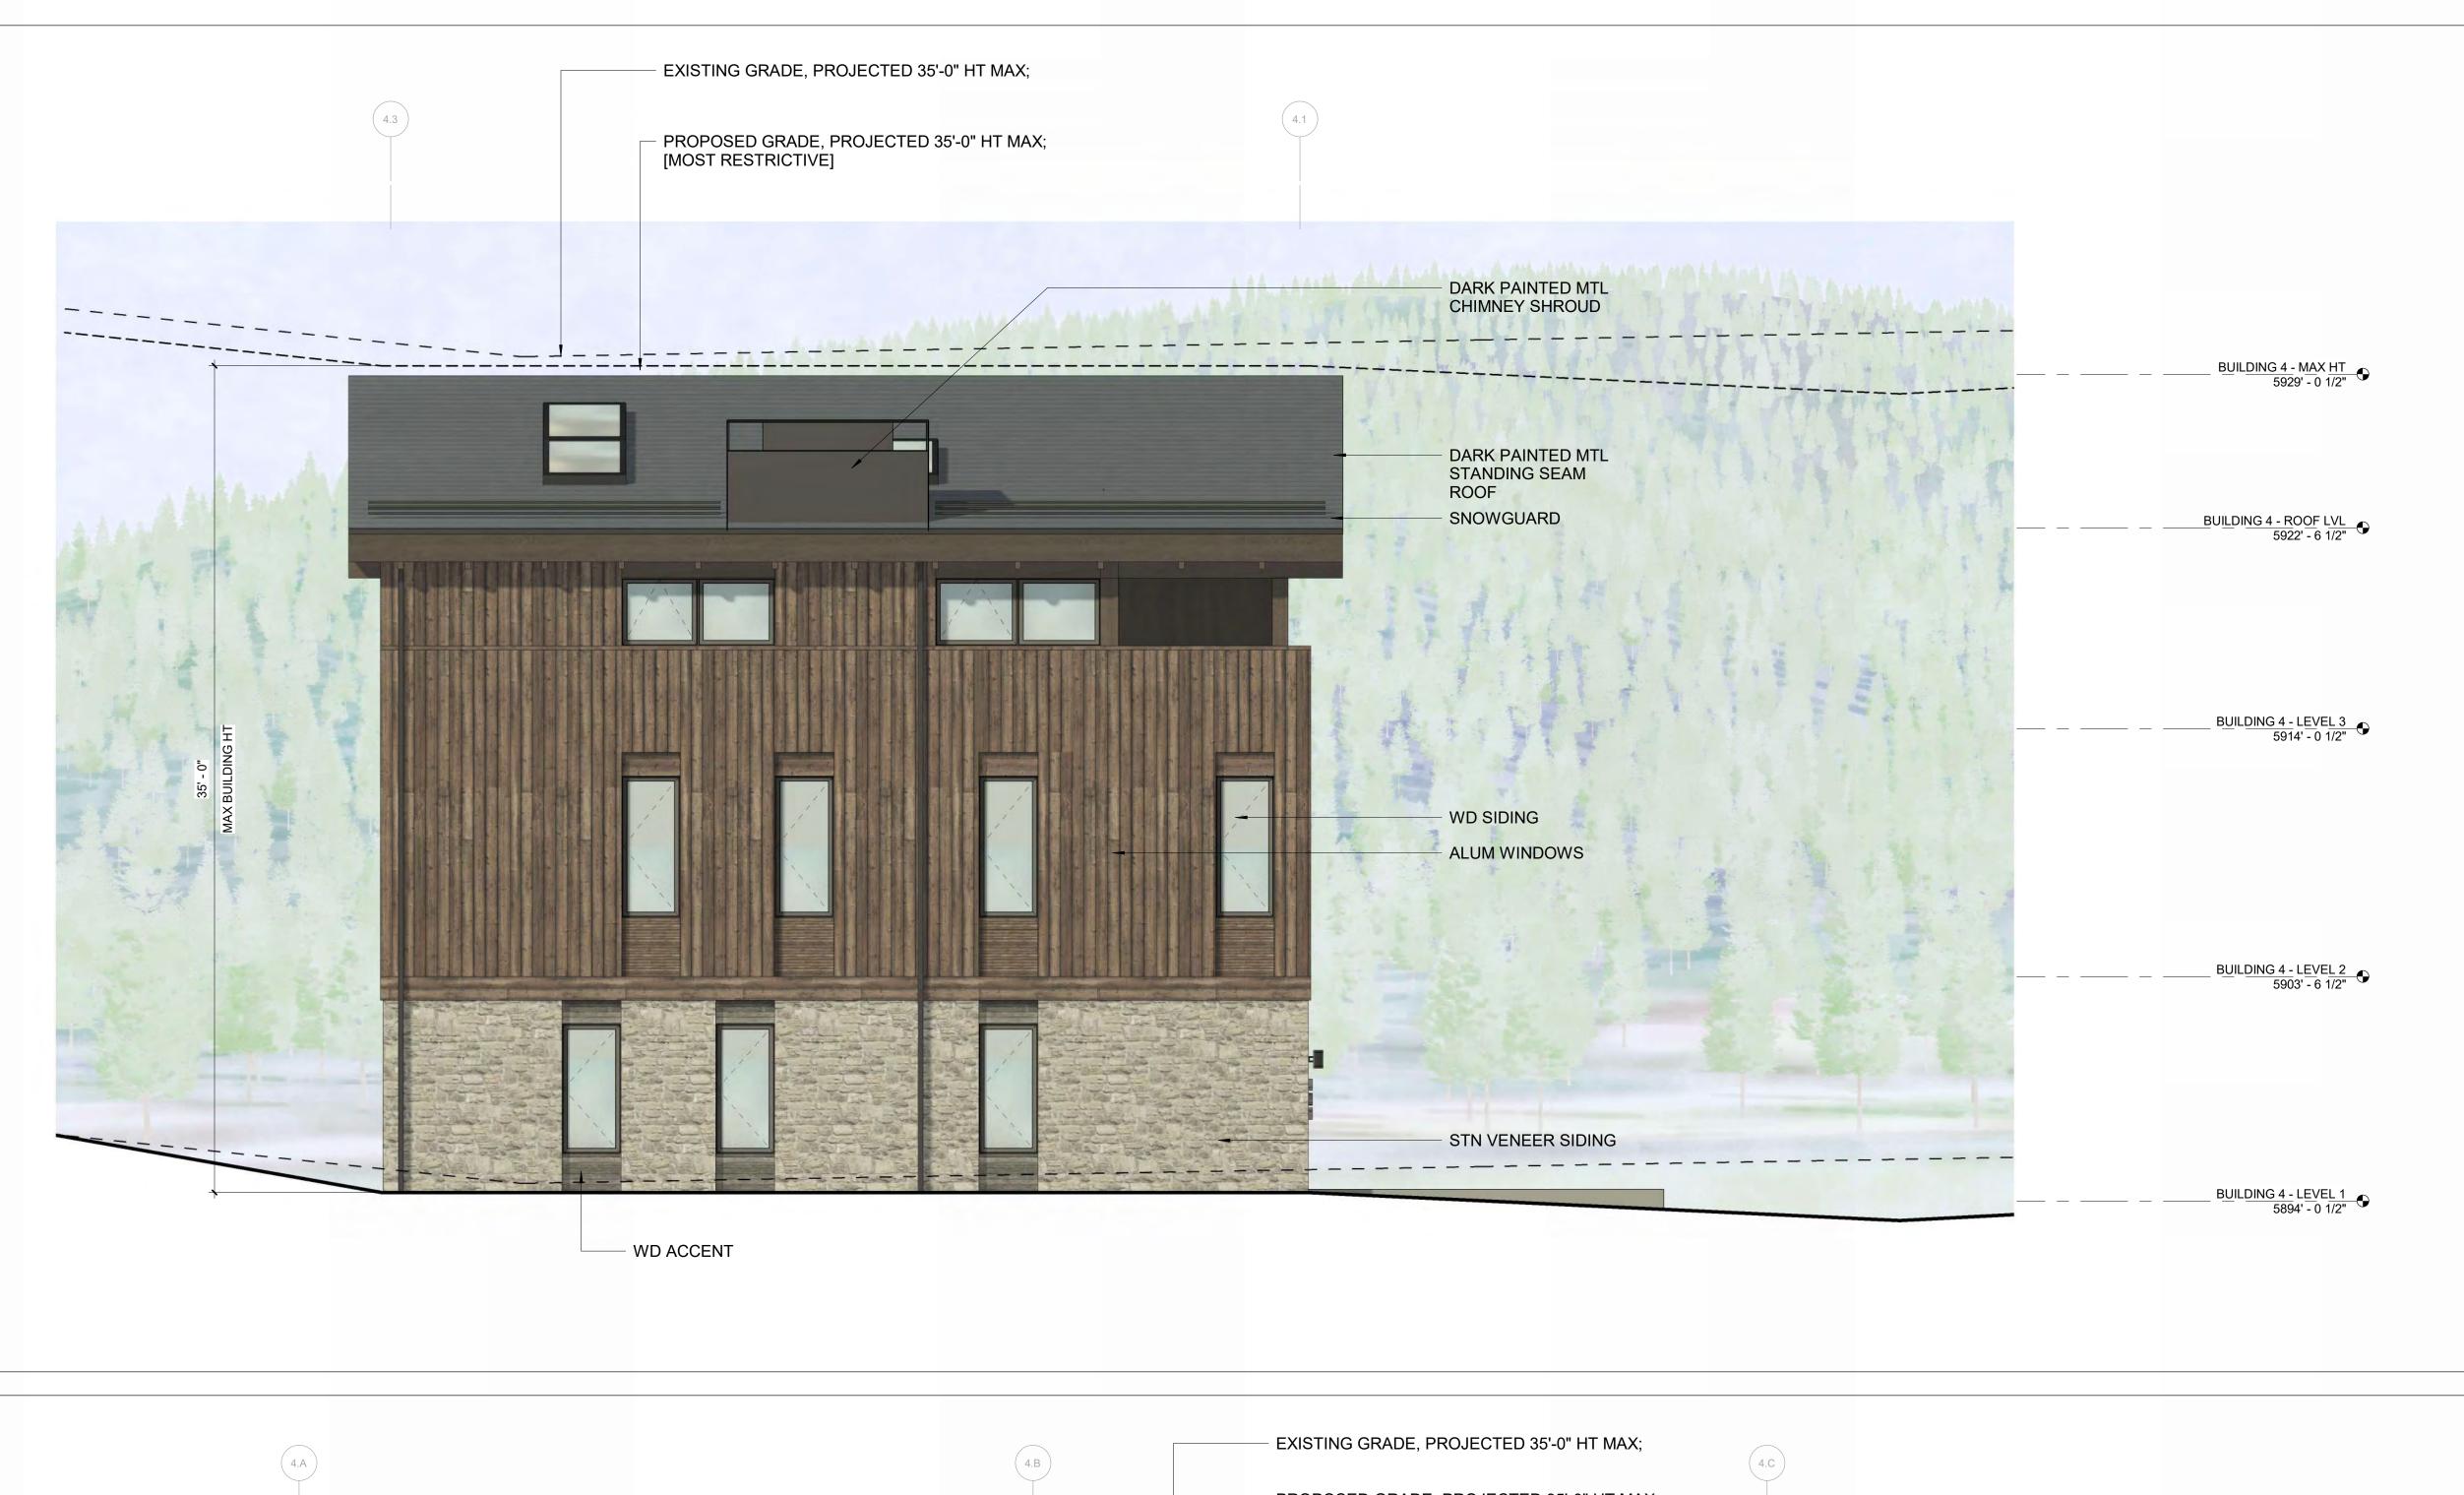

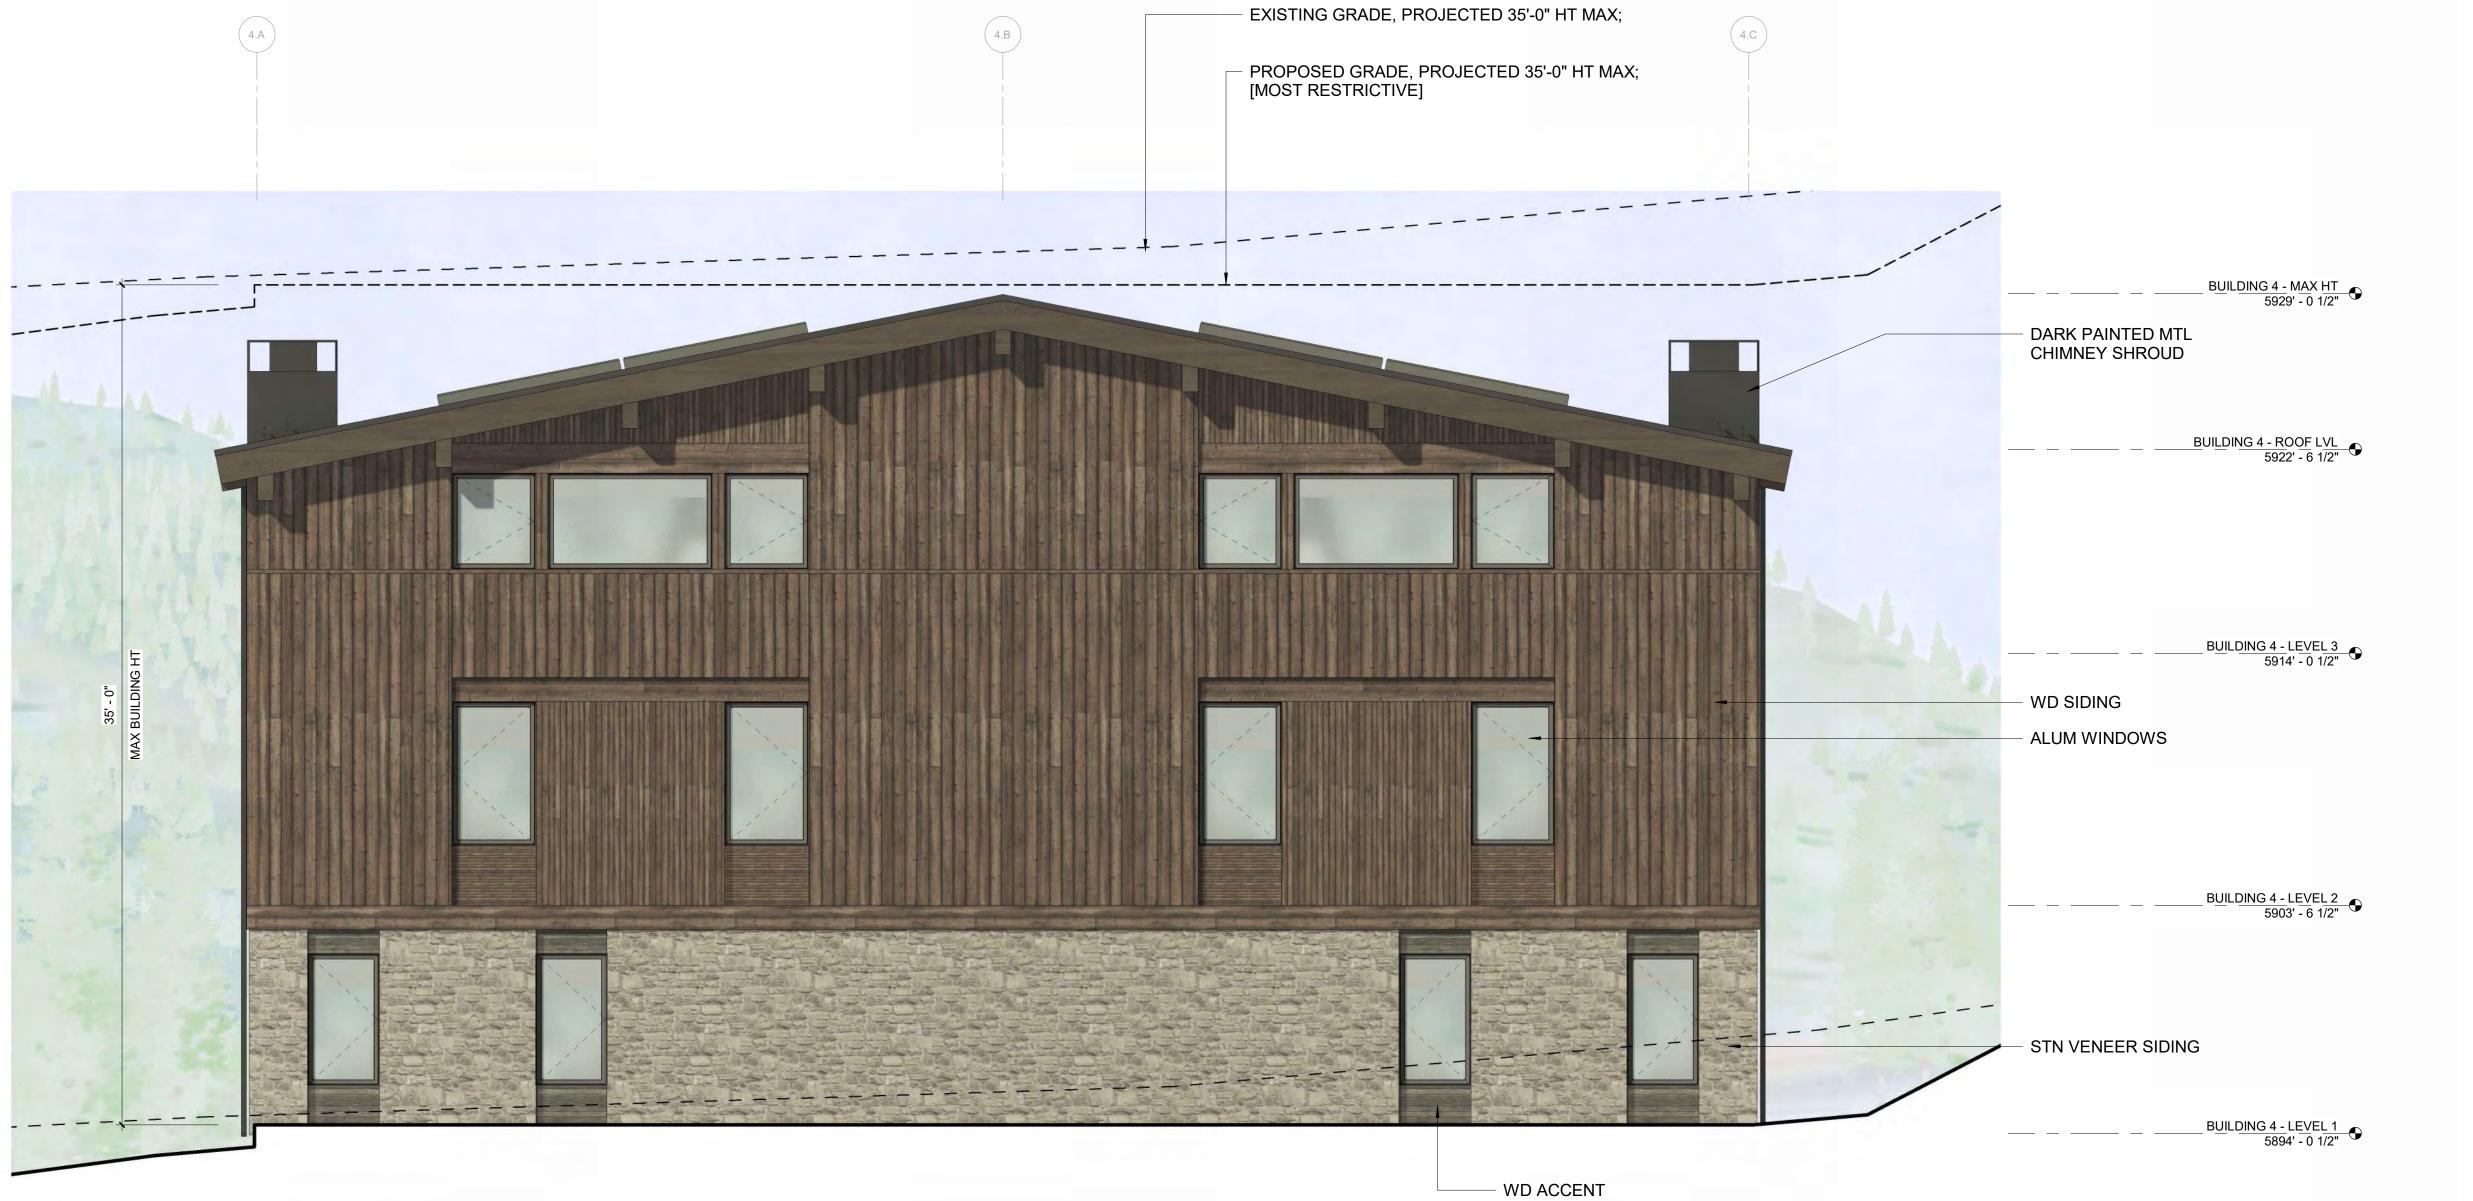

OWNER:

108-110 RITCHIE LLC P.O. BOX 14001-174 KETCHUM, ID 83340 TEL: 603.801.0419

BUILDING ARCHITECT:

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CIVIL ENGINEER:

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LANDSCAPE ARCHITECT:

EGGERS ASSOCIATES 560 NORTH 2ND AVENUE KETCHUM, ID 83340 TEL: 208.725.0988

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WARM SPRINGS TOWNHOMES KETCHUM, ID

108 & 110 RITCHIE DR. KETCHUM, IDAHO

DRAWING TITLE:
BUILDING ELEVATIONS BUILDING 4

SEAL:

PROJECT NUMBER


DRAWING NUMBER:

A-306

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1 1/4" = 1'-0" **BUILDING 4 / ELEVATION - NORTH**

2 1/4" = 1'-0" **BUILDING 4 / ELEVATION - WEST**



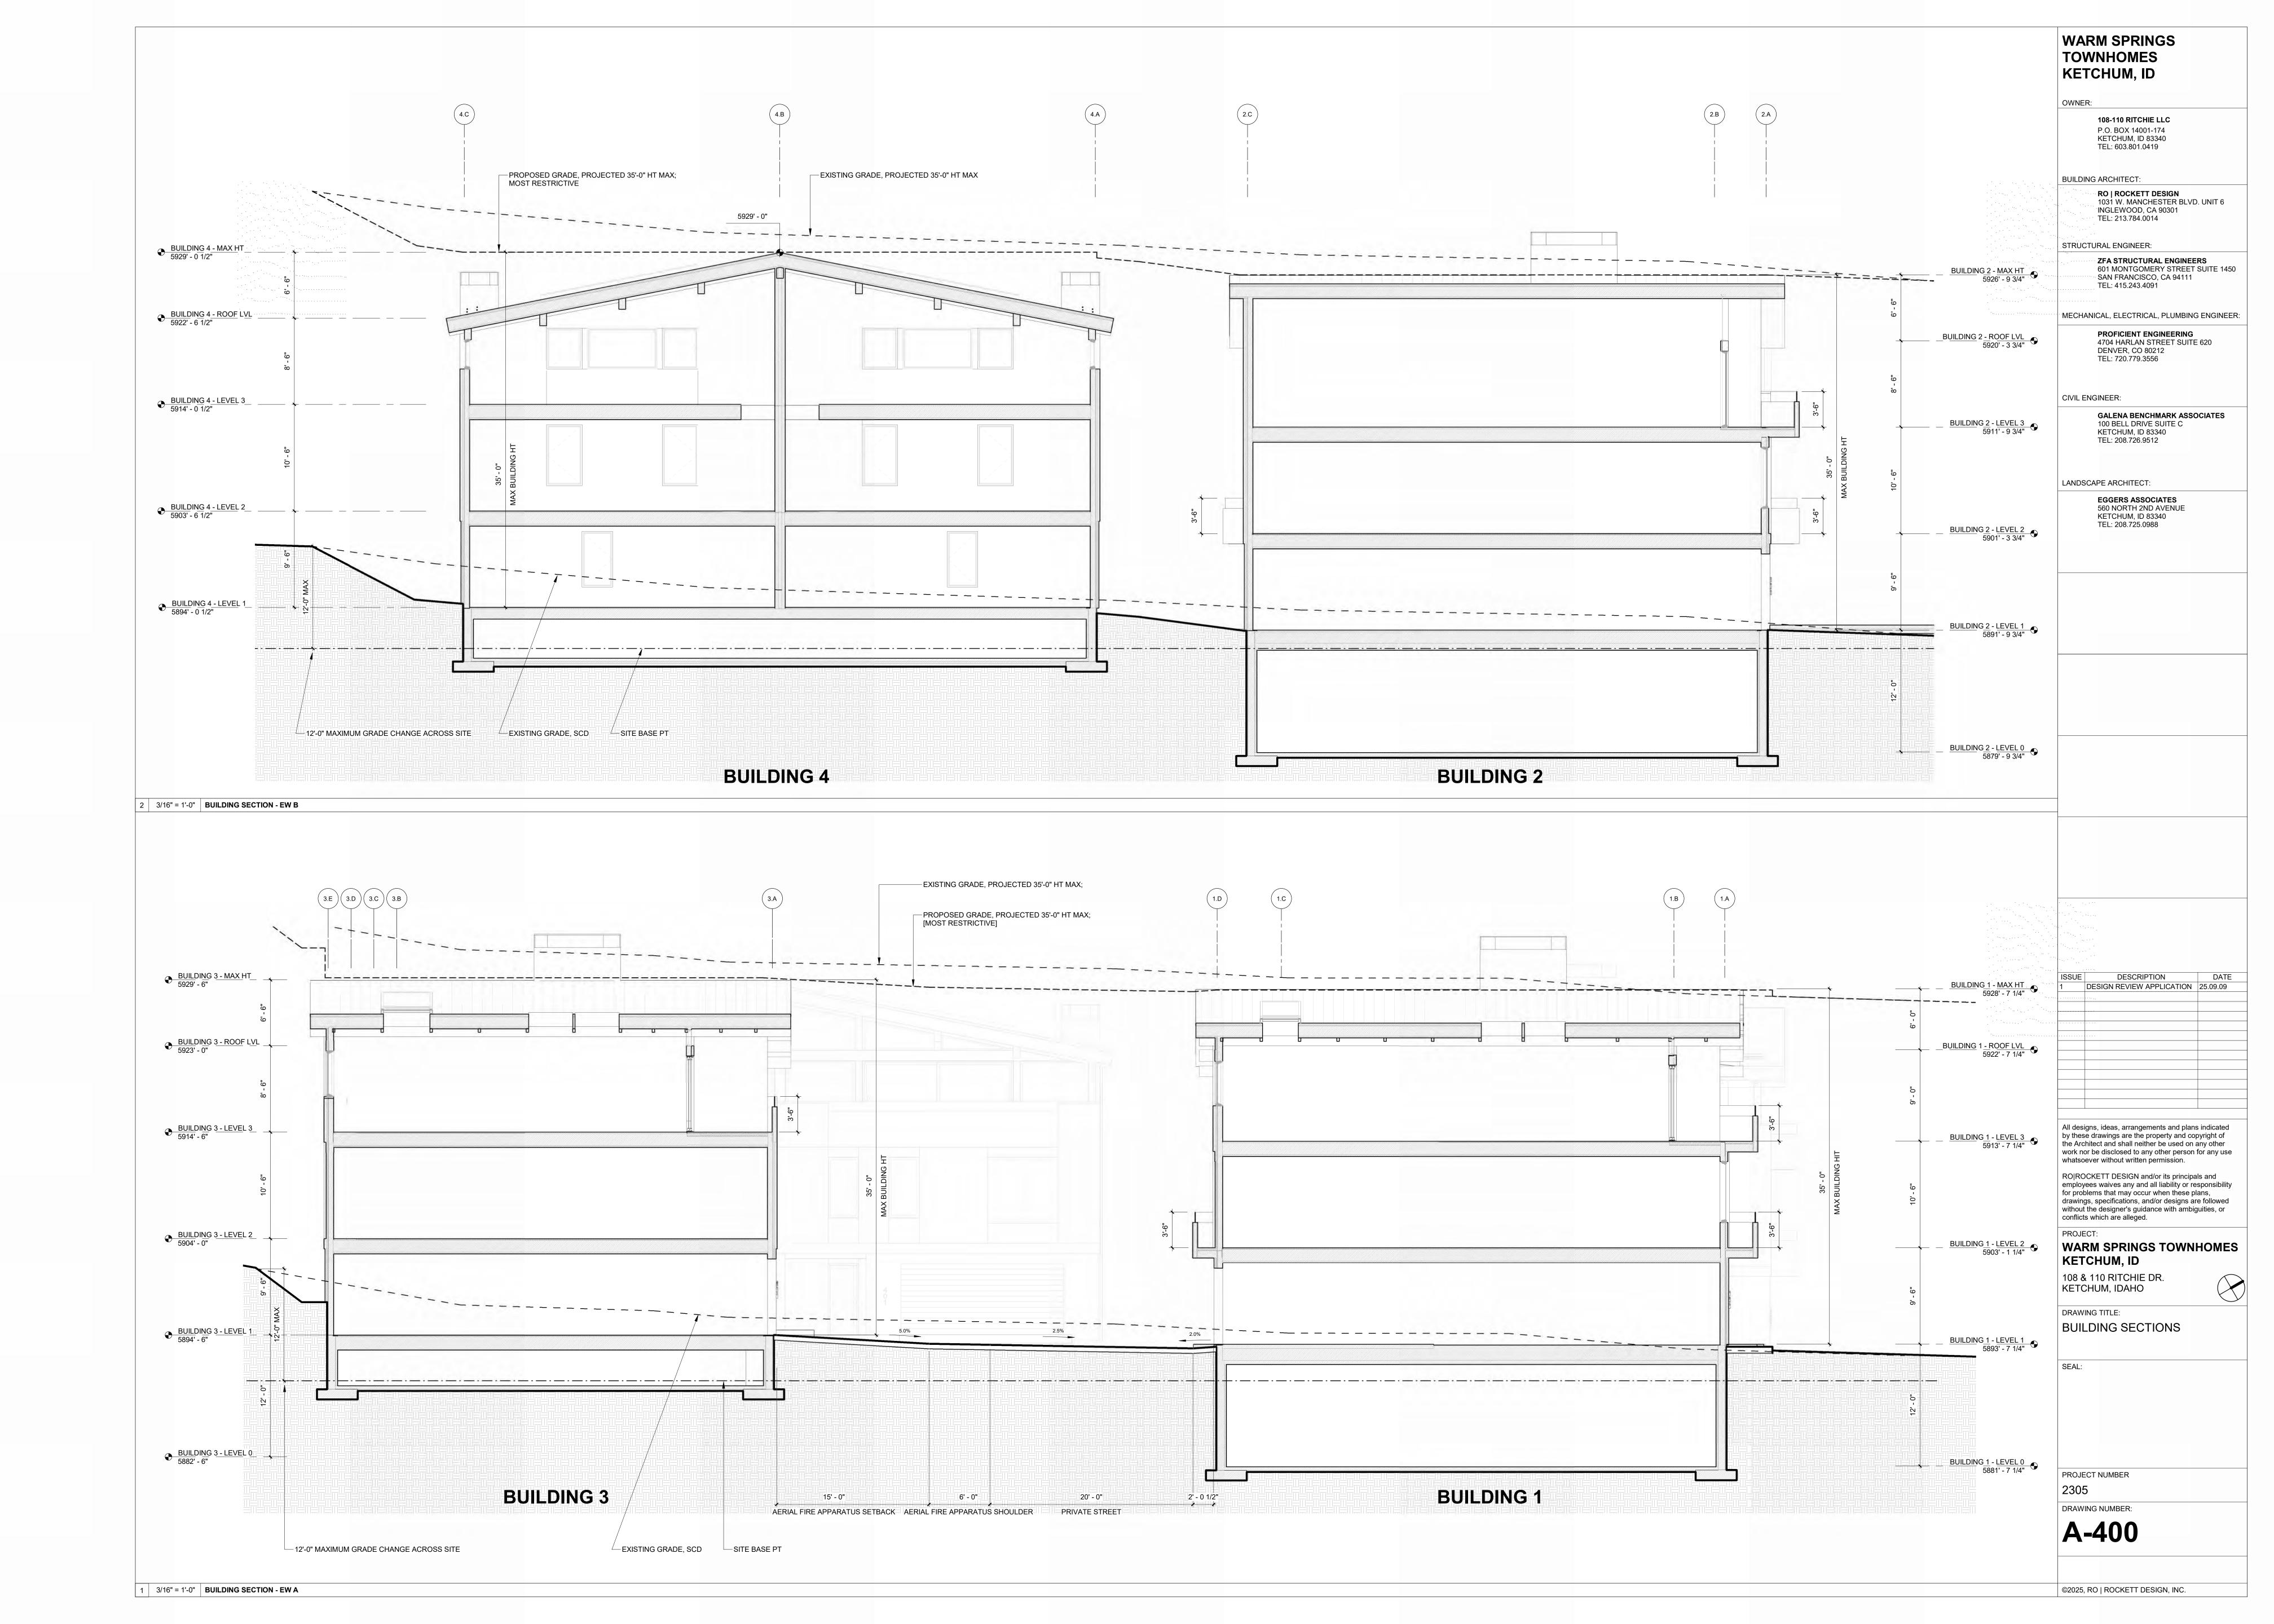





MEDIUM GREY, PARGED FIELD STONE



MEDIUM BROWN, RUSTIC TONGUE AND GROOVE WOOD SIDING W/ FACE NAILING



MEDIUM BROWN, RUSTIC WD BEAMS, FASCIA & ACCENTS



DARK, RUSTIC WD TONGUE AND GROOVE



DARK STANDING SEAM ROOF



DARK METAL TRIM & WINDOW FRAMES

OVAVA

108-110 RITCHIE LLC P.O. BOX 14001-174 KETCHUM, ID 83340 TEL: 603.801.0419

BUILDING ARCHITECT:

RO | ROCKETT DESIGN 1031 W. MANCHESTER BLVD. UNIT 6 INGLEWOOD, CA 90301 TEL: 213.784.0014

STRUCTURAL ENGINEER:

ZFA STRUCTURAL ENGINEERS601 MONTGOMERY STREET SUITE 1450
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CIVIL ENGINEER:

GALENA BENCHMARK ASSOCIATES 100 BELL DRIVE SUITE C KETCHUM, ID 83340 TEL: 208.726.9512

LANDSCAPE ARCHITECT:

EGGERS ASSOCIATES 560 NORTH 2ND AVENUE KETCHUM, ID 83340 TEL: 208.725.0988

SUE DESCRIPTION DATE
DESIGN REVIEW APPLICATION 25.09.09

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PROJECT:
WARM SPRINGS TOWNHOMES
KETCHUM, ID

108 & 110 RITCHIE DR. KETCHUM, IDAHO

DRAWING TITLE:

DRAWING TITLE:
MATERIALS

SEAL:

PROJECT NUMBER

DRAWING NUMBER:

A-500



108-110 RITCHIE LLC P.O. BOX 14001-174 KETCHUM, ID 83340 TEL: 603.801.0419

BUILDING ARCHITECT:

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STRUCTURAL ENGINEER:

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CIVIL ENGINEER:

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LANDSCAPE ARCHITECT:

EGGERS ASSOCIATES 560 NORTH 2ND AVENUE KETCHUM, ID 83340 TEL: 208.725.0988

2 12" = 1'-0" **SITE ELEVATION - EAST**



DESCRIPTION DESIGN REVIEW APPLICATION 25.09.09

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WARM SPRINGS TOWNHOMES KETCHUM, ID

108 & 110 RITCHIE DR. KETCHUM, IDAHO

DRAWING TITLE: RENDERED ELEVATIONS

PROJECT NUMBER

DRAWING NUMBER:

A-501



108-110 RITCHIE LLC P.O. BOX 14001-174 KETCHUM, ID 83340 TEL: 603.801.0419

BUILDING ARCHITECT:

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STRUCTURAL ENGINEER:

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CIVIL ENGINEER:

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LANDSCAPE ARCHITECT:

EGGERS ASSOCIATES 560 NORTH 2ND AVENUE KETCHUM, ID 83340 TEL: 208.725.0988

2 12" = 1'-0" **SITE ELEVATION - WEST**



DESCRIPTION DESIGN REVIEW APPLICATION 25.09.09

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WARM SPRINGS TOWNHOMES KETCHUM, ID

108 & 110 RITCHIE DR. KETCHUM, IDAHO

DRAWING TITLE:

RENDERED ELEVATIONS

PROJECT NUMBER

DRAWING NUMBER: A-502



VIEW FROM AERIAL PERSPECTIVE



WARM SPRINGS TOWNHOMES KETCHUM, ID

108-110 RITCHIE LLC P.O. BOX 14001-174 KETCHUM, ID 83340 TEL: 603.801.0419

BUILDING ARCHITECT:

RO | ROCKETT DESIGN 1031 W. MANCHESTER BLVD. UNIT 6 INGLEWOOD, CA 90301 TEL: 213.784.0014

STRUCTURAL ENGINEER:

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TEL: 415.243.4091

MECHANICAL, ELECTRICAL, PLUMBING ENGINEER:

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CIVIL ENGINEER:

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LANDSCAPE ARCHITECT:

EGGERS ASSOCIATES 560 NORTH 2ND AVENUE KETCHUM, ID 83340 TEL: 208.725.0988

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WARM SPRINGS TOWNHOMES KETCHUM, ID

108 & 110 RITCHIE DR.

KETCHUM, IDAHO

DRAWING TITLE: PERSPECTIVE RENDERINGS

SEAL:

PROJECT NUMBER

DRAWING NUMBER:

A-503

VIEW FROM RITCHIE DRIVE - NORTH



VIEW FROM RITCHIE DRIVE - SOUTH



WARM SPRINGS TOWNHOMES KETCHUM, ID

108-110 RITCHIE LLC P.O. BOX 14001-174 KETCHUM, ID 83340 TEL: 603.801.0419

BUILDING ARCHITECT:

RO | ROCKETT DESIGN 1031 W. MANCHESTER BLVD. UNIT 6 INGLEWOOD, CA 90301 TEL: 213.784.0014

STRUCTURAL ENGINEER:

ZFA STRUCTURAL ENGINEERS 601 MONTGOMERY STREET SUITE 1450 SAN FRANCISCO, CA 94111 TEL: 415.243.4091

MECHANICAL, ELECTRICAL, PLUMBING ENGINEER:

PROFICIENT ENGINEERING
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DENVER, CO 80212 TEL: 720.779.3556

CIVIL ENGINEER:

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LANDSCAPE ARCHITECT:

EGGERS ASSOCIATES 560 NORTH 2ND AVENUE KETCHUM, ID 83340 TEL: 208.725.0988

DESCRIPTION DESIGN REVIEW APPLICATION 25.09.09

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WARM SPRINGS TOWNHOMES KETCHUM, ID

108 & 110 RITCHIE DR. KETCHUM, IDAHO

DRAWING TITLE: PERSPECTIVE RENDERINGS

PROJECT NUMBER

DRAWING NUMBER:

A-504



VIEW TO BUILDING 01 - REAR



WARM SPRINGS TOWNHOMES KETCHUM, ID

OVAVAU

108-110 RITCHIE LLC P.O. BOX 14001-174 KETCHUM, ID 83340 TEL: 603.801.0419

BUILDING ARCHITECT:

RO | ROCKETT DESIGN 1031 W. MANCHESTER BLVD. UNIT 6 INGLEWOOD, CA 90301 TEL: 213.784.0014

STRUCTURAL ENGINEER:

ZFA STRUCTURAL ENGINEERS 601 MONTGOMERY STREET SUITE 1450 SAN FRANCISCO, CA 94111 TEL: 415.243.4091

MECHANICAL, ELECTRICAL, PLUMBING ENGINEER:

PROFICIENT ENGINEERING 4704 HARLAN STREET SUITE 620 DENVER, CO 80212 TEL: 720.779.3556

CIVIL ENGINEER:

GALENA BENCHMARK ASSOCIATES 100 BELL DRIVE SUITE C KETCHUM, ID 83340 TEL: 208.726.9512

LANDSCAPE ARCHITECT:

EGGERS ASSOCIATES 560 NORTH 2ND AVENUE KETCHUM, ID 83340 TEL: 208.725.0988

DESCRIPTION DATE
DESIGN REVIEW APPLICATION 25.09.09

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WARM SPRINGS TOWNHOMES KETCHUM, ID

108 & 110 RITCHIE DR. KETCHUM, IDAHO

DRAWING TITLE:

PERSPECTIVE RENDER!

PERSPECTIVE RENDERINGS

DRAWING NUMBER:

A-505

PROJECT NUMBER

VIEW TO BUILDING 03 - FRONT