

# 450 WOOD RIVER DR

# FLOODPLAIN DEVELOPMENT PERMIT APPLICATION RESUBMITTAL - 4.16.24

DESCRIPTION
APPROX. 6,600 SF (CONDITIONED) NEW SINGLE-FAMILY RESIDENCE WITH 823 SF GARAGE. SCOPE OF WORK INCLUDES NEW CONSTRUCTION OF FOUNDATION, ERECTION OF STRUCTURE, CIVIL, LANDSCAPING, HARDSCAPING AND FINISHES.

# KETCHUM, ID 83340

APPLICABLE CODES
All construction shall comply with:

2018 INTERNATIONAL BUILDING CODE\*

2018 INTERNATIONAL RESIDENTIAL CODE\*

2018 INTERNATIONAL FIRE CODE WITH LOCAL AMENDMENTS\*

2018 INTERNATIONAL ENERGY CONSERVATION CODE\* 2018 INTERNATIONAL SWIMMING POOL AND SPA CODE

2018 INTERNATIONAL EXISTING BUILDING CODE 2018 INTERNATIONAL PROPERTY MAINTENANCE CODE NATIONAL GREEN BUILDING STANDARD [SILVER CERTIFICATION]

TITLE 15 KETCHUM MUNICIPAL CODE APPENDIX M OF THE IBC AS AMENDED BY THE CITY OF KETCHUM

ALL APPLICABLE COUNTY ORDINANCES

+FULLY-SPRINKLERED NFPA 13D THROUGHOUT

\*AS AMENDED BY THE IDAHO BUILDING CODE BOARD AND INCLUDING NOTED APPENDICES.

JURISDICTIONAL AGENCY SHALL BE THE KETCHUM BUILDING DEPARTMENT.

CONTRACTOR SHALL KEEP A COPY OF THE ABOVE CODE SECTIONS ON THE JOB SITE AT ALL

DEFERRED SUBMITTALS
FIRE SPRINKLERS

LOT AREA: **ZONING DESIGNATION:** 

LAND USE: OCCUPANCY: CONSTRUCTION TYPE: OVERLAYS: FLOOD ZONE (FEMA):

PROPOSED DEVELOPMENT BUILDING COVERAGE:

MAXIMUM BUILDING HEIGHT:

10.0% (SEE G-011 FOR CALCULATIONS) ALLOWABLE - 35'-0"

GR-L GENERAL RESIDENTIAL LOW DENSITY

LOT 3, BK 1

TYPE V

FLOODPLAIN

SFHA-ZONE AE

54,219 SF (1.24 AC.)

120 (VACANT, SINGLE FAMILY)


R-3 - SINGLE FAMILY DWELLING

PARKING SPACES:

| GROSS FLOOR AREA       |          |  |  |  |  |  |
|------------------------|----------|--|--|--|--|--|
| LEVEL 01               | 4,668 SF |  |  |  |  |  |
| LEVEL 02               | 3,409 SF |  |  |  |  |  |
| TOTAL                  | 8,077 SF |  |  |  |  |  |
|                        |          |  |  |  |  |  |
| CONDITIONED FLOOR AREA |          |  |  |  |  |  |
| LEVEL 01               | 3,365 SF |  |  |  |  |  |
| LEVEL 02               | 3,182 SF |  |  |  |  |  |
| TOTAL                  | 6,547 SF |  |  |  |  |  |
| GARAGE                 | 886 SF   |  |  |  |  |  |
| MECH                   | 643 SF   |  |  |  |  |  |

# REQUIRED SETBACKS FRONT YARD:

15'-0" 11'-0" (PER 17.20.030) SIDE YARD: REAR YARD: 11'-0" (PER 17.20.030)

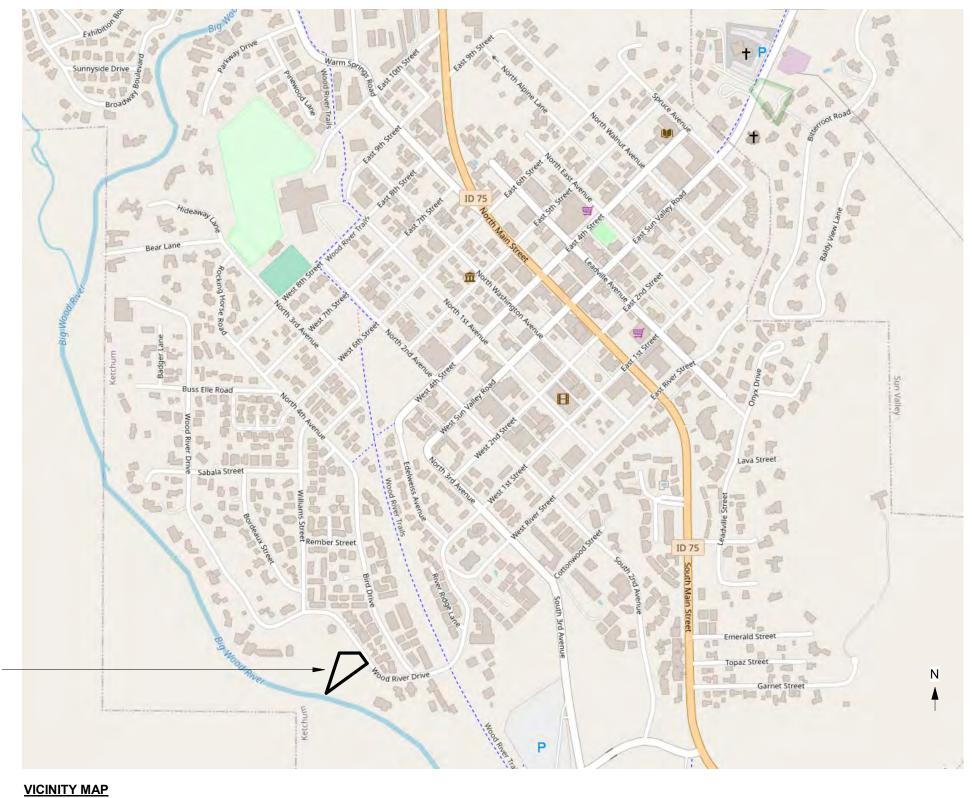

PROJECT SITE-

# **450 WOOD RIVER**

450-490 WOOD RIVER, LLC ATTN: FRAZIER CAVNESS P.O. BOX 14001-174 KETCHUM, ID 83340

PROJECT ARCHITECT: RO | ROCKETT DESIGN

1031 W. MANCHESTER BLVD. UNIT 6 INGLEWOOD, CA 90301 TEL: 213.784.0014

CONTRACTOR:

GEOTECHNICAL ENGINEER:

**BUTLER ASSOCIATES, INC.** P.O. BOX 1034

KETCHUM, ID 83340

TEL: 208.720.6432 CIVIL ENGINEER:

BENCHMARK ASSOCIATES 100 BELL DRIVE KETCHUM, ID 83340

TEL: 208.726.9512 LANDSCAPE ARCHITECT:

FIELD STUDIO LANDSCAPE ARCHITECTS 722 N. ROUSE AVENUE BOZEMAN. MT 59715

STRUCTURAL ENGINEER: LABIB FUNK & ASSOCIATES 319 MAIN STREET

TEL: 406.551.2098

EL SEGUNDO, CA 90245 TEL: 213.239.9700

BOZEMAN, MT 59715 TEL: 406.272.0352

MEP ENGINEER: CONSULTING ENGINEERING SERVICES (CES) 1001 W OAK BLDG


LIGHTING: KGM ARCHITECTURAL LIGHTING 270 CORAL CIRCLE EL SEGUNDO, CA 90245 TEL: 310.552.2191

AUDIO VIDEO SYSTEMS, INC. 2700 HOMESTEAD RD PARK CITY, UT 84098 TEL: 801.649.5200

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waives any and all liability or responsibility for problems that may occur when these plans, drawings, specifications, and/or designs are followed without the designer's guidance with

All designs, ideas, arrangements and plans indicated

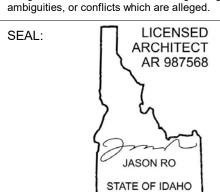

FDP APP RESUBMITTAL 1 04.16.2024 12.13.2023 FDP APPLICATION NO DATE ISSUE

PROJECT:

**450 WOOD RIVER** 450 WOOD RIVER DRIVE KETCHUM, ID 83340

PROJECT NUMBER

2108

DRAWING TITLE: **COVER SHEET** 

DRAWING NUMBER:

G-000

NOT FOR CONSTRUCTION

DOCUMENTS AND SHALL AT ONCE REPORT TO THE OWNER/DESIGNER IN WRITING ALL ERRORS, INCONSISTENCIES OR OMISSIONS DISCOVERED AND VERIFY ALL DIMENSIONS ON SITE PRIOR TO COMMENCING THE WORK. IF THE CONTRACTOR KNOWINGLY PROCEEDS WITH ANY OF THE WORK SO AFFECTED WITHOUT WRITTEN INSTRUCTION OF THE OWNER/DESIGNER, THE CONTRACTOR SHALL MAKE GOOD AT HIS OWN COST ANY RESULTING ERROR, DAMAGE, OR DEFECTS OR TIME DELAYS CAUSED. THE CONTRACTOR SHALL PERFORM NO PORTION OF THE WORK WITHOUT CONTRACT DOCUMENTS OR, WHERE REQUIRED, APPROVED SHOP DRAWINGS, PRODUCT DATA OR SAMPLES FOR

SUCH PORTION OF WORK. 3. NO WORK TO COMMENCE ON SITE UNTIL PLAN HAS BEEN APPROVED AND PERMIT ISSUED BY THE DEPARTMENT OF BUILDINGS.

4. ALL STRUCTURAL WORK SHALL BE COORDINATED W/ DESIGN DRAWINGS AND SHALL CONFORM TO THE PROJECT SPECIFICATIONS AND APPLICABLE BUILDING CODES.

5. ALL MECHANICAL AND ELECTRICAL WORK SHALL BE DESIGN BUILD, FILED BY THE CONTRACTOR. RELATED FILINGS SHALL ALSO BE COORDINATED AND EXECUTED BY THE CONTRACTOR. ANY DISCREPANCIES BETWEEN THE ENGINEERED SYSTEMS AND THE DESIGN DRAWINGS SHALL BE BROUGHT TO THE ATTENTION OF THE DESIGNER IMMEDIATELY, PRIOR TO ANY CONSTRUCTION OR PURCHASING OF MATERIAL

6. CONTRACTOR SHALL PROVIDE TEMPORARY SHORING, BRACING, SHEETING AND MAKE SAFE ALL FLOORS, ROOFS, WALLS AND ADJACENT PROPERTY AS PROJECT CONDITIONS REQUIRE. SHORING AND SHEETING SHALL BE DESIGNED BY A STATE OF CALIFORNIA LICENSED PROFESSIONAL ENGINEER HIRED BY THE CONTRACTOR, WHO SHALL SUBMIT SHOP DRAWINGS AND CALCULATIONS FOR THE OWNER'S

7. DIMENSIONS AND ELEVATIONS OF EXISTING CONSTRUCTION GIVEN IN STRUCTURAL DRAWINGS ARE BASED ON INFORMATION CONTAINED IN VARIOUS ORIGINAL DESIGN AND CONSTRUCTION DOCUMENTS PROVIDED BY THE OWNER, AND LIMITED FIELD OBSERVATIONS AND MEASUREMENTS. THE CONTRACTOR SHALL VERIFY ALL INFORMATION PERTAINING TO EXISTING CONDITIONS BY ACTUAL MEASUREMENT AND OBSERVATION AT THE SITE. ALL DISCREPANCIES BETWEEN ACTUAL CONDITIONS AND THOSE SHOWN IN THE CONTRACT DOCUMENTS SHALL BE REPORTED TO THE DESIGNER OF RECORD FOR HIS EVALUATION BEFORE THE AFFECTED CONSTRUCTION IS PUT IN PLACE.

8. PRODUCTS: TRADE NAMES OR MANUFACTURERS NOTED WITHIN DRAWINGS AND/OR SPECIFICATIONS ARE TO ESTABLISH A STANDARD OF QUALITY: CONTRACTOR MAY SUBMIT OTHER MANUFACTURERS PRODUCTS EQUAL TO THOSE SPECIFIED FOR APPROVAL. 9. THE CONTRACTOR SHALL MAKE NO DEVIATION FROM THE DRAWINGS WITHOUT WRITTEN APPROVAL OF

THE DESIGNER. 10. THE CONTRACTOR SHALL GUARANTEE ALL WORK PERFORMED UNDER THIS CONTRACT FOR A PERIOD OF ONE YEAR AFTER COMPLETION AND FINAL ACCEPTANCE BY THE OWNER.

11. THE CONTRACTOR SHALL INSPECT EXISTING CONDITIONS AT JOB SITE BEFORE SUBMITTING BID. CONTRACTOR WILL BE RESPONSIBLE FOR ALL CONDITIONS ON SITE WHETHER INDICATED ON DRAWINGS OR NOT. SUBMISSION OF A PROPOSAL SHALL SIGNIFY THE CONTRACTOR'S ACCEPTANCE OF THE CONTRACT DOCUMENTS AND EXISTING CONDITIONS.

12. CONTRACTOR MUST CONDUCT A PRE-DEMOLITION MEETING AND SITE WALKTHROUGH WITH THE OWNER AND ARCHITECT BEFORE THE COMMENCEMENT OF ANY DEMOLITION OR REMOVAL OF

13. THE WORK TO BE PERFORMED CONSISTS OF FURNISHING ALL LABOR, EQUIPMENT, TOOLS, TRANSPORTATION, SUPPLIES, FEES, MATERIALS, AND SERVICES IN ACCORDANCE WITH THESE NOTES AND DRAWINGS; AND INCLUDES PERFORMING ALL OPERATIONS NECESSARY TO CONSTRUCT AND INSTALL COMPLETE, IN SATISFACTORY CONDITION, THE VARIOUS MATERIALS AND EQUIPMENT AT THE LOCATIONS SHOWN.

14. THE CONTRACTOR SHALL TAKE ALL NECESSARY PRECAUTIONS TO INSURE THE SAFETY OF THE BUILDING, ITS OCCUPANTS, AND THE GENERAL PUBLIC.

15. PROVIDE ALL WORK INDICATED OR IMPLIED BY THE DRAWINGS. 16. SUBMIT SHOP DRAWINGS TO DESIGNER FOR REVIEW. DO NOT COMMENCE WORK UNTIL REVIEW OF SHOP DRAWINGS HAS BEEN COMPLETED AND THE DRAWINGS APPROVED. ALLOW TEN (10) BUSINESS DAYS MIN FOR REVIEW.

17. THE CONTRACTOR SHALL PROVIDE ALL NECESSARY PROTECTION FOR HIS WORK UNTIL TURNED OVER TO THE OWNER. 18. THE GENERAL CONSTRUCTION NOTES AND/OR DRAWINGS ARE SUPPLIED TO ILLUSTRATE THE DESIGN AND THE GENERAL TYPE OF CONSTRUCTION DESIRED AND ARE INTENDED TO IMPLY THE FINEST

QUALITY OF CONSTRUCTION, MATERIAL AND WORKMANSHIP THROUGHOUT 19. THE CONTRACTOR SHALL MAKE ALL REQUIRED ARRANGEMENTS FOR DELIVERY OF MATERIALS. 20. BUILDING CONDITIONS, INCLUDING SIZE OF SERVICE ELEVATORS, DOORWAYS, STAIRS, CORRIDORS,

WINDOW OPENINGS, ETC., SHALL BE CHECKED FOR ITEMS BEING DELIVERED. 21. THE CONTRACTOR SHALL BE RESPONSIBLE FOR SECURING THE PREMISES EACH EVENING PRIOR TO LEAVING THE JOB SITE. THE SITE SHALL REMAIN LOCKED AND SECURED AT ALL TIMES WHEN THE GENERAL CONTRACTOR IS NOT ON SITE AND KEYS FOR THE SITE SHALL BE HELD BY THE GENERAL CONTRACTOR. NO UNSUPERVISED SUBCONTRACTORS SHALL HAVE KEYS OR ACCESS TO THE SITE

WITHOUT THE OWNER'S PRIOR CONSENT. 22. PRIOR TO BEGINNING ANY WORK, THE CONTRACTOR SHALL FURNISH A SCHEDULE SHOWING THE CHRONOLOGICAL PHASES OF THE WORK. THIS SCHEDULE SHALL INDICATE ALL ORDERING LEAD TIMES, LENGTH FOR EACH PHASE, ITS START AND COMPLETION AND A PROJECTED COMPLETION DATE FOR

23. ANY COST CAUSED BY DEFECTIVE OR ILL-TIMED WORK, AS A RESULT OF, BUT NOT LIMITED TO, INFERIOR WORKMANSHIP OR MATERIALS. IMPROPER SCHEDULING OR DELINQUENT ORDERING SHALL BE BORNE BY THE CONTRACTOR.

24. ALL RUBBISH AND WASTE MATERIALS CAUSED BY THE INSTALLATION OF THE WORK SHALL BE REMOVED FROM THE PREMISES PROMPTLY.

25. ALL CONSTRUCTION SHALL BE IN ACCORDANCE WITH ALL RULES, REGULATIONS, CODES AND ALL AUTHORITIES HAVING JURISDICTION. THE CONTRACTOR SHALL COMPLY WITH ALL APPROPRIATE MUNICIPAL AND REGULATORY AGENCIES. CODES AND REQUIREMENTS. THE CONTRACTOR SHALL SECURE ALL NECESSARY PERMITS AND APPROVALS.

26. THE CONTRACTOR SHALL EXAMINE ALL AREAS OF CONSTRUCTION AFTER COMPLETION OF WORK AND PROVIDE NECESSARY TOUCH UP PAINTING OR WALL COVERING FOR PROTECTION.

27. THE CONTRACTOR SHALL INSPECT ALL EXISTING FINISHED SURFACES INCLUDING CORNER BEADS. STOPS, ETC. FOR CHIPS, CRACKS, HOLES, DAMAGED SURFACES AND ANY OTHER DEFECTS CAUSING AN APPEARANCE DIFFERENT FROM A NEW FIRST-CLASS FINISHED INSTALLATION. ALL DEFECTS SHALL BE REPAIRED, OR IF BEYOND REPAIR, THEN INSTALLED AND FINISHED TO THE SATISFACTION OF THE

28. THE CONTRACTOR SHALL THOROUGHLY CLEAN ALL LIGHT FIXTURES AND LENSES, A/C DIFFUSERS AND REGISTERS, FLOORS AND BASES, DOORS, ETC. CONTRACTOR SHALL ALSO PROVIDE A FULL POST-CONSTRUCTION CLEAN PRIOR TO FINAL PROJECT ACCEPTANCE.

DESIGNER JUST PRIOR TO BEING TURNED OVER TO THE OWNER.

29. THIS PROJECT IS A CAPITAL IMPROVEMENT AND NO SALES TAX SHALL BE PAID FOR THE PURCHASE OF EQUIPMENT AND MATERIALS BY OWNER. 30. THE CONTRACTOR SHALL PROTECT ALL INSTALLED WORK AND EXISTING, EXTERIOR GLASS AGAINST

ANY DAMAGE UNTIL PROJECT IS COMPLETED AND ACCEPTED BY THE OWNER. 31. REMOVE ALL EXISTING APPLIANCES AND PLUMBING FIXTURES FROM THE SITE, UNO. 32. PREPARE THE KITCHEN SURFACES FOR NEW EQUIPMENT AND CABINETS AND PROVIDE UTILITIES AS

REQUIRED TO CONNECT ALL NEW APPLIANCES. 33. CONTRACTOR SHALL CONSULT WITH REPRESENTATIVES OF APPLICABLE UTILITIES, INCLUDING GAS, WATER, POWER, TELEPHONE AND CABLE TV AND DETERMINE EXACT LOCATIONS AND AVAILABILITY OF UTILITIES AND DETERMINE CONDITION OF EXISTING SERVICE PRIOR TO COMMENCING WORK OR CONNECTING UTILITIES.

34. CONTRACTOR SHALL PROVIDE TEMPORARY TOILET FACILITIES AT THE JOB SITE AS NECESSARY AND REQUIRED BY CODE.

35. CONTRACTOR SHALL PROTECT FLOOR SURFACES FROM DAMAGE WITH RAMBOARD AND EQUIP MOBILE EQUIPMENT WITH PNEUMATIC TIRES. 36. PRIOR TO ISSUANCE OF A BUILDING PERMIT THE CONTRACTOR SHALL HAVE THE FOLLOWING: 1)

CERTIFICATE OF WORKER'S COMPENSATION INSURANCE MADE OUT TO THE CONTRACTOR'S STATE LICENSE BOARD 2) COPY OF BUSINESS TAX REGISTRATION CERTIFICATE OR A NEWLY PAID RECEIPT FOR ONE FOR APPLICABLE JURISDICTION. 3) NOTARIZED LETTER OF AUTHORIZATION FOR AGENTS 4) COPY OF CONTRACTOR'S STATE LICENSE OR POCKET ID.

# **B. DEMOLITION:**

1. 1. AS REQUIRED TO INSTALL NEW SCOPE OF WORK 2. ALL DEBRIS TO BE PROMPTLY REMOVED FROM SITE

3. ANY DAMAGE DONE TO FLOORS, WALLS, ETC. DUE TO REMOVAL OF EXISTING PARTITIONS, PLUMBING FIXTURES, OR ANYTHING REMOVED IN ORDER TO COMPLETE THE SCOPE OF WORK AS INDICATED ON DRAWINGS SHOULD BE PATCHED TO MATCH EXISTING AND MEET DESIGNER'S AND OWNER'S

4. SEAL ALL VENTS AND OPENINGS AS REQUIRED DURING DEMOLITION TO PREVENT DUST DAMAGE ACROSS ROOMS

5. CONTRACTOR TO REMOVE ALL FURNITURE, APPLIANCES, ETC., IN ORDER TO ALLOW FOR NEW CONSTRUCTION AS SHOWN.

6. CONTRACTOR TO PROVIDE ALL SCAFFOLDING AND BRIDGING AS REQUIRED TO COMPLETE SCOPE OF 7. FOR ALL NEW STONE AND WOOD FLOORING, CONTRACTOR IS TO REMOVE ANY EXISTING SUBSTRATE

AS REQUIRED TO KEEP FLOORS LEVEL AND TRUE. 8. WHEN DEMOLITION IS REQUIRED ON SITE: 1) ALL DEBRIS SHALL BE WET AT THE TIME OF HANDLING TO PREVENT DUST, 2) NO STRUCTURAL MEMBER OF ANY KIND SHALL BE DEMOLISHED UNTIL THE STORY ABOVE IS COMPLETELY REMOVED, 3) FREE FALL DUMPING OVER EXTERIOR WALL WILL NOT BE ALLOWED 4) DEMOLITION PERMIT SHALL BE OBTAINED BY A LICENSED WRECKING CONTRACTOR (CLASS C-21) OR A LICENSED GENERAL CONTRACTOR (CLASS B-1). 5) CONTRACTOR SHALL USE NEGATIVE PRESSURE MACHINES AND HEPA FILTERS THROUGHOUT DEMOLITION TO REDUCE AIRBORNE DUST.

# C. PRODUCT NOTES:

1. 1. ALL PRODUCTS SPECIFIED SHALL BE PROVIDED IN LOCATIONS INDICATED AND INSTALLED IN STRICT ACCORDANCE WITH THE MANUFACTURER'S PRINTED INSTRUCTIONS.

PROVIDE BLOCKING WITHIN ALL WALLS TO SECURE SHELVING WHERE REQUIRED. 3. GENERAL CONTRACTOR (GC) TO ENSURE THAT ALL APPLIANCES. TO INCLUDE CONDENSER AND AIR HANDLING UNITS, ARE OPERATIONAL BEFORE HANDING OVER TO OWNER, ENSURE THAT ALL POWER,

WATER AND VENTILATION PROVIDE AS NECESSARY. 4. GC TO PROVIDE OWNER WITH PROJECT MANUALS AT CLOSE OF JOB INCLUDING ALL OWNER'S MANUALS AND WARRANTIES FOR ALL EQUIPMENT AND APPLIANCES INSTALLED WITHIN THE SCOPE OF

## D. POWER AND TELEPHONE NOTES:

1. PROVIDE ALL ELECTRICAL WORK AS INDICATED ON OR IMPLIED BY THE CONTRACT DOCUMENTS 2. PROVIDE ALL ELECTRICAL POWER AS REQUIRED BY TELEPHONE COMPANY. PROVIDE TELEPHONE AND DATA WIRING IN LOCATIONS INDICATED AND ALL NECESSARY CONDUIT. VOICE WIRING TO BE CAT3, DATA WIRING TO BE CAT6. PATCH PANEL TO BE PROVIDED IN LOCATION INDICATED. TERMINATIONS TO BE PROVIDED BY GC AT LOCATIONS INDICATED. TELEPHONE EQUIPMENT TO BE PROVIDED BY OTHERS.

3. ALL ELECTRICAL WORK SHALL BE COORDINATED WITH THE WORK OF OTHER TRADES 4. ALL WORK SHALL BE INSTALLED IN STRICT ACCORDANCE WITH THE REQUIREMENT OF ALL

AUTHORITIES HAVING JURISDICTION. 5. ALL ELECTRICAL, SPEAKER, AND TELEPHONE WIRING SHALL BE CONCEALED IN DRYWALL AND/OR CEILING. INSTALL SPEAKER WIRE IN LOCATIONS INDICATED. TERMINATIONS AND SPEAKER INSTALLATION ARE BY OTHERS

6. ALL ELECTRICAL, SPEAKER AND LIGHTING WORK IN CONJUNCTION WITH CABINET WORK SHALL BE COORDINATED WITH THE MILLWORK CONTRACTOR. 7. REFER TO ELEVATIONS FOR DIMENSIONED LOCATIONS OF SWITCHES, PLATES, AND OTHER

**FQUIPMENT** 8. ALL 125-V RECEPTACLES IN GARAGE (INCLUDING ANY CEILING OUTLETS) SHALL HAVE GFCI PROTECTION.

9. ALL 125-V RECEPTACLES SERVING COUNTER TOP SURFACES IN THE KITCHEN SHALL HAVE GFCI PROTECTION.

10. ALL 120-V BRANCH CIRCUITS SUPPLYING OUTLETS IN CLOSETS, HALLWAYS, BEDROOMS AND OTHER HABITABLE ROOMS (EXCEPT KITCHEN) SHALL BE PROTECTED BY A LISTED ARC-FAULT CIRCUIT INTERRUPTER (AFCI).

11. RECEPTACLE OUTLETS IN HABITABLE ROOMS SHALL BE SPACED 12' O.C. MAXIMUM AND SHALL BE LOCATED WITHIN 6' OF WALL ENDS, DOOR OPENINGS, AND AT EVERY 2' OR WIDER WALL. 12. RECEPTACLE OUTLETS AT KITCHEN COUNTER-TOPS SHALL BE SPACED AT 4' O.C. MAXIMUM AND WITHIN 2' OF ENDS/BREAKS OF COUNTERS.

13. PROVIDE AT LEAST ONE OUTDOOR RECEPTACLE OUTLET WITH WEATHER PROOF COVER AND GFCI AT

FRONT AND REAR OF DWELLING UNIT AND AT DECK/BALCONY (EXCEPTION: DECK/BALCONY WITH USABLE AREA LESS THAN 20 SQ.FT. 14. ALL RECEPTACLE OUTLETS SHALL BE LISTED TAMPER-RESISTANT RECEPTACLE.

15. BATHROOM RECEPTACLES SHALL BE SERVED BY A DEDICATED 20 AMP CIRCUIT.

16. PROVIDE A WALL SWITCHED-CONTROLLED LIGHTING OUTLET ON THE EXTERIOR SIDE OF OUTDOOR ENTRANCES OR EXITS WITH GRADE LEVEL ACCESS.

E. CEILING & LIGHTING NOTES:

1. CHECK AND VERIFY ALL DIMENSIONS AND CONDITIONS OF EXISTING LIGHTING AT JOB SITE. CONTRACTOR TO NOTIFY DESIGNER OF ANY DISCREPANCIES IN FIELD.

2. PROVIDE LIGHTING FIXTURES INCLUDING RELATED ELECTRICAL WORK AND LAMPING OF TYPES AND INSTALL AS PER MANUFACTURER'S WRITTEN INSTRUCTIONS IN LOCATIONS AS INDICATED ON THE DRAWINGS

3. SUBMIT CUTS OF ALL LIGHTING FIXTURES FOR DESIGNER'S REVIEW AND APPROVAL PRIOR TO INSTALLATION.

4. ALL FIXTURES SHALL BE REMOTE SWITCHED UNLESS OTHERWISE NOTED.

LOCATIONS ARE NOT NOTED, GC TO COORDINATE PLACEMENT WITH DESIGNER.

5. ALL CEILING WORK SHALL BE SQUARE AND LEVEL.

6. PROVIDE CUTOUTS IN CEILING AS REQUIRED FOR NEW CONDUITS. 7. ALL WORK SHALL BE INSTALLED IN STRICT ACCORDANCE WITH THE REQUIREMENTS OF ALL

AUTHORITIES HAVING JURISDICTION AND WITH CEILING MANUFACTURER'S PRINTED INSTALLATION INSTRUCTIONS. 8. ALL ACCESS PANELS TO BE RECESSED ACCESS DOORS FOR DRYWALL SURFACES.

9. 9. REFER TO DESIGNER OR REFLECTED CEILING PLANS FOR LOCATIONS OF SPEAKERS. WHERE DIMENSIONED NOT NOTED, GC TO COORDINATE PLACEMENT WITH DESIGNER. 10. COORDINATE CEILING FRAMEWORK ALL TRADES. 11. ALL REVEALS IN CEILINGS TO BE FRY REGLET EXTRUDED ALUMINUM AS NOTED IN CEILING DETAILS. 12. REFER TO DESIGN ELEVATIONS FOR DIMENSIONED LOCATIONS OF SWITCHES. WHERE DIMENSIONED

#### F. MILLWORK:

1. 1. CHECK AND VERIFY ALL DIMENSIONS AND CONDITIONS AT JOB SITE. CONTRACTOR TO NOTIFY DESIGNER OF ANY DISCREPANCIES IN FIELD.

2. CONTRACTOR SHALL CHECK JOB PROGRESS AND COORDINATE WITH OTHER TRADES INVOLVED. 3. PERFORM ALL FABRICATION FROM FIELD MEASUREMENT WITH PROVISION FOR SCRIBING AS

REQUIRED TO MEET BUILT-IN CONDITIONS. 4. ALL MILLWORK TO INCLUDE INSTALLATION SHALL BE AWI 'PREMIUM GRADE.

5. ALL WOOD SHALL BE FIRE-RATED IN ACCORDANCE WITH LOCAL FIRE RATING REGULATIONS. 6. GROUNDS, FURRING, STRAPPING AND BLOCKING SHALL BE FREE FROM KNOTS WHICH WOULD AFFECT THE STRENGTH OR RENDER NAILING DIFFICULT.

7. ALL MATERIALS FOR WOODWORK SHALL BE THOROUGHLY KILN-DRIED. 8. ALL FINISHED WORK SHALL AS FAR AS PRACTICABLE, BE ASSEMBLED AND FINISHED IN THE SHOP AND DELIVERED TO THE BUILDING READY TO ERECT IN PLACE.

9. ALL WORK SHALL BE FABRICATED, ASSEMBLED, FINISHED AND ERECTED IN ACCORDANCE WITH AWI 'PREMIUM GRADE' STANDARDS. SURFACES AND ARISES SHALL BE TRUE, STRAIGHT, AND FREE FROM ALL MACHINE AND TOOL MARKINGS, BRUISES, INDENTATIONS, CHIPS OR ABRASIONS. 10. WHERE MEMBERS ARE MITERED OR BUTTED, THEY SHALL BE JOINED AND IN A MANNER TO INSURE

AGAINST THE JOINT OPENING. 11. PROVIDE ALL CABINET DOOR AND SHELVING WORK HARDWARE AS REQUIRED FOR A COMPLETE INSTALLATION. REFER TO HARDWARE SCHEDULE. 12. AFTER TOTAL COMPLETION OF ERECTION, ALL NAIL HOLES, SCRATCHES AND OPEN JOINTS SHALL BE

FILED AND TOUCHED UP SO AS TO BE INVISIBLE. 13. ALL WHITE LACQUER MDO AND WOOD VENEER PLYWOOD TO RECEIVE SOLID EDGE BANDING TO CONCEAL LAMINATIONS. EDGE BANDING TO BE VENEER THICK UNLESS OTHERWISE NOTED. 14. FLITCHES TO BE MAXIMUM PRACTICABLE WIDTHS AND FULL HEIGHT IN SEQUENTIAL BOOK MATCH

PATTERN OR AS NOTED BY ARCHITECT. GRAIN DIRECTION ON WALL PANELS AND CABINET FACES TO BE VERTICAL UNLESS OTHERWISE NOTED. ARCHITECT TO SELECT ALL FLITCHES. 15. FABRICATE UNITS IN LARGEST PRACTICABLE SECTIONS. ASSEMBLE IN THE SHOP FOR TRIAL FIT.

DISASSEMBLE FOR SHIPMENT AND REASSEMBLE WITH CONCEALED FASTENERS. 16. MAINTAIN RELATIVE HUMIDITY AND TEMPERATURE DURING FABRICATION, STORAGE AND FINISHING OPERATIONS MATCHING THAT OF THE AREAS OF INSTALLATION. 17. FACTORY FINISH ALL ITEMS WHERE POSSIBLE. DEFER FINAL TOUCH-UP, CLEANING AND POLISHING

UNTIL AFTER DELIVERY AND INSTALLATION. 18. PANELING - PROVIDE CONCEALED WOOD BLOCKING AND FRAMING, ANCHORS, CLIPS, SPLINES, SUPPORTING AND ATTACHING DEVICES. PROVIDE CUT-OUTS TO RECEIVE ATTACHMENTS.

MECHANICAL AND ELECTRICAL WORK AS REQUIRED. 19. MAKE ALL JOINTS HAIRLINE TIGHT, FITTED ACCURATELY AND JOINTED WITH HARDWOOD SPLINES OR DOWELS, GLUED TOGETHER OR BY OTHER METHOD APPROVED BY DESIGNER. USE SCREWS, NOT

NAILS, FOR FASTENING TO GYPSUM BOARD. 20. ALL DRAWERS SHALL BE MAXIMUM DEPTH OF THE HOUSE CABINET W/ FULL EXTENSION, SOFT CLOSING SLIDES. 100 LBS MIN CAPACITY. UNO.

21. ALL CABINET DOORS SHALL HAVE SOFT CLOSING CONCEALED ERO HINGES, UNO. WHEN THE DOOR OPEN ADJACENT TO A PERPENDICULAR WALL CONTRACTOR SHALL PROVIDE LIMITER CLIPS TO

PREVENT CLASHING DOOR W/ WALL, PROVIDE HINGE AT MAX 16" O.C. 22. ALL DRAWERS & CABINET DOOR PANELS SHALL BE FITTED W/ (4) FOUR 1/8" THK CLEAR SELF-ADHESIVE

23. ALL REVEAL JOINTS BETWEEN CABINET & DRAWER PANELS SHALL ALIGN + BE LEVEL + PLUMB.

# G. GYPSUM BOARD WORK:

1. GYPSUM BOARD PARTITIONS SHALL TYPICALLY CONSIST OF 2X6 WOOD STUDS AT 16" O.C. WITHOUT EXCEPTION, STUDS SHALL BE FIRMLY ANCHORED TO THE FLOOR AND CEILING PLATES. THE FLOOR AND CEILING PLATES SHALL IN TURN BE ANCHORED TO THE FLOOR AND CEILING STRUCTURES WITH TWO CONTINUOUS BEADS OF ACOUSTIC/FIRE SEALANT BETWEEN SUBSTRUCTURE & RUNNER.

2. ALL GYPSUM BOARD WORK SHALL BE INSTALLED IN STRICT ACCORDANCE WITH ALL AUTHORITIES HAVING JURISDICTION AND WITH MANUFACTURER'S PRINTED INSTALLATION INSTRUCTIONS. ALL NEW GYPSUM SURFACES TO BE LEVEL 4 DRYWALL FINISH AND BOARDS TO HAVE TAPERED EDGES.

3. PROVIDE ALL REQUIRED FASTENERS, ANCHORS, ADHESIVES, COMPOUNDS, ETC. AS INDICATED PER GYPSUM BOARD MANUFACTURE'S STANDARDS AND AS REQUIRED FOR A COMPLETE INSTALLATION. 4. ALL EXPOSED EDGES AND/OR CORNERS OF GYPSUM BOARD SHALL RECEIVE A HOT-DIPPED GALVANIZED METAL CORNER BEAD AND ALL EDGES OF A GYPSUM BOARD ABUTTING OTHER MATERIAL

SHALL RECEIVE A HOT-DIPPED GALVANIZED METAL CASING BEAD, TAPED AND SPACKLED SMOOTH. 5. PROVIDE NEW SPECIAL WATER RESISTANT TYPE GYPSUM BOARD IN ALL WET LOCATIONS SUCH AS BATHROOMS. PROVIDE CEMENT BOARD SUCH AS DUROCK AT ALL SHOWER AND BATH AREAS OVER MEMBRANE WATER PROOFING.

6. WALLS SHOWN ALIGNED WITH EXISTING BUILDING CONSTRUCTION SHALL BE FLUSH AND SMOOTH WITH EXISTING BUILDING CONSTRUCTION UNLESS OTHERWISE INDICATED. 7. ALL PARTITIONS SHALL BE FURNISHED WITH BASES AS INDICATED IN THE CONTRACT DOCUMENTS.

8. ALL NEW PARTITIONS SHALL BE TAPED, SPACKLED AND SANDED. 9. WHERE SPECIFIED, PLYWOOD UNDERLAYMENT TO HAVE STAGGERED JOINTS, GWB OVERLAY ALSO STAGGERED SO THAT PLYWOOD JOINTS DO NOT TELEGRAPH THROUGH TO SURFACE OF GWB. 10. AT EXISTING PARTITIONS, CONTRACTOR TO PROBE WALL TO LOCATE STUDS AND COORDINATE WITH

NEW CONSTRUCTION. 11. PROVIDE A FULL SKIM COAT OF COMPOUND AT ALL EXISTING AND NEW GWB SURFACES THAT ARE NOT SMOOTH AND TRUE.

12. ALL DRYWALL SURFACES ABUTTING FINISH CASEWORK SHALL RECEIVE SKIM COATING AS REQUIRED TO MAKE SURFACE LEVEL AND PLUMB.

# H. SHOP DRAWINGS & SAMPLES:

1. SUBMIT SHOP DRAWINGS FOR DESIGNERS APPROVAL FOR THE FOLLOWING ITEMS: CABINETRY/MILLWORK, ALL DOOR & WINDOW ASSEMBLIES, ALL METAL WORK & STRUCTURAL STEEL, TILE LAYOUT DETAILS WITH STARTING POINTS AND JOINT LAYOUT, CUSTOM CONCRETE, MECHANICAL DUCTWORK, ELECTRICAL WORK, GLAZED ASSEMBLIES.

2. CONTRACTOR SHALL SUBMIT THREE SAMPLES OF ALL FINISH MATERIALS, INCLUDING BUT NOT LIMITED TO, TILE, GLASS, STONE, WOOD VENEER FOR DESIGNER/OWNER REVIEW. SAMPLES MAY BE REVIEWED ON SITE. SEE PROJECT MANUAL.

1. CONTRACTOR TO TEST ANY FANS, EXHAUSTS, MECHANICAL EQUIPMENT PRIOR TO HANDOVER OF

PROJECT TO OWNER 2. NEW DWELLING UNIT SHALL HAVE A MECHANICAL VENTILATION SYSTEM.

#### J. PAINTING:

1. ALL AREAS RECEIVING PAINT, AS INDICATED IN FINISH SCHEDULE, SHALL BE PAINTED IN ACCORDANCE WITH PAINT MANUFACTURE'S WRITTEN INSTRUCTIONS.

2. WALLS SCHEDULED TO BE PAINTED SHALL INCLUDE SURFACES FROM FLOOR TO CEILING INCLUDING PILASTERS, FASCIAS, DOORS, BUCKS, REVEALS, AND ALL SURFACES NOT INCLUDING FLOOR AND

3. PAINT GYPSUM CEILINGS AND WALLS AS PER FINISH SCHEDULE. 4. PAINT COLORS AND TEXTURES SHALL BE SELECTED AND SPECIFIED IN FINISH SCHEDULE, AND CONTRACTOR SHALL SUBMIT THREE 18"X18" SAMPLES OF EACH SELECTED COLOR AND TEXTURE FOR

5. ALL WALLS AND CEILINGS SHALL BE PROPERLY PREPARED, SPACKLED, SANDED, ETC., TO PROVIDE A PERFECTLY SMOOTH SURFACE TO RECEIVE PAINT, SKIM COAT, ETC. AS REQUIRED.

6. ALL PAINT SHALL BE WATER BASED PAINT, PROVIDE ONE (1) PRIMER COAT AND TWO (2) FINISH COATS OF PAINT AS SPECIFIED IN FINISH SCHEDULE. 7. ALL ROOMS TO BE BENJAMIN MOORE AURA, DUNN EDWARDS SUPREMA OR APPROVED EQUAL.

### K. PLUMBING NOTES:

COLORS & FINISH TBD BY DESIGNER.

 PROVIDE ALL PLUMBING ROUGHING AS INDICATED OR IMPLIED BY CONTRACT DOCUMENTS. 2. ALL FIXTURES AND ACCESSORIES TO BE PROVIDED AND INSTALLED BY CONTRACTOR AS PER MANUFACTURER'S GUIDELINES. IF CONTRACTOR FINDS THAT COMPONENTS OR ITEMS ARE MISSING WHICH ARE REQUIRED FOR THE COMPLETE INSTALLATION AS IMPLIED IN THE CONTRACT DOCUMENTS

THE GC SHALL NOTIFY THE DESIGNER IMMEDIATELY FOR COORDINATION.

3. PLUMBING WORK SHALL BE COORDINATED WITH ALL OTHER TRADES. 4. INSTALL FIXTURES, LINES OR PIECES OF THE APPROVED ALL VALVES AS INDICATED ON THE DRAWINGS OR AS MAY BE REQUIRED FOR THE PROPER CONTROL OF THE VARIOUS APPARATUS AND PIPELINES SO THAT ANY OF THE FIXTURE, LINES OR PIECES OF APPARATUS MAY BE CUT OFF FOR REPAIR WITHOUT INTERFERING OR INTERRUPTING SERVICE TO THE REST OF THE PROJECT. ALL VALVES SHALL BE DESIGNED FOR REPACKING WHEN WIDE OPEN UNDER PRESSURE

5. BEFORE BEING COVERED UP OR BUILT IN, ALL PIPING SHALL BE TESTED AS REQUESTED BY THE AUTHORITIES HAVING JURISDICTION AND WITNESS BY THE OWNER, DESIGNER AND OR BUILDING **FNGINFFR** 

6. DIVERSION OF PLUMBING SHALL NOT INTERRUPT DRAINAGE SERVICE IN ANY WAY. 7. REMOVE ANY DORMANT PIPES DISCOVERED. 8. CONTRACTOR TO ENSURE THAT ANY EXISTING PIPES ARE IN GOOD CONDITION OR REMEDY OR

REPLACE EXISTING PIPES. 9. IDENTIFY ALL ITEMS REQUIRING SERVICE ACCESS AND PROVIDE APPROVED TYPE ACCESS DOORS. SUCH LOCATIONS TO BE COORDINATED AND APPROVED BY DESIGNER. ACCESS DOOR TO BE RECESSED FOR DRYWALL SURFACES.

10. IF REQUIRED A NEW WATER METER SHALL BE INSTALLED TO MEET CAPACITY OF THE NEW DOMESTIC AND SPRINKLER CAPACITY DEMANDS.

11. WATER METERS SHALL BE PLACED NEAR THE PROPERTY LINE AND OUT OF THE DRIVEWAY APPROACH WHENEVER POSSIBLE.

12. THE WATER METER BOX MUST BE PURCHASED FORM THE CITY AND MUST HAVE A TRAFFIC RATED LID IF THE BOX IS LOCATED IN THE DRIVEWAY.

#### L. WOOD FLOORING:

1. GENERAL STANDARDS TO COMPLY WITH RECOMMENDATIONS OF NATIONAL FLOORING MANUFACTURER'S ASSOCIATION (NOFMA).

SUBSTRATE WITHOUT AFFECTING THE INSTALLATION OF FLOOR.

2. FLOORING TO BE INSTALLED AS SPECIFIED IN FINISH SCHEDULE AND AS PER MANUFACTURER'S WRITTEN INSTALLATION INSTRUCTIONS. 3. PROTECT FLOORING FROM EXCESSIVE MOISTURE IN SHIPMENT, STORAGE AND HANDLING. DELIVER IN UNOPENED CARTONS OR BUNDLES AND STORE IN A DRY PLACE WITH ADEQUATE AIR CIRCULATION. DO NOT DELIVER MATERIAL TO BUILDING UNTIL WET WORK SUCH AS CONCRETE HAVE BEEN

COMPLETED AND CURED TO A CONDITION OF EQUILIBRIUM. 4. PROVIDE MOCK-UP OF WOOD 4'X4' SQUARE ON SITE (TO BE REPLACED WITH FINAL FLOORING) FOR DESIGNER AND OWNER REVIEW AND APPROVE 5. WHERE THE SUBFLOOR IS NOT LEVEL, THE CONTRACTOR SHALL TAKE MEASURES TO LEVEL THE

6. GRAIN/BOARD DIRECTION SHALL BE INDICATED ON FLOOR PLAN. 7. CONTRACTOR SHALL PROVIDE MANUFACTURER RECOMMENDED VAPOR BARRIER OVER SUBFLOOR THROUGHOUT PROJECT AND PROVIDE 1/4" FLOOR UNDERLAYMENT

8. CONTRACTOR SHALL STORE WOOD FLOOR ON SITE FOR MINIMUM OF TWO WEEKS TO ALLOW WOOD TO ACCLIMATE PRIOR TO INSTALLATION. BOARDS SHALL BE SPACED OUT TO ALLOW AIR FLOW ACROSS ALL FACES OF EACH BOARD. 9. ADHESIVE AND FASTENING AGENTS USED TO INSTALL FLOORING SHALL BE MANUFACTURER

APPROVED ONLY. 10. CONTRACTOR SHALL COORDINATE AND ALLOW FOR (IF ANY) THERMAL EXPANSION TO PREVENT PLANKS FROM BUCKLING. 11. BOARDS SHALL BE A MINIMUM OF 60" IN LENGTH AND SHALL NOT ACCOUNT FOR MORE THAN 25% OF

12. SEE FINISH AND MATERIAL SCHEDULE FOR MORE INFORMATION.

THE BOARD MIX. REMAINING MIX OF BOARDS SHALL BE AT MINIMUM 25% 5'-8', 25% 8'-10' & 25% 10'-0"

# M. DOOR NOTES:

1. ALL DOORS TO BE 1-3/4" SOLID LUMBER CORE FLUSH WHITE OAK VENEER DOORS W/ 'A' FACE ON BOTH SIDES OR APPROVED EQUAL. DOORS IN EXCESS OF 36" IN WIDTH AND/OR 96" IN HEIGHT SHALL BE 2" IN

2. DOORS SHALL BE MANUFACTURED BY WEYERHAEUSER, ALGOMA OR EGGERS HARDWOOD PRODUCTS CORP., OR OTHER APPROVED EQUALS. 3. DOORS WHEN INSTALLED SHALL NOT BOW OR BECOME OUT OF PLANE. ALL DOORS SHALL BE

FABRICATED TO ACCOMODATE SELF WEIGHT AND THE DISTRIBUTION OF WEIGHT SPECIFIC TO OPERATION AND ATTACHMENT OF ASSIGNED HARDWARE EACH DOOR. 4. ALL DOOR STOPS SHALL BE LOCATED IN THE FIELD W/ DESIGNER & OWNER PRIOR TO INSTALLATION.

# N. STONE NOTES:

1. A WATERPROOFING MEMBRANE SHALL BE PLACED OVER ALL PORTIONS OF SUBFLOOR AT BATHROOMS AND RUN UP VERTICAL AT ALL WALLS AS HIGH AS POSSIBLE, BUT A MINIMUM OF 12" ABOVE FINISHED FLR, WHILE REMAINING CONCEALED BEHIND THE WALL BASE TRIM AND OR WALL

CLADDING MATERIAL 2. ANY STONE OR TILE SHALL BE SET LEVEL, PLUMB AND FLUSH ALIGNED. JOINTS SHALL BE 1/8" MAX AND

3. GROUT COLOR SHALL BE AS PER FINISH SCHEDULE AND A SAMPLE MEASURING 12"X12" SHALL BE SUBMITTED FOR DESIGNER AND OWNER APPROVAL. 4. FINAL STONE, TILE INSTALLATION SHALL BE FREE OF CHIPS, SCRATCHES, GROUT HAZE OR STAINS. 5. ALL EXPOSED EDGES ON COUNTERTOPS SHALL BE SLIGHTLY EASED, 1/8" MAX AT ALL UNDERMOUNT

EDGE SAMPLE FOR DESIGNER'S REVIEW. 6. ALL STONE TO BE FINISHED WITH DRY TREAT BRAND SEALER OR SUPPLIER RECOMMENDED SEALER. 7. CONTRACTOR SHALL CLEAN, PATCH AND LEVEL THE SUBFLOOR AS REQUIRED FOR ALL TILE/STONE FLOORING.

SINKS AND TUBS AND 1/16" MAX AT ALL OTHER LOCATIONS. CONTRACTOR SHALL SUBMIT AN EASED

# O. GLASS NOTES:

1. ALL GLASS SHALL BE SIZE CRITICAL BASED ON FIELD DIMENSIONS 2. ALL GLASS, UON, SHALL BE WATER WHITE GLASS AND TEMEPRED WHERE REQUIRED BY CODE

# P. TEMPORARY MEASURES:

1. GC SHALL MAINTAIN A COMPUTER & INTERNET CONNECTION TO RECEIVE SKETCHES & TRANSMISSIONS ON SITE DURING CONSTRUCTION. GC SHALL ALSO PROVIDE THE DESIGNER WITH A TELEPHONE NUMBER FOR THE JOB SITE WHETHER WIRED OR MOBILE.

2. GC TO PROVIDE A FIRE EXTINGUISHER AND FIRST AID KIT ON SITE DURING CONSTRUCTION. 3. GC SHALL PROVIDE A NEST WEBCAM OR APPROVED EQUIVALENT FOR REMOTE VIEWING OF SITE FROM TWO LOCATIONS. OWNER SHALL INSTALL & PAY COST OF INTERNET BANDWITH TO SUPPORT CONTINUOUS CAMERA FEED.

# Q. LANDSCAPE & LANDSCAPE IRRIGATION:

1. ALL LANDSCAPE IRRIGATION BACKFLOW DEVICES MUST MEET CURRENT JURISDICTION'S REQUIREMENTS FOR PROPER INSTALLATION.

## R. FIRE DEPARTMENT NOTES:

1. GC TO REFER TO APPLICABLE FIRE CODE NOTES RELEVANT TO NEW CONSTRUCTION OF SINGLE

FAMILY RESIDENCE. 2. PROJECT CONSTRUCTION SHALL BE IN ACCORDANCE WITH ALL APPLICABLE STANDARDS OF THE MOST CURRENT BUILDING AND MUNICIPAL CODES AS ADOPTED BY GOVERNING JURISDICTIONS OF

THE PROJECT LOCATION AT TIME OF INITIAL FILING. 3. A SET OF PLANS MUST REMAIN ON THE JOB SITE AT ALL TIMES. APPOINTMENTS FOR INSPECTIONS, IF REQUIRED, SHOULD BE MADE AT LEAST TWO DAYS IN ADVANCE OF THE REQUIRED INSPECTION.

4. AN APPROVED KEY BOX SHALL BE INSTALLED, WITH THE APPROPRIATE KEYS, FOR EMERGENCY FIRE DEPARTMENT ACCESS IN A LOCAITON APPROVED BY THE FIRE DEPARTMENT. THE KEY BOX SHALL BE A KNOX BOX BRAND AN DSIZED TO ACCOMMODATE KEYS TO EVERY DOOR OF THE PROJECT. 5. FIRE EXTINGUISHERS SHALL BE INSTALLED AND MAINTAINED PER 2018 IFC SECTION 906 BOTH DURING CONSTRUCTION AND UPON OCCUPANCY OF THE BUILDING. DURING CONSTRUCTION, FIRE EXTINGUISHERS SHALL BE PLACED IN A CONSPICUOUS, EASY TO ACCESS, UNOBSTRUCTED

LOCATION THAT IS LESS THAN 75' TRAVEL DISTANCE TO ANY COMBUSTIBLES ON SITE, 30' TO ANY HOT WORK. EXTINGUISHERS SHALL BE MOUNTED IN A CONSPICUOUS, EASY TO ACCESS, UNOBSTRUCTED LOCATION. UPON COMPLETION OF PROJECT, RESIDENCE SHALL HAVE A MINIMUM OF ONE EXTINGUISHER PER GARAGE AND ONE EXTINGUISHER PER KITCHEN AREA.

6. APPROVED ADDRESS NUMBERS SHALL BE PLACED IN SUCH A POSITION TO BE PLAINLY VISIBLE AND LEGIBLE FROM THE ROAD FRONTING THE PROPERTY. NUMBERS AND LETTERS SHALL BE A MINIMUM OF FOUR (4) INCHES TALL. HAVE A MINIMUM 1/2" BRUSH STROKE, CONTRAST WITH THEIR BACKGROUND, AND BE POSITIONED A MINIMUM OF FORTY-EIGHT (48) INCHES ABOVE FINAL GRADE. 7. VEHICLE PARKING AND MATERIAL STORAGE DURING CONSTRUCTION SHALL NOT RESTRICT OR OBSTRUCT PUBLIC STREETS OR ACCESS TO ANY BUILDING. A MINIMUM TWENTY FOOT TRAVEL LANE FOR EMERGENCY VEHICLE ACCESS SHALL BE MAINTAINED CLEAR AND UNOBSTRUCTED AT ALL TIMES. ALL REQUIRED FIRE LANES, INCLUDING WITHIN 15 FEET OF FIRE HYDRANTS, SHALL BE

MAINTAINED CLEAR AND UNOBSTRUCTED AT ALL TIMES. 8. PROVIDE FIRE HYDRANT FOR THE PROPERTY AS REQ'D PER NLTFD REQUIREMENTS AND IFC Table C102.1 (IFC Appendix C).

9. ALL BUILDINGS EQUIPED WITH AN AUTOMATIC FIRE SPRINKLER SYSTEM SHALL HAVE A MONITORED FIRE ALARM PER (IFC 903.4 ) PLANS AND INSTALLATION OF 13R FIRE SPRINKLER AND MONITORED FIRE ALARM SYSTEM UNDER SEPARATE PERMIT PER RESOLUTION 16-1.

## S. FIRE PROTECTION

1. (IFC 907.2.10): INTERCONNECTED SMOKE ALARMS SHALL BE INSTALLED INSIDE ALL BEDROOMS, ON THE CEILING OR WALL OUTSIDE OF EACH BEDROOM AND IN EVERY STORY IN THE DWELLING UNIT INCLUDING BASEMENTS BUT NOT CRAWL SPACES, UNINHABITED ATTICS AND GARAGES. 2. CARBON MONOXIDE ALARMS SHALL BE INSTALLED IMMEDIATELY OUTSIDE OF ALL BEDROOMS AND IN

THE IMMEDIATE VICINITY OF BEDROOMS IN DWELLING UNITS WITHIN WHICH FUEL FIRED APPLIANCES ARE INSTALLED, AND IN DWELLING UNITS THAT HAVE ATTACHED GARAGES. 3. CARBON MONOXIDE ALARMS SHALL RECEIVE THEIR PRIMARY POWER FROM THE BUILDING WIRING,

SHALL BE EQUIPPED WITH A BATTERY BACKUP AND INTERCONNECTED 4. CUT SHEETS OF ALL DEVICES SHALL BE SUBMITTED TO ARCHITECT PRIOR TO PURCHASE AND 5. FIRE SUPPRESSION SHALL BE PROVIDED IN NEW DWELLING UNIT, ATTACHED GARAGE AND ANY CRAWL SPACES IF APPLICABLE. THE AUTOMATIC RESIDENTIAL SPRINKLER SYSTEM WILL COMPLY

1. AN EXCAVATION AND ENCROACHMENT PERMIT IS REQUIRED PRIOR TO ANY IMPROVEMENTS N THE

2. A REVOCABLE OCCUPANCY PERMIT MUST BE OBTAINED SHALL THE BEAR BOX LOCATION BE WITHIN

WITH NFPA 13R, MONITORED BY AN APPROVED FIRE ALARM SYSTEM IN ACCORDANCE WITH NFPA 72,

#### T. COUNTY RIGHT-OF-WAY

OUTLETS/SWITCHES.

AND PER REQ'S OF AUTHORITY HAVING JURISDICTION.

12' OF EDGE OF PAVEMENT U. FLOODPLAIN NOTES 1. ALL NEW CONSTRUCTION, SUBSTANTIAL IMPROVEMENTS, AND DEVELOPMENT SHALL BE

CONSTRUCTED WITH MATERIALS AND UTILITY EQUIPMENT RESISTANT TO FLOOD DAMAGE IN

ACCORDANCE WITH FEMA TECHNICAL BULLETIN 2, FLOOD DAMAGE-RESISTANT MATERIALS

COUNTY RIGHT-OF-WAY, PERMIT MUST BE OBTAIN BY COUNTY APPROVED CONTRACTOR

REQUIREMENTS. ALL MATERIALS LOCATED BELOW THE BASE FLOOD ELEVATION SHALL MEET THE REQUIREMENTS OF BEING FLOOD RESISTANT. 2. ALL NEW CONSTRUCTION AND SUBSTANTIAL IMPROVEMENTS SHALL BE ANCHORED TO PREVENT

FLOTATION, COLLAPSE, OR LATERAL MOVMENT OF THE STRUCTURE RESULTING FROM HYDRODYNAMIC AND HYDROSTATIC LOADS, INCLUDING THE EFFECTS OF BUOYANCY. 3. ALL NEW AND REPLACEMENT ELECTRICAL, HEATING, VENTILATION, PLUMBING, AIR CONDITIONING EQUIPMENT, AND OTHER SERVICE FACILITIES SHALL BE DESIGNED AND/OR LOCATED SO AS TO PREVENT WATER FROM ENTERING OR ACCUMULATING WITHIN THE COMPONENTS DURING CONDITIONS OF FLOODING TO THE FLOOD PROTECTION ELEVATION. THESE INCLUDE, BUT ARE NOT LIMITED TO. HVAC EQUPMENT. WATER SOFTENER UNITS. BATH/KITCHEN FIXTURES, DUCTWORK.

ELECTRIC/GAS METER PANELS/BOXES, UTILITY/CABLE BOXES, HOT WATER HEATERS, AND ELECTRIC

# 450 WOOD RIVER

450-490 WOOD RIVER, LLC ATTN: FRAZIER CAVNESS P.O. BOX 14001-174 KETCHUM, ID 83340

PROJECT ARCHITECT RO | ROCKETT DESIGN 1031 W. MANCHESTER BLVD. UNIT 6

INGLEWOOD, CA 90301

TEL: 213.784.0014 CONTRACTOR:

GEOTECHNICAL ENGINEER:

**BUTLER ASSOCIATES, INC.** P.O. BOX 1034 KETCHUM, ID 83340

TEL: 208.720.6432 CIVIL ENGINEER:

TEL: 208.726.9512

TEL: 406.551.2098

**BENCHMARK ASSOCIATES** 100 BELL DRIVE KETCHUM, ID 83340

LANDSCAPE ARCHITECT:

FIELD STUDIO LANDSCAPE ARCHITECTS 722 N. ROUSE AVENUE BOZEMAN, MT 59715

**CONSULTING ENGINEERING SERVICES (CES)** 

STRUCTURAL ENGINEER: LABIB FUNK & ASSOCIATES 319 MAIN STREET EL SEGUNDO. CA 90245

TEL: 213.239.9700 MEP ENGINEER:

1001 W OAK BLDG

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270 CORAL CIRCLE

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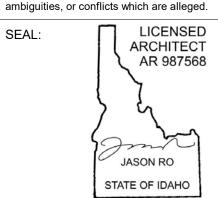
EL SEGUNDO, CA 90245

TEL: 406.272.0352 KGM ARCHITECTURAL LIGHTING

**AUDIO VIDEO SYSTEMS, INC.** 2700 HOMESTEAD RD PARK CITY, UT 84098

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1 04.16.2024 FDP APP RESUBMITTAL

**ISSUE** 

PROJECT:

NO DATE

450 WOOD RIVER 450 WOOD RIVER DRIVE KETCHUM, ID 83340

PROJECT NUMBER

2108

DRAWING TITLE:

**GENERAL NOTES** 

-DRAWING NUMBER

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# **Ketchum Fire Department**

FIRE COMMENTS MEMO

To: Frazier Cavness

CC: Ketchum Building

From: Seth Martin, Assistant Chief / Fire Marshal

Date: December 26, 2023

Subject: 450 Wood River Dr

It is the General Contractor's responsibility to understand and adhere to all Fire Protection Ordinance #1217 requirements in addition to all City of Ketchum requirements in effect at the time of Building Permit issuance. Failure to comply with all local ordinances and codes may result in project work stoppage as well as criminal penalties.

The above project shall meet all 2018 International Fire Code requirements in addition to specific City Building and Fire Ordinances.

An approved automatic fire sprinkler system shall be installed throughout the building per City of Ketchum Ordinance #1217 (www.ketchumfire.org) and the National Fire Protection Association Standard 13. An approved fire sprinkler flow bell, Knox box and Fire Department Connection shall be installed in an approved location visible to approaching firefighters. Water service lines to structures shall be hydraulically calculated for size to meet fire sprinkler flow requirements. Fire sprinkler systems shall be annually tested and maintained per NFPA 25. An approved fire department connection and flow bell shall be installed in a location approved by the fire department and the system shall be supervised by an approved alarm system.

NOTE: One electronic set of fire sprinkler system plans must be submitted to the Ketchum Fire Department as well as the State Fire Marshals office and a Ketchum Fire Department Permit must be obtained prior to installation of fire sprinkler systems. Inspections of fire sprinkler systems by the Fire Chief or an appointee are required. Inspections must be scheduled at least 48 hours in advance.

An approved monitored fire detection system shall be installed per City of Ketchum Ordinance #1217 (www.ketchumfire.org) and the requirements of NFPA 72. Alarm system plans shall be submitted to the Ketchum Fire Department for approval and a permit is required prior to installation of alarm systems. Inspections of fire detection systems by the Fire Chief or an appointee are required and shall be scheduled at least 48 hours in advance.

An approved monitored fire sprinkler alarm system shall be installed per City of Ketchum Ordinance #1217 (www.ketchumfire.org) and the requirements of NFPA 72. Alarm system plans shall be submitted to the Ketchum Fire Department for approval and a permit is required prior to installation of alarm systems. Inspections of fire detection systems by the Fire Chief or an appointee are required and shall be scheduled at least 48 hours in advance.

An approved key box shall be installed, with the appropriate keys, for emergency fire department access in a location approved by the fire department. The key box shall be a Knox box brand and sized to accommodate keys to every door of the project.

Page 1 of 3

An approved access roadway per 2018 International Fire Code Appendix D (www.ketchumfire.org) shall be installed prior to any combustible construction on the site. The road shall be a minimum of twenty (20) feet in width, capable of supporting an imposed load of at least 75,000 pounds, and extend to within 150' of all exterior areas of the structure(s). The road must be an all-weather driving surface maintained free, clear, and unobstructed at all times. Grades shall not exceed 7%. Dead end access roadways exceeding 150 feet in length shall be provided with an approved turnaround. Gates, if installed, are required to be siren activated for emergency vehicle access. Where the vertical distance between the grade plane and the highest roof surface exceeds 30 feet, approved aerial fire apparatus access roads shall be provided. Aerial fire apparatus access roads shall have a minimum unobstructed width of 26 feet, exclusive of shoulders, in the immediate vicinity of the building or portion thereof.

Smoke and Carbon Monoxide Detectors shall be installed per NFPA and the International Fire Code. Smoke detectors shall be installed inside each bedroom, within 21' of each sleeping area, and on every level of the occupancy, including the basement. CO alarms shall be installed in a central location outside each sleeping area and on every level of the home.

Fire extinguishers shall be installed and maintained per 2018 IFC Section 906 both during construction and upon occupancy of the building. During construction fire extinguishers shall be placed in a conspicuous, easy to access, unobstructed location that is less than 75' travel distance to any combustibles on site, 30' to any hot work. Extinguishers shall be mounted in a conspicuous, easy to access, unobstructed location. Upon completion of project every single-family residence shall have a minimum of one extinguisher per garage and one extinguisher per kitchen area.

Approved address numbers shall be placed in such a position to be plainly visible and legible from the road fronting the property. Numbers and letters shall be a minimum of four (4) inches tall, have a minimum 1/2" brush stroke, **contrast** with their background, and be positioned a minimum of forty-eight (48) inches above final grade.

Vehicle parking and material storage during construction shall not restrict or obstruct public streets or access to any building. A minimum twenty-foot travel lane for emergency vehicle access shall be maintained clear and unobstructed at all times. All required Fire Lanes, including within 15 feet of fire hydrants, shall be maintained clear and unobstructed at all times.

This project shall comply with the City of Ketchum Fire Protection and defensible space characteristics. Exterior windows, window walls, glazed doors, windows within exterior doors, and skylights shall be tempered glass, multilayered glazed panels, glass block or have a fire protection rating of not less than 20 minutes. All exterior doors shall be solid core construction or have a fire rating of not less than 20 minutes. All exterior vents shall be designed and approved to prevent flame or ember penetration and all exterior mesh shall have openings that do not exceed 1/8". Gutters and downspouts shall be non-combustible and shall be provided with an approved means to prevent the accumulation of leaves and debris. All materials within 12" vertical of finished grade shall be 1 hour rated, non-combustible, or covered with minimum 28-gauge flashing. The area 12" horizontal from the base of a wall shall be finished in a way to prevent any vegetation growing, and for vegetative debris to be easily removed. Tree crowns and all other combustible vegetation extending to within 10 feet of any structure or chimney shall be pruned to maintain a minimum horizontal clearance of 10 feet. Tree crowns within 30 feet of any structure shall be pruned to remove limbs located less than 6 feet above the ground surface adjacent to the trees. Non-fire

Page 2 of 3

resistive vegetation or growth shall be kept clear of buildings and structures, in such a manner as to provide a clear area for fire suppression operations. Spark arrestors are required on chimneys attached to all solid

#### Note: Additional requirements may be added upon final plan review.

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ARCHITECT m

450 Wood River Drive 2018 IECC Prescriptive Path with Idaho Amendment August 18, 2023

Page 3 of 3

The new residence at 450 Wood River Drive, Ketchum, ID intends to use the 2018 IECC prescriptive path with Idaho amendment for insulation and fenestration requirements for climate zone 6, as shown in the table below:

John Reuter Greenworks

Tel: 208.721.2922

Hailey, ID 83333

john@idahogreenworks.com 126 S Main St, Suite B4

| TABLE R402.1.2 INSULATION AND FENESTRATION REQUIREMENTS BY COMPONENT <sup>a</sup> |  |                                   |  |                    |                                  |                      |                  |  |  |                               |
|---|--|-----------------------------------|--|--------------------|----------------------------------|----------------------|------------------|--|--|-------------------------------|
| Climate<br>Zone   | Fenestration<br>U- Factor <sup>b</sup> | Skylight <sup>b</sup><br>U-factor | Glazed<br>Fenestration<br>SHGC <sup>b, c</sup> | Ceiling<br>R-Value | Wood<br>Frame<br>Wall<br>R-Value | Mass Wall<br>R-Value | Floor<br>R-Value | Basement <sup>c</sup><br>Wall<br>R-Value | Slab <sup>d</sup><br>R-Value<br>&<br>Depth | Crawlspace<br>Wall<br>R-Value |
| 5   | 0.32                                   | 0.55                              | NR   | 38                 | 20 or<br>13+5 <sup>h</sup>       | 13/17                | 30 <sup>g</sup>  | 15/19                                    | 10, 2 ft                                   | 15/19                         |
| 6   | 0.30                                   | 0.55                              | NR   | 49                 | 22 or<br>13+5 <sup>h</sup>       | 15/20                | 30g              | 15/19                                    | 10, 4 ft                                   | 15/19                         |

Source: Division of Building Safety, 2020, Idaho Statutes and Administrative Rules, page 8

Specifically, this project intends to use the following components:

| <b>Building Component</b>        | Insulation Type                | R-value / U-value |  |  |
|----------------------------------|--------------------------------|-------------------|--|--|
| Slab                             | 2" thick XPS under entire slab | 10                |  |  |
| Floors Overhangs and over Garage | Blown fiberglass or spray foam | 30                |  |  |
| Above Grade Walls                | Spray Foam                     | 22                |  |  |
| Windows and Glass Doors          | Double pane low E              | 0.3               |  |  |
| Solid Doors                      | Insulated Door or Solid Wood   | 0.28              |  |  |
| Ceilings                         | 8" CCSPF                       | 49                |  |  |

**450 WOOD RIVER** 

OWNER:

450-490 WOOD RIVER, LLC ATTN: FRAZIER CAVNESS P.O. BOX 14001-174 KETCHUM, ID 83340

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LANDSCAPE ARCHITECT:

722 N. ROUSE AVENUE BOZEMAN, MT 59715

FIELD STUDIO LANDSCAPE ARCHITECTS

MEP ENGINEER:

LIGHTING:

2700 HOMESTEAD RD PARK CITY, UT 84098

ambiguities, or conflicts which are alleged.

STATE OF IDAHO

JASON RO

1 04.16.2024 FDP APP RESUBMITTAL NO DATE ISSUE

PROJECT:

450 WOOD RIVER 450 WOOD RIVER DRIVE KETCHUM, ID 83340

PROJECT NUMBER

2108

DRAWING TITLE:

-BRAWING NUMBER:


**ENERGY & FIRE DEPT DOCUMENTS** 







SCALE: NTS | N ELEVATION

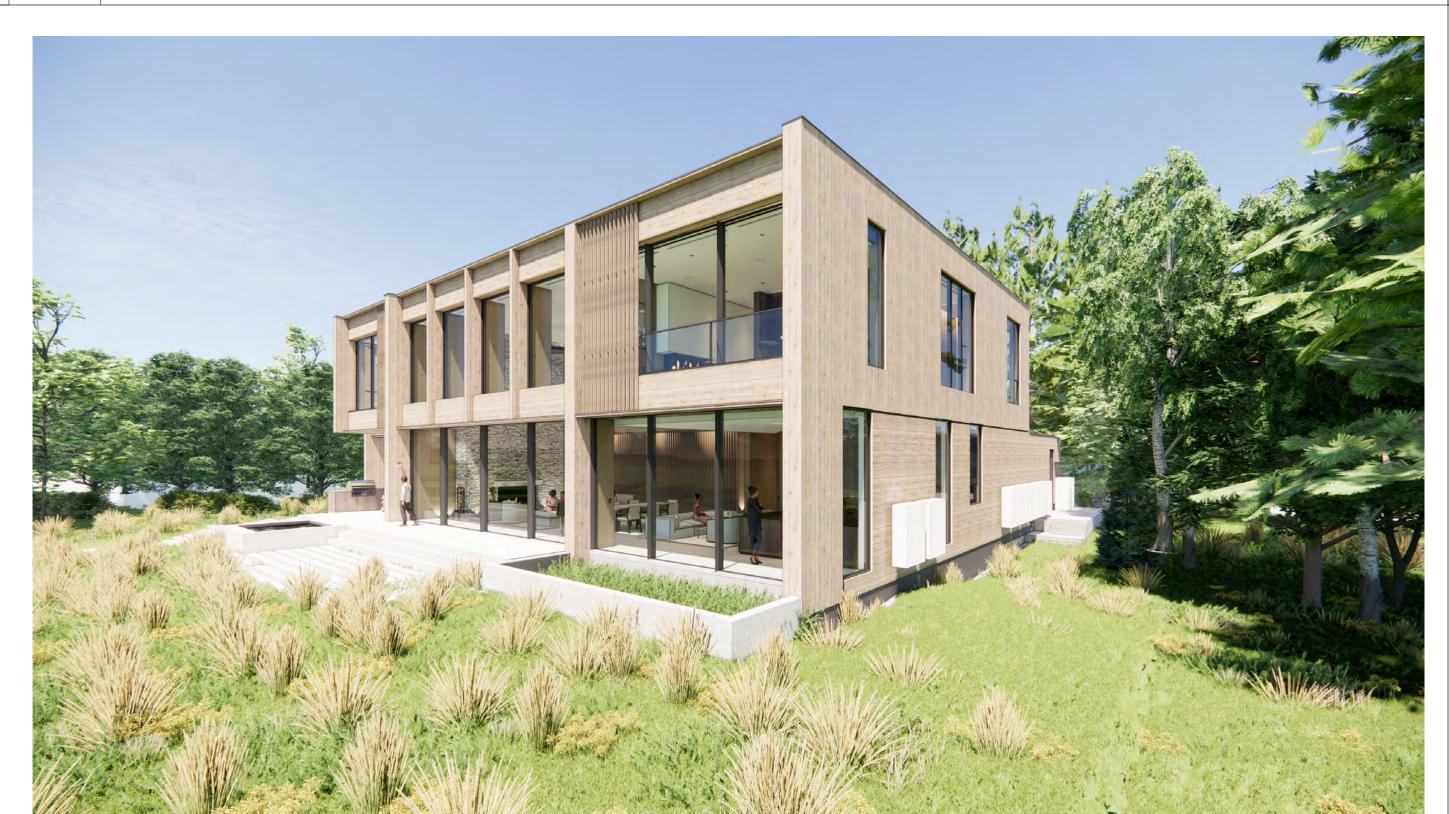

3 | SCALE: NTS | S ELEVATION



SCALE: NTS | SE PERSPECTIVE / BACKYARD



[A] INTEGRALLY COLORED CONCRETE TO MATCH GRANITE




[B] STAINED SAWN CEDAR



[C] FREEFORM NATURAL STONE



[D] LIGHT GRAY PAVERS

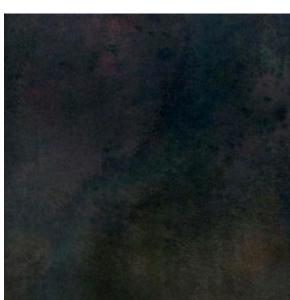

2 | SCALE: NTS | SW PERSPECTIVE / BACKYARD

[E] BLACK POWDER-COATED METAL

**450 WOOD RIVER** 

OWNER:

**450-490 WOOD RIVER, LLC** ATTN: FRAZIER CAVNESS P.O. BOX 14001-174 KETCHUM, ID 83340

PROJECT ARCHITECT: RO | ROCKETT DESIGN 1031 W. MANCHESTER BLVD. UNIT 6

INGLEWOOD, CA 90301

TEL: 213.784.0014 CONTRACTOR:

GEOTECHNICAL ENGINEER:

BUTLER ASSOCIATES, INC. P.O. BOX 1034 KETCHUM, ID 83340

TEL: 208.720.6432

CIVIL ENGINEER: BENCHMARK ASSOCIATES

100 BELL DRIVE KETCHUM, ID 83340 TEL: 208.726.9512

LANDSCAPE ARCHITECT:

FIELD STUDIO LANDSCAPE ARCHITECTS 722 N. ROUSE AVENUE BOZEMAN, MT 59715

STRUCTURAL ENGINEER: LABIB FUNK & ASSOCIATES 319 MAIN STREET EL SEGUNDO, CA 90245

TEL: 406.551.2098

TEL: 213.239.9700 MEP ENGINEER:

CONSULTING ENGINEERING SERVICES (CES) 1001 W OAK BLDG BOZEMAN, MT 59715 TEL: 406.272.0352

LIGHTING: KGM ARCHITECTURAL LIGHTING 270 CORAL CIRCLE EL SEGUNDO, CA 90245 TEL: 310.552.2191

AUDIO VIDEO SYSTEMS, INC. 2700 HOMESTEAD RD PARK CITY, UT 84098 TEL: 801.649.5200

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LICENSED ARCHITECT AR 987568 Jones JASON RO STATE OF IDAHO

12.13.2023 FDP APPLICATION NO DATE ISSUE

PROJECT:

BUILDING ELEVATION NOTES:
1. NOTE: PLEASE SEE SHEET G-010 FOR PERMISSIBLE BUILDING HEIGHT DETERMINATION.
2. ALL MATERIALS TO BE NON-GLARE FINISH, TYP
3. SEE G-013 FOR BUIDLING MATERIALS.

**450 WOOD RIVER** 

450 WOOD RIVER DRIVE KETCHUM, ID 83340

PROJECT NUMBER

DRAWING TITLE:


PERSPECTIVE VIEWS & **MATERIALS** 

DRAWING NUMBER:

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SCALE: NTS MATERIALS

NOT FOR CONSTRUCTION

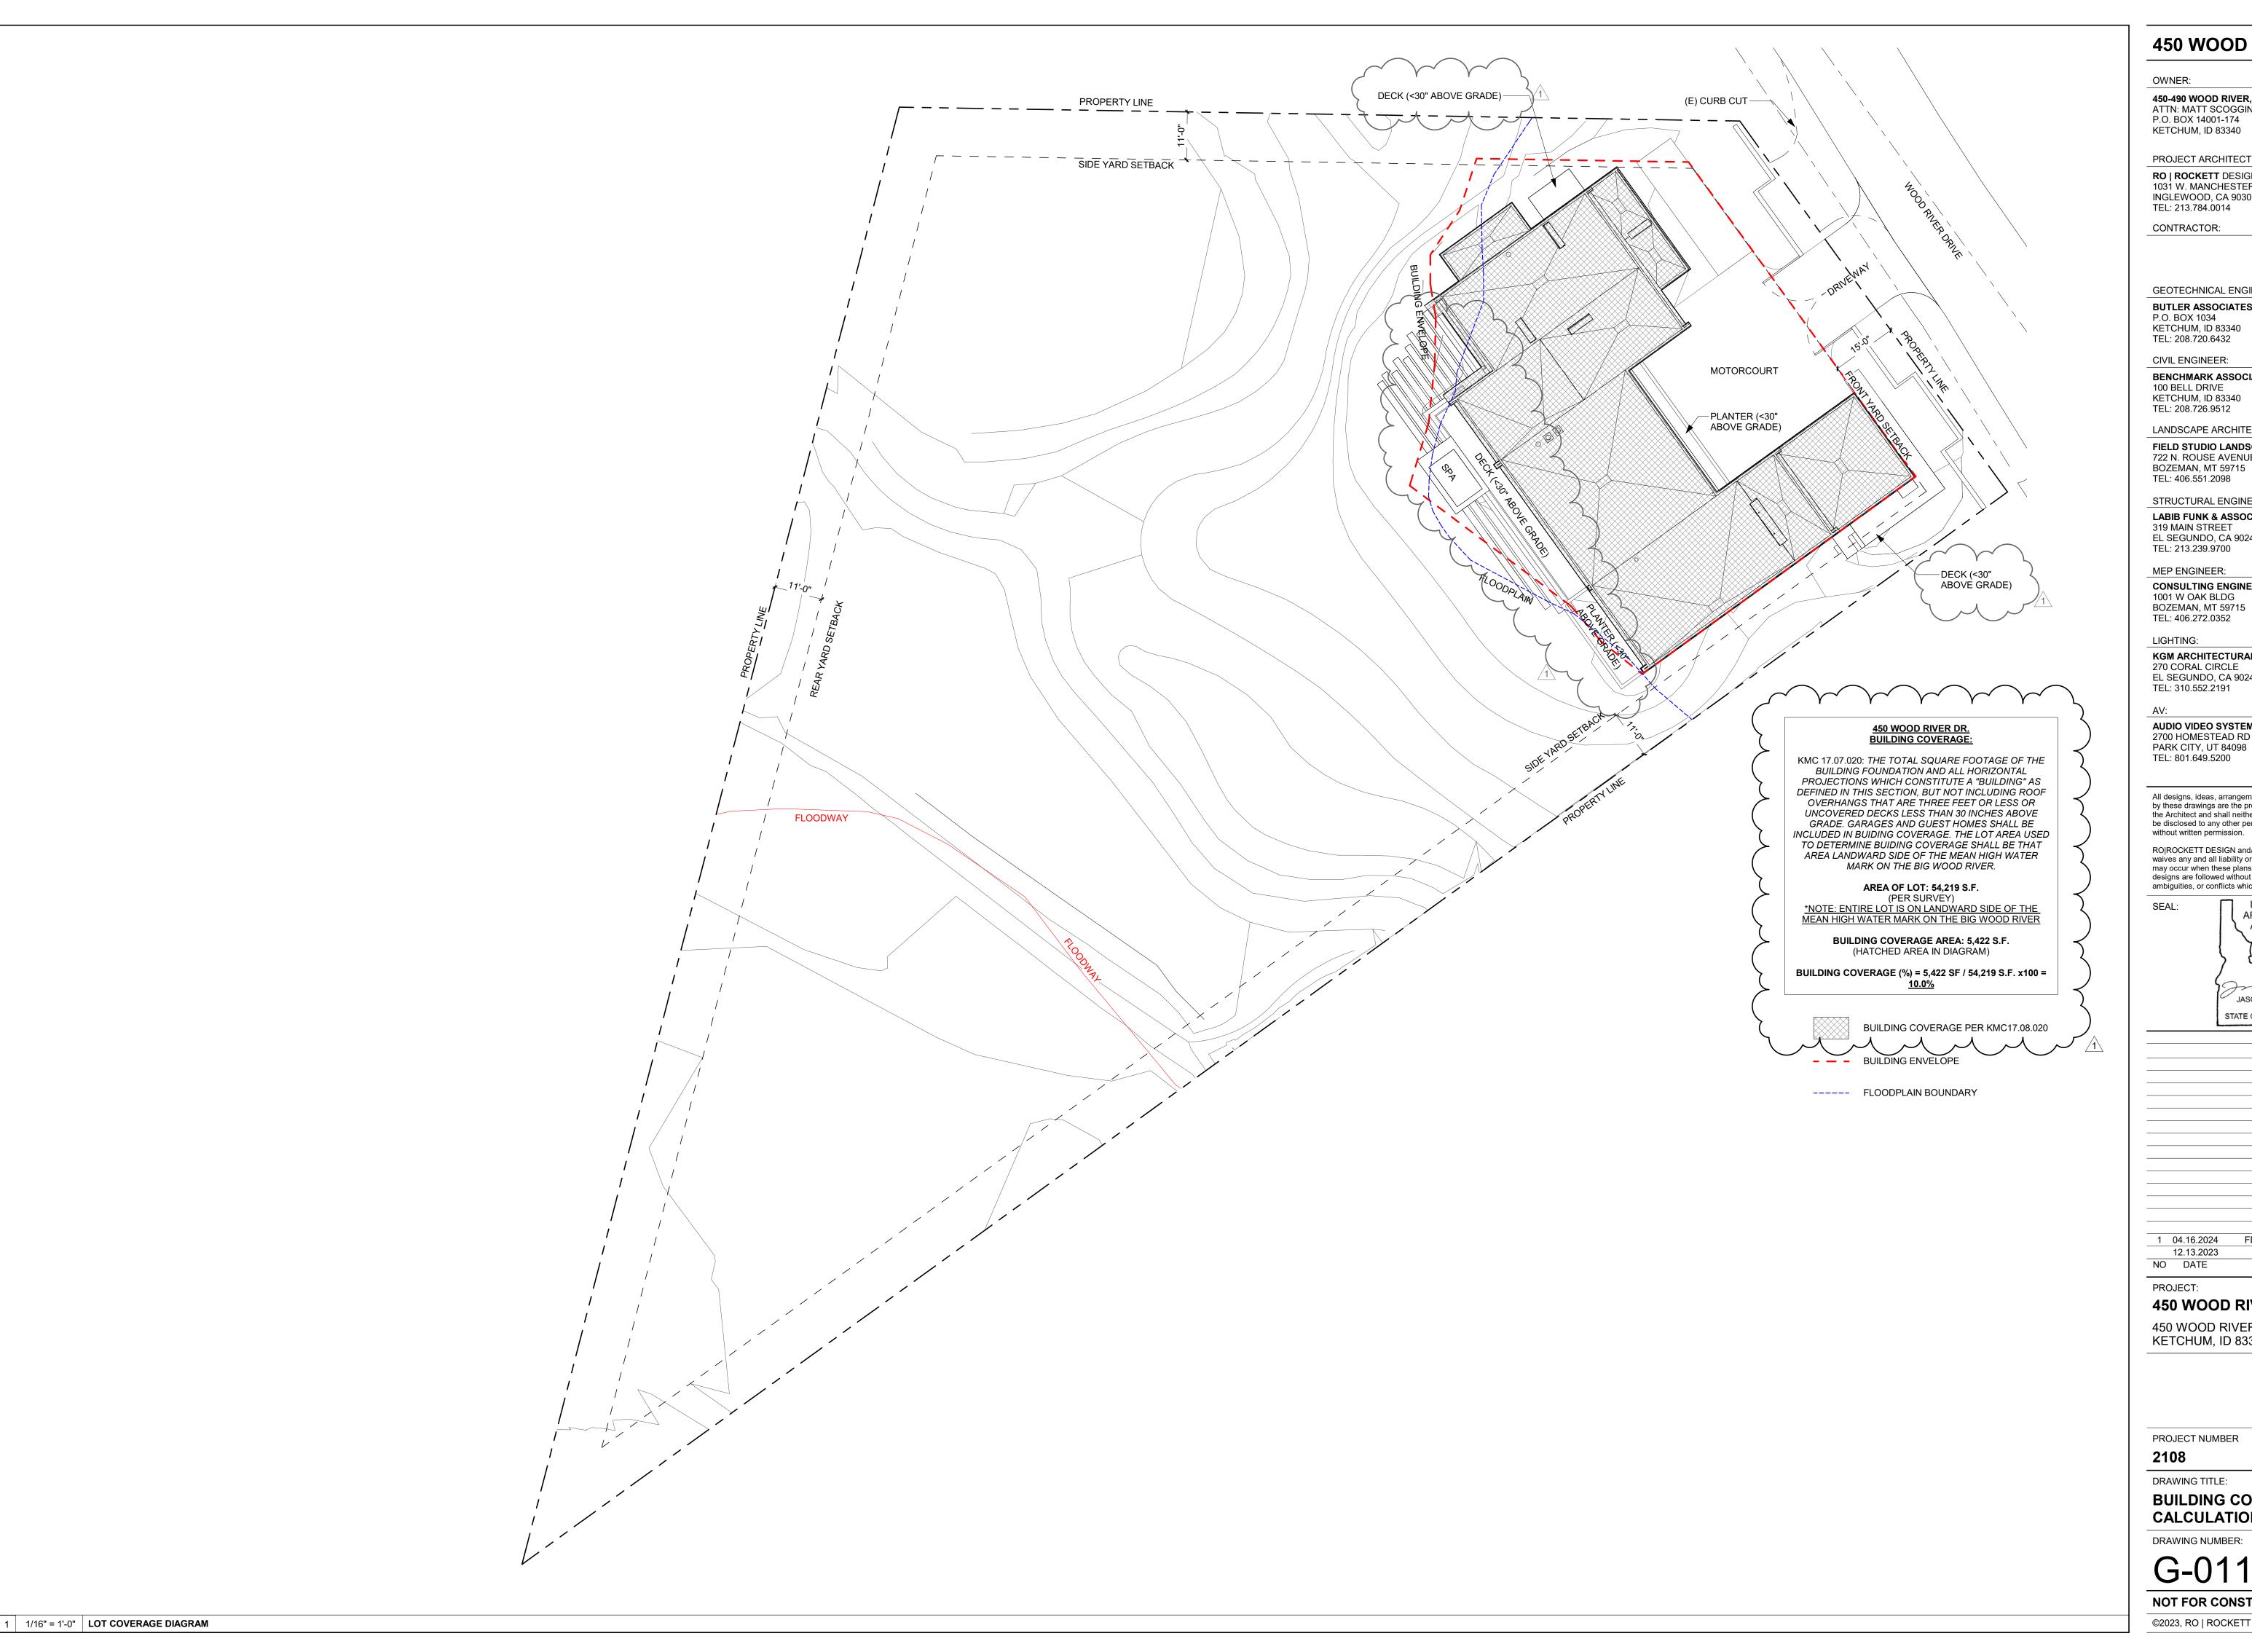

OWNER:

450-490 WOOD RIVER, LLC ATTN: MATT SCOGGINS P.O. BOX 14001-174 KETCHUM, ID 83340

PROJECT ARCHITECT:

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GEOTECHNICAL ENGINEER:

**BUTLER ASSOCIATES, INC.** P.O. BOX 1034

KETCHUM, ID 83340 TEL: 208.720.6432

CIVIL ENGINEER:

BENCHMARK ASSOCIATES 100 BELL DRIVE

TEL: 208.726.9512 LANDSCAPE ARCHITECT:

FIELD STUDIO LANDSCAPE ARCHITECTS 722 N. ROUSE AVENUE BOZEMAN, MT 59715

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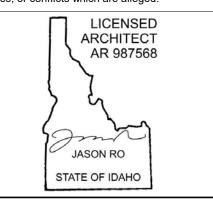
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1 04.16.2024 FDP APP RESUBMITTAL FDP APPLICATION 12.13.2023 NO DATE ISSUE

PROJECT:

**450 WOOD RIVER** 

450 WOOD RIVER DRIVE KETCHUM, ID 83340

PROJECT NUMBER

DRAWING TITLE:

**BUILDING COVERAGE CALCULATIONS** 

DRAWING NUMBER:

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| IDENTIFIER | DESCRIPTION                     | LOCATION                                       | MANUFACTURER                  | MODEL                             | DIMENSIONS        | SPECIES/COLOR  | FINISH   | COMMENTS   |
|------------|---------------------------------|--|-------------------------------|-----------------------------------|-------------------|--|--|--|
| BRK-1      | FIREBRICK                       | RM 101 FP-1, RM 111 FP-2. DECK FP-4            | ISOKERN                       | FIRE BRICK                        | 9" x 4.5" x 1.25" | BLACK - SPLIT  | MATTE  | CUT FIREBRICK IN HALF ALONG LONG EDGE AND INSTALL IN A STACKED BOND W/ GROUT TO MATCH, FINISHEI SIZE 9" x 2" x 1.25"   |
| PX-1       | EPOXY RESIN                     | RM 106, 113, 204, 214 MECH ROOMS               | PENNTEK EVOLUTION COATINGS    | POLYASPARTIC POLYUREA CHIP SYSTEM | -                 | TBD  | TBD  | PROVIDE 1/16" CUSTOM COLOR FLAKE MIX   |
| 1          | TEMPERED GLASS                  | ALL SHOWER DOORS                               | VITRO OR APPROVED EQ          | STARPHIRE                         | 1/2" THICK        | CLEAR WATER WHITE                                      | POLISHED / (.1) ACID ETCHED ONE SIDE / (.2) ACID ETCHED BOTH SIDES | SIZE CRITICAL, FLAT POLISHED EDGES, TEMPERED AS REQ BY APPLICATION AND CODE  |
| -2         | FROSTED TEMPERED GLASS          | VARIES   | CUSTOM                        | -                                 | PER MANUF         | SEE WINDOW SCHEDULE                                    | FROSTED  | SEE WINDOW SCHEDULE  |
| -4         | TEMPERED MIRROR GLASS           | ALL BATHROOMS                                  | VITRO OR APPROVED EQ          | STARPHIRE                         | 1/4" THK          | MIRROR   | POLISHED   | SIZE CRITICAL, FLAT POLISHED EDGES   |
| 5          | TINTED TEMPERED MIRROR GLASS    | RM 113 POWDER                                  | BENDHEIM OR APPROVED EQ       | -                                 | 1/2" THK          | BRONZE TINTED MIRROR                                   | ANTI-GLARE   | SIZE CRITICAL, FLAT POLISHED EDGES   |
| 1          | LEATHER                         | ENTRY DOOR PULL                                | EDELMAN                       | TBD                               |                   | BROWN  | SMOOTH   | PROVIDE SADDLE STITCHING   |
| -1         | PTD SHEET METAL                 | EXTERIOR FLASHING & REVEALS                    | DREXEL OR EQUAL               | TBD                               | 22 GA             | TBD  | LOW GLOSS  | -  |
| -2         | PTD PLATE STEEL / BAR STOCK     | VARIES   | CUSTOM                        | CUSTOM COLD ROLLED                | SEE DWGS          | TBD  | PRIMED + PAINTED   | -  |
| M-1        | ACRYLIC LAMINATE                | RM 213 LAUNDRY CSWK OUTERS                     | FENIX OR APPROVED EQ          | J0032 BIANCO KOS                  | -                 | WHITE  | WHITE  | -  |
| M-2        | MELAMINE ON MDF                 | RM 213 LAUNDRY CSWK INNERS                     | -                             | -                                 | -                 | WHITE  | WHITE  | -  |
| S-1        | GWB PLASTER FINISH WET LOCATION | ALL BATHROOMS                                  | TEXSTON                       | HYDROLIME 125                     | -                 | CM-6918-REG-SDGNS-031822                               | MATTE  | TROWEL SMOOTH, PROVIDE WATERPROOF ADDITIVE TO MIX, MATCH BENJAMIN MOORE OC-17 WHITE DOVE   |
| .1         | GWB PAINT FINISH                | INT WALLS & CEILINGS                           | BENJIMAN MOORE OR APPROVED EQ | AURA                              | -                 | OC-17 WHITE DOVE                                       | EGGSHELL @ WALLS & DAMP / FLAT @ CLGNS                             | PROVIDE PRIMER & TWO COATS   |
| 1          | SOLID SURFACE                   | SHOWER NICHE, TYP                              | DUPONT                        | CORIAN                            | 1/2" THK          | RICE PAPER   | HONED  |  |
| -2         | SOLID SURFACE                   | RM 213 LAUNDRY COUNTERTOP                      | DUPONT                        | CORIAN                            | 1/2" THK          | GLACIER WHITE  | HONED  |  |
| .1         | STONE FLOOR TILE                | LEVEL 01 & LEVEL 02 FLOORS                     | MATERIAL BESPOKE STONE + TILE | AVALON KAHLA GREY                 | 12"x24"           | KAHLA GREY   | FLAMED   | 3/16" GROUT JOINT, COLOR TBD   |
| -2         | FREEFORM STONE WALL             | RM 101 FP-1 & DECK FP-4 WALLS                  | SELECT STONE                  | MUDDY CREEK TUMBLED ASHLAR        | R VARIES / 2" THK | MUDDY CREEK  | NATURAL CLEFT  | RANDOMIZED INSTALLATION W./ OVERGROUTED JOINTS, COLOR TBD BY ARCHITECT   |
| -3         | ROUGH STONE SLAB                | RM 113 POWDER; RM 101 FP MANTLE                | SELECT STONE                  | NIAGARA DOLOMITE                  | 3/4" THK UNO      | LIMESTONE  | SPLITFACE  |  |
| 4          | DARK STONE SLAB                 | RM 102 KITCHEN & RM 111 REC                    | STONELAND                     | TBD                               | 3/4" THK UNO      | TBD  | HONED  | PROVIDE \$80/SF MATERIAL COST ALLOWANCE, STONE TO BE SHIPPED FROM LOS ANGELES  |
| -5         | STONE SLAB                      | RM 108, 208, 212, 216 TYP BATH COUNTER & WALLS | STONELAND                     | TBD                               | 3/4" THK UNO      | TBD  | HONED  | PROVIDE \$40/SF MATERIAL COST ALLOWANCE, STONE TO BE SHIPPED FROM LOS ANGELES  |
| -6         | HONED STONE SLAB                | RM 113 POWDER                                  | SELECT STONE                  | NIAGARA DOLOMITE                  | 3/4" THK UNO      | LIMESTONE  | HONED  | 3/16" GROUT JOINT, COLOR TBD   |
| 7          | STONE SLAB                      | RM 206 PRIMARY BATH WALLS & COUNTERS           | STONELAND                     | TBD                               | 3/4" THK UNO      | TBD  | HONED  | PROVIDE \$80/SF MATERIAL COST ALLOWANCE, STONE TO BE SHIPPED FROM LOS ANGELES  |
| -8         | RIVER ROCK ROOF BALLAST         | LOW ROOFS                                      | SELECT STONE                  | -                                 | 1.5" MIN DIAMETER | R GRAY RIVER ROCK                                      | SMOOTH, ROUNDED  |  |
| -9         | EXT STONE FLOOR TILE            | LEVEL 02 EXTERIOR SLIDING DOOR SILLS           | STONELAND                     | TBD                               | 3/4" THK UNO      | BLACK GRANITE  | TBD  |  |
|            | CERAMIC TILE                    | RM 213 LAUNDRY BACKSPLASH                      | ANN SACKS                     | ELEMENTS FIELD TILE               | 1.75" x11"        | WHITE  | MATTE  | STACKED BOND 1/8" NON-SANDED GROUT JOINT, COLOR TBD  |
| 1          | UPHOLSTERY                      | RM 100 FOYER & RM 104 MUD                      | TBD                           | TBD                               | TBD               | TBD  | TBD  | PROVIDE MATERIAL ALLOWANCE OF \$150/YD   |
| -1         | WOOD SIDING - INTERIOR          | INTERIOR WD WALLS & CEILINGS                   | MADERA                        | WALL / CEILING PANELING           | 3/4" x 6"         | ENGINEERED PLAIN SAWN AMERICAN WHITE OAK T&G<br>PANELS |  | CONCEALED FASTENERS. SEE INT ELEVATIONS FOR ORIENTATION. PROVIDE MATERIAL ALLOWANCE OF \$20/S  |
| E          | WOOD SIDING - EXTERIOR          | EXTERIOR WD WALLS & CEILINGS                   | RESAWN LUMBER                 | TAKU - T&G SIDING                 | 3/4" x 6"         | WEATHERED ALASKAN YELLOW CEDAR                         | TAKU   | SEAL ALL SIDES. CONCEALED / BLIND SS FASTENERS. SEE EXT ELEVATIONS FOR SIDING ORIENTATION.   |
|            | EXTERIOR WOOD SLAT              | EXTERIOR SCREENS                               | RESAWN LUMBER                 | TAKU - SOLID STOCK                | SEE DWGS          | WEATHERED ALASKAN YELLOW CEDAR                         | TAKU   | SEAL ALL SIDES. CONCEALED / BLIND SS FASTENERS. SEE EXT ELEVATIONS FOR SIDING ORIENTATION.   |
| 3          | SOLID WOOD                      | INTERIOR SLATS / SCREENS / DOOR FRAMES         | CUSTOM                        | -                                 | SEE DWGS          | LIVE SAWN AMERICAN WHITE OAK, MATCH WD-1               | CLEAR MATTE POLYURETHANE   |  |
| 4          | WOOD FLOORING                   | BED 1 & LEVEL 02 FLOOR                         | MADERA                        | TBD                               | 3/4" x 8"         | LIVE SAWN WHITE OAK                                    | DANIELLE   |  |
| )-5        | WOOD VENEER                     | CASEWORK / DOORS / WALL PANELS                 | GL VENEER                     | -                                 | -                 | TO BE SELECTED BY ARCHITECT                            | TO BE SELECTED BY ARCHITECT  | CLEAR PREMIUM GRADE; SOLID WOOD TRANSITION PIECES AS NEEDED; ARCHITECT TO SELECT VENEERS AN LAYOUT; SOURCED FROM GL VENEERS IN LOS ANGELES, CA VENEERS TO BE LAID UP IN SEQUENCE PER ARCHITECT INSTRUCTIONS AND CUSTOM MOUNTED TO BALTIC BIRCH PLYWOOD; BOOKMATCHED AND USED SEQUENCE THROUGHOUT ROOMS |

OWNER:

450-490 WOOD RIVER, LLC ATTN: FRAZIER CAVNESS P.O. BOX 14001-174 KETCHUM, ID 83340

PROJECT ARCHITECT:

RO | ROCKETT DESIGN

INGLEWOOD, CA 90301 TEL: 213.784.0014

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CONTRACTOR:

GEOTECHNICAL ENGINEER:

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CIVIL ENGINEER:

BENCHMARK ASSOCIATES 100 BELL DRIVE KETCHUM, ID 83340 TEL: 208.726.9512

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BOZEMAN, MT 59715
TEL: 406.551.2098

STRUCTURAL ENGINEER:

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TEL: 213.239.9700

MEP ENGINEER:

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EL SEGUNDO, CA 90245

AV:

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LICENSED ARCHITECT AR 987568

JASON RO
STATE OF IDAHO

12.13.2023 FDP APPLICATION

NO DATE ISSUE

PROJECT:

450 WOOD RIVER

450 WOOD RIVER DRIVE KETCHUM, ID 83340

PROJECT NUMBER


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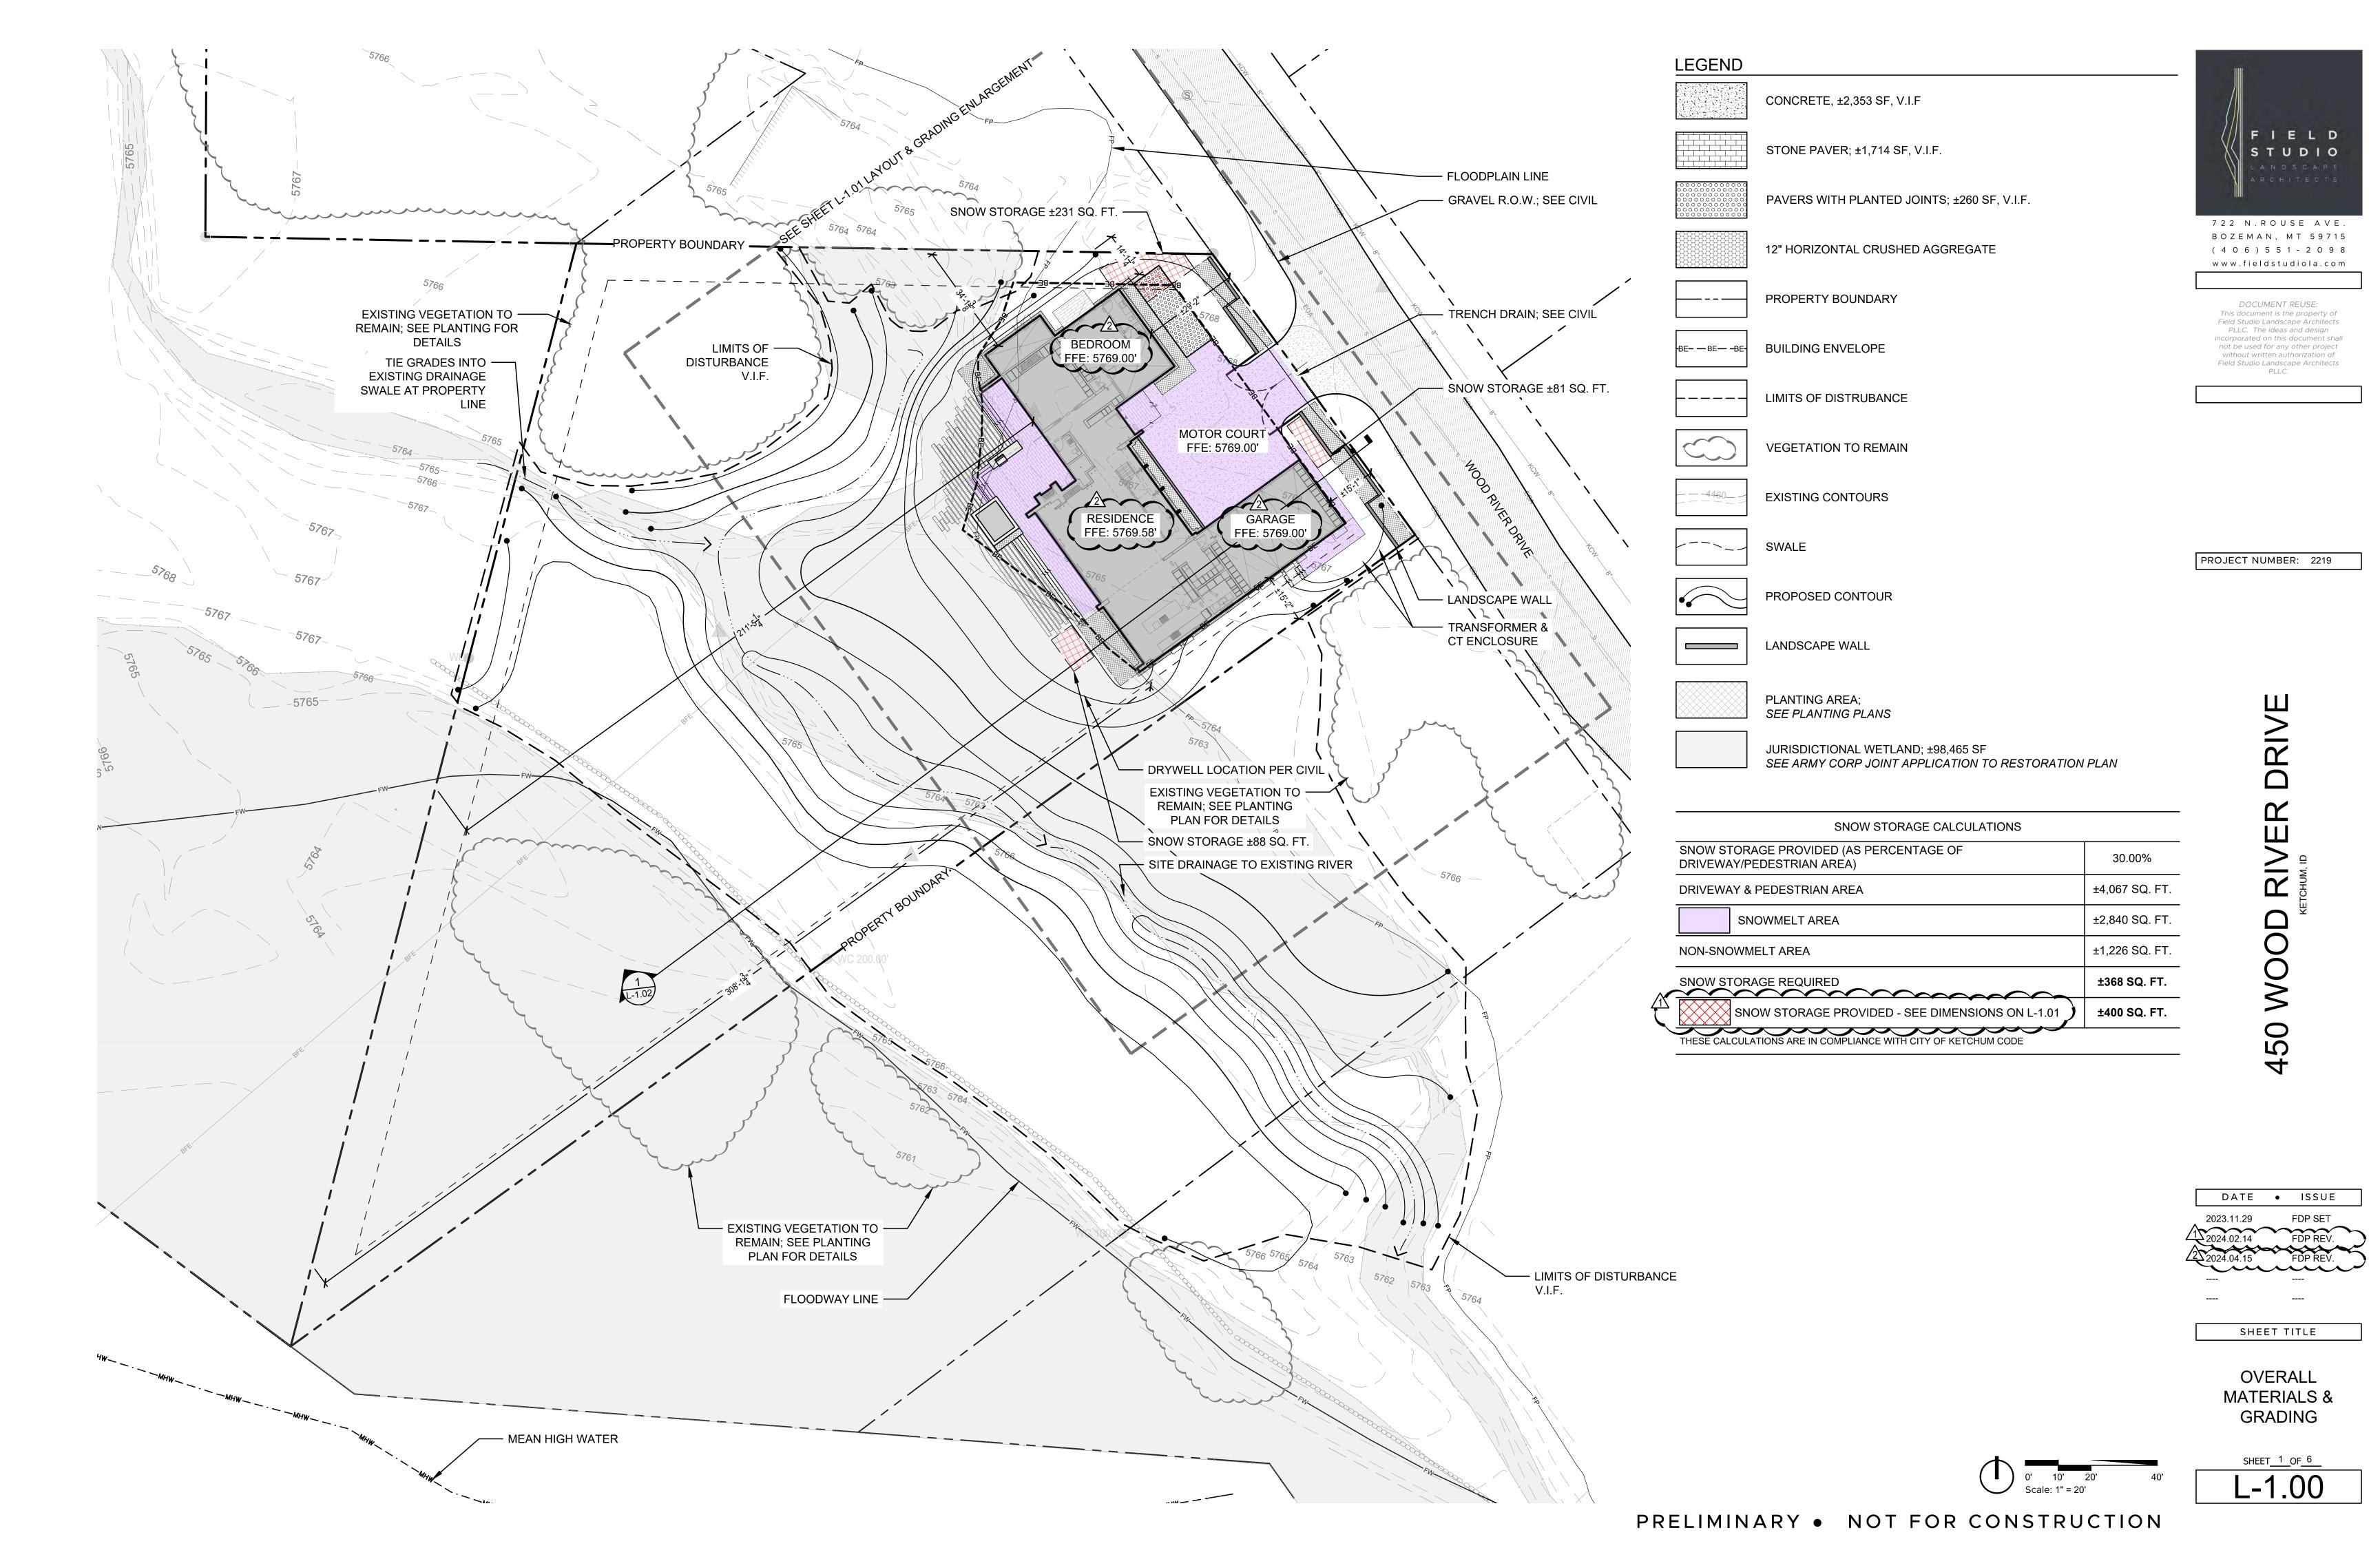
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FINISH MATERIAL
SCHEDULE


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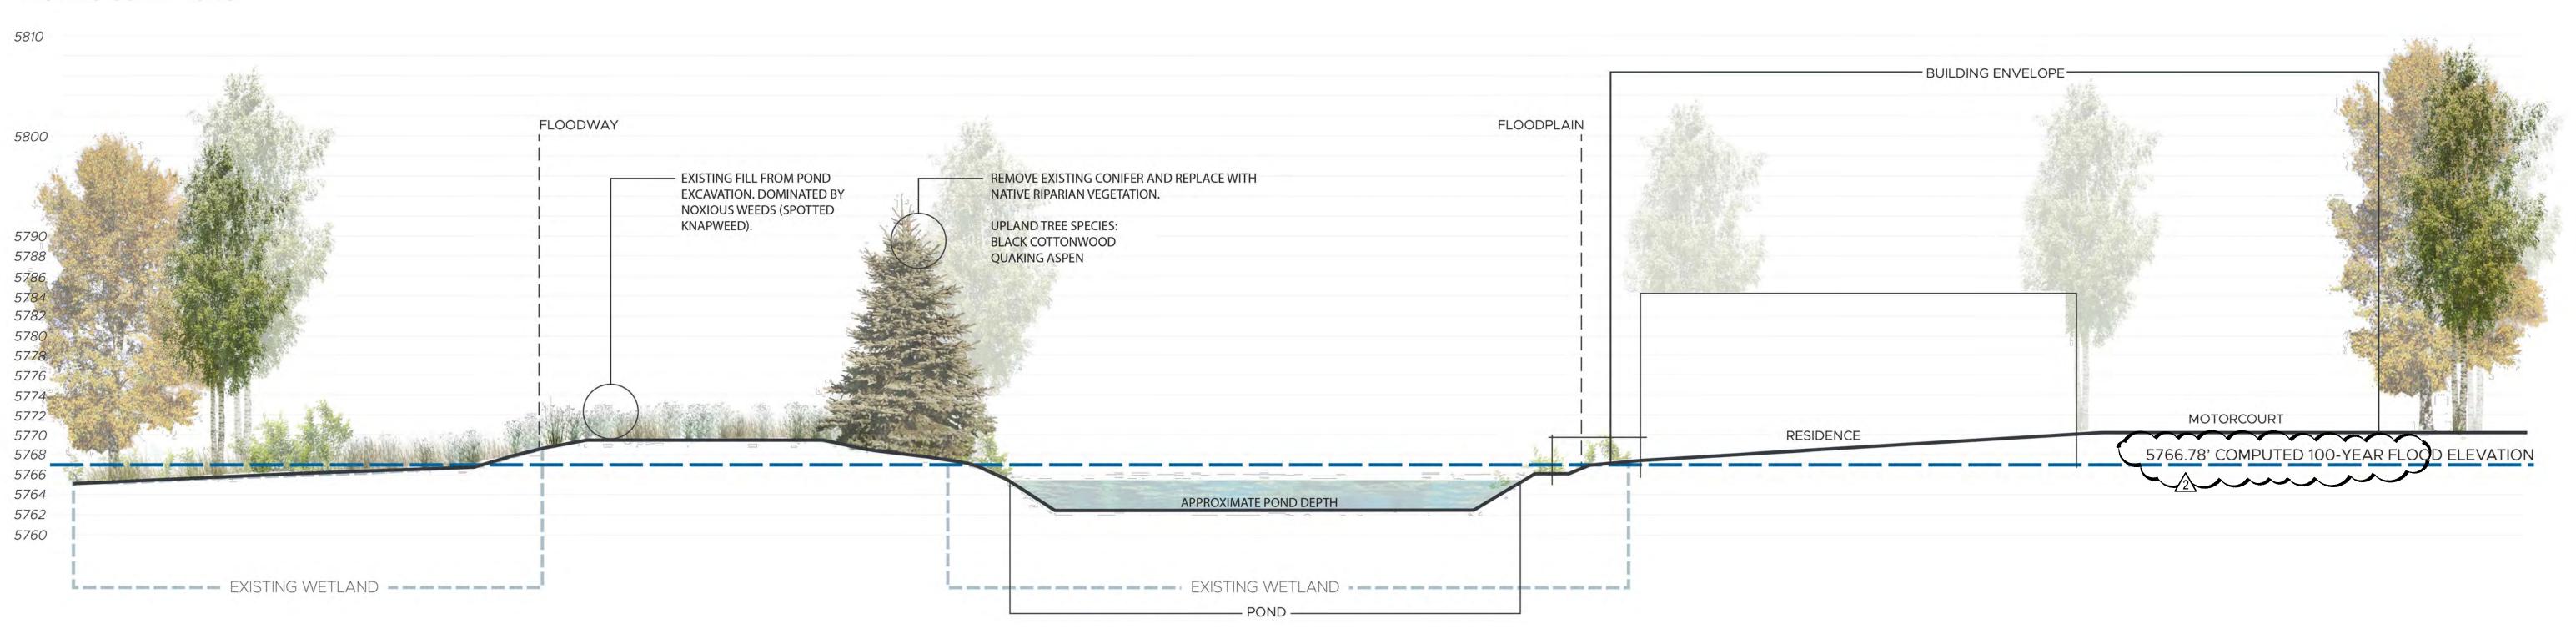
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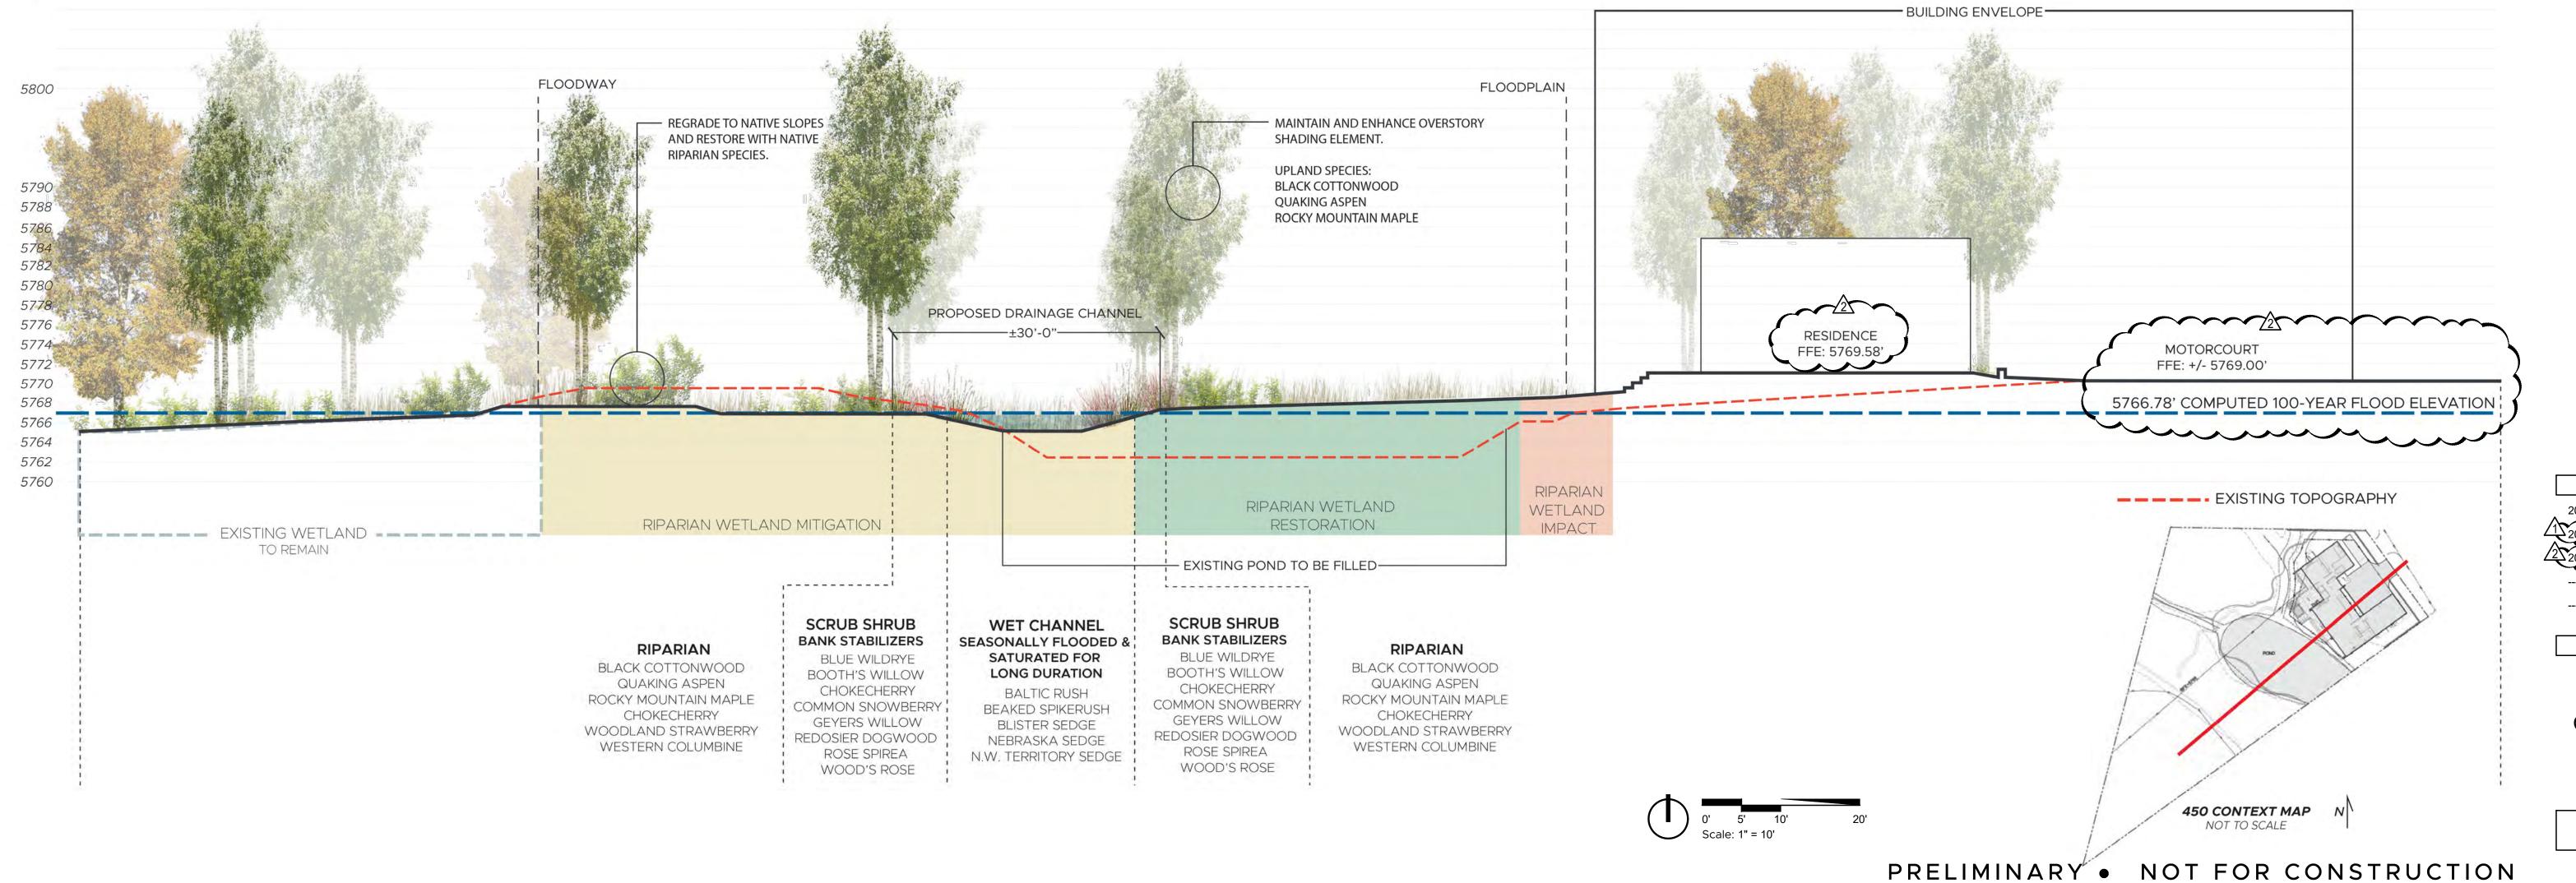
# FIELD STUDIO LANDSCAPE ARCHITECTS

722 N.ROUSE AVE. BOZEMAN, MT 59715 (406)551-2098 www.fieldstudiola.com

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PROJECT NUMBER: 2219

# PROPOSED CONDITIONS

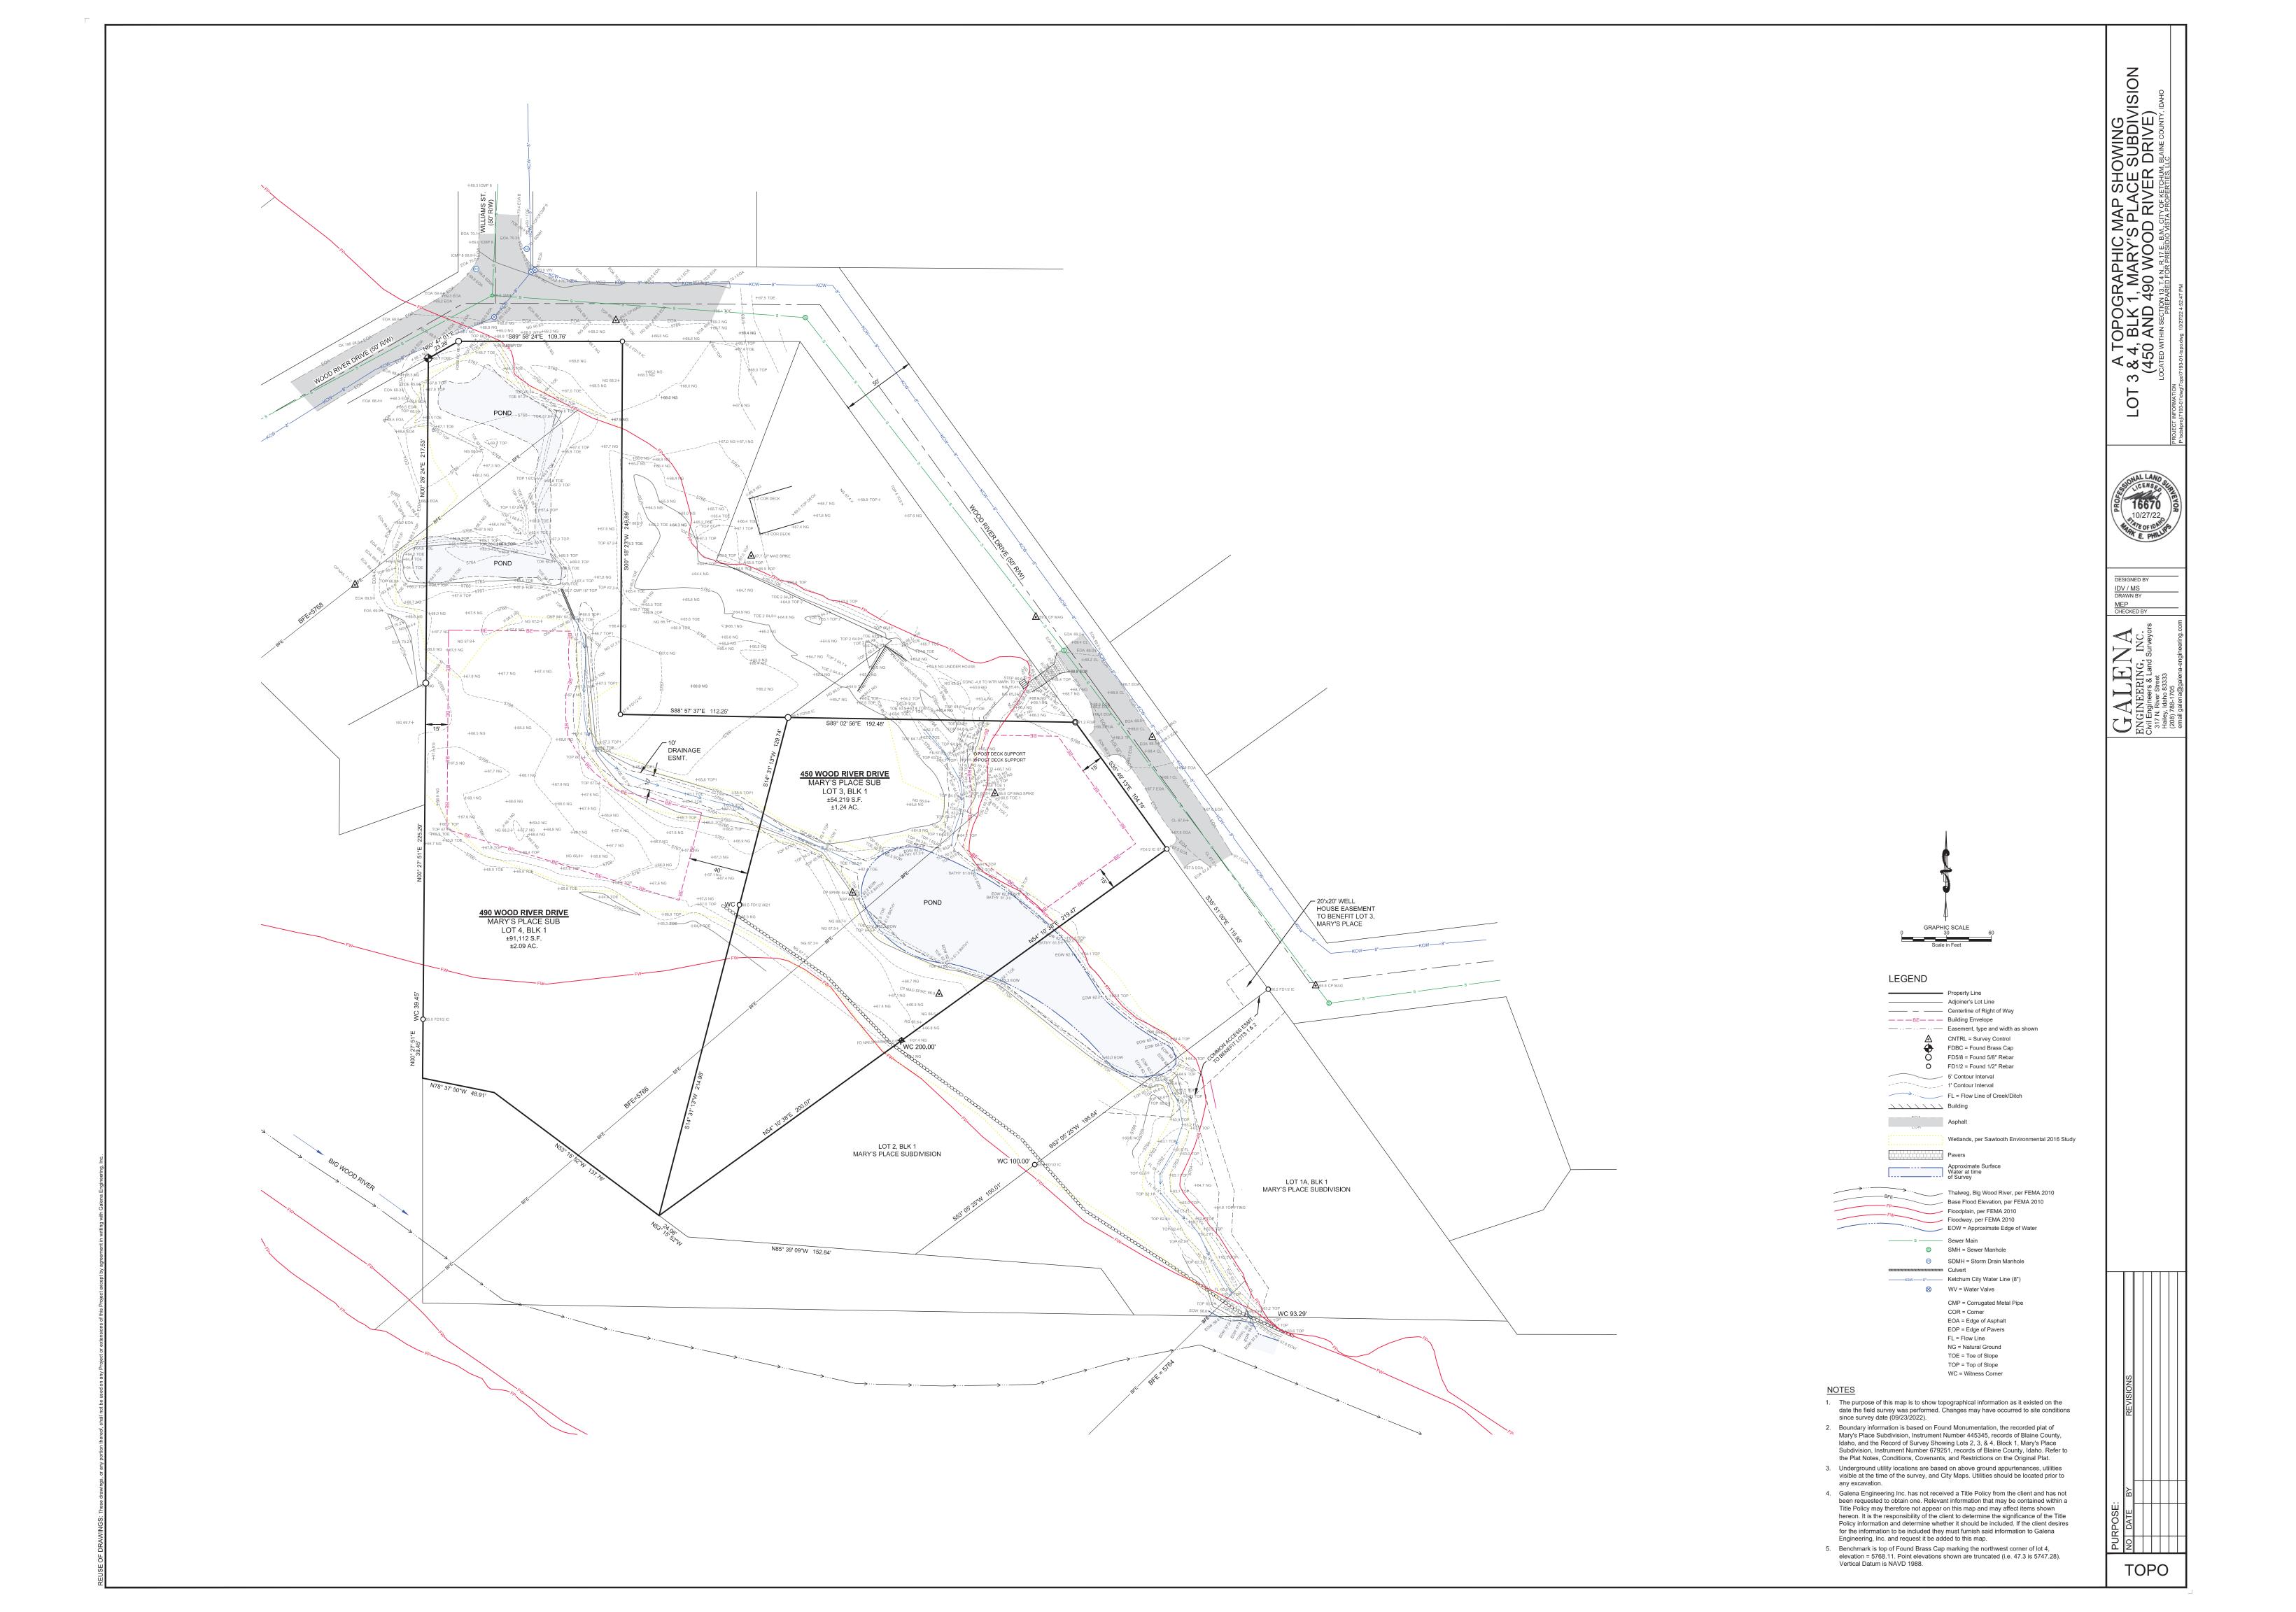

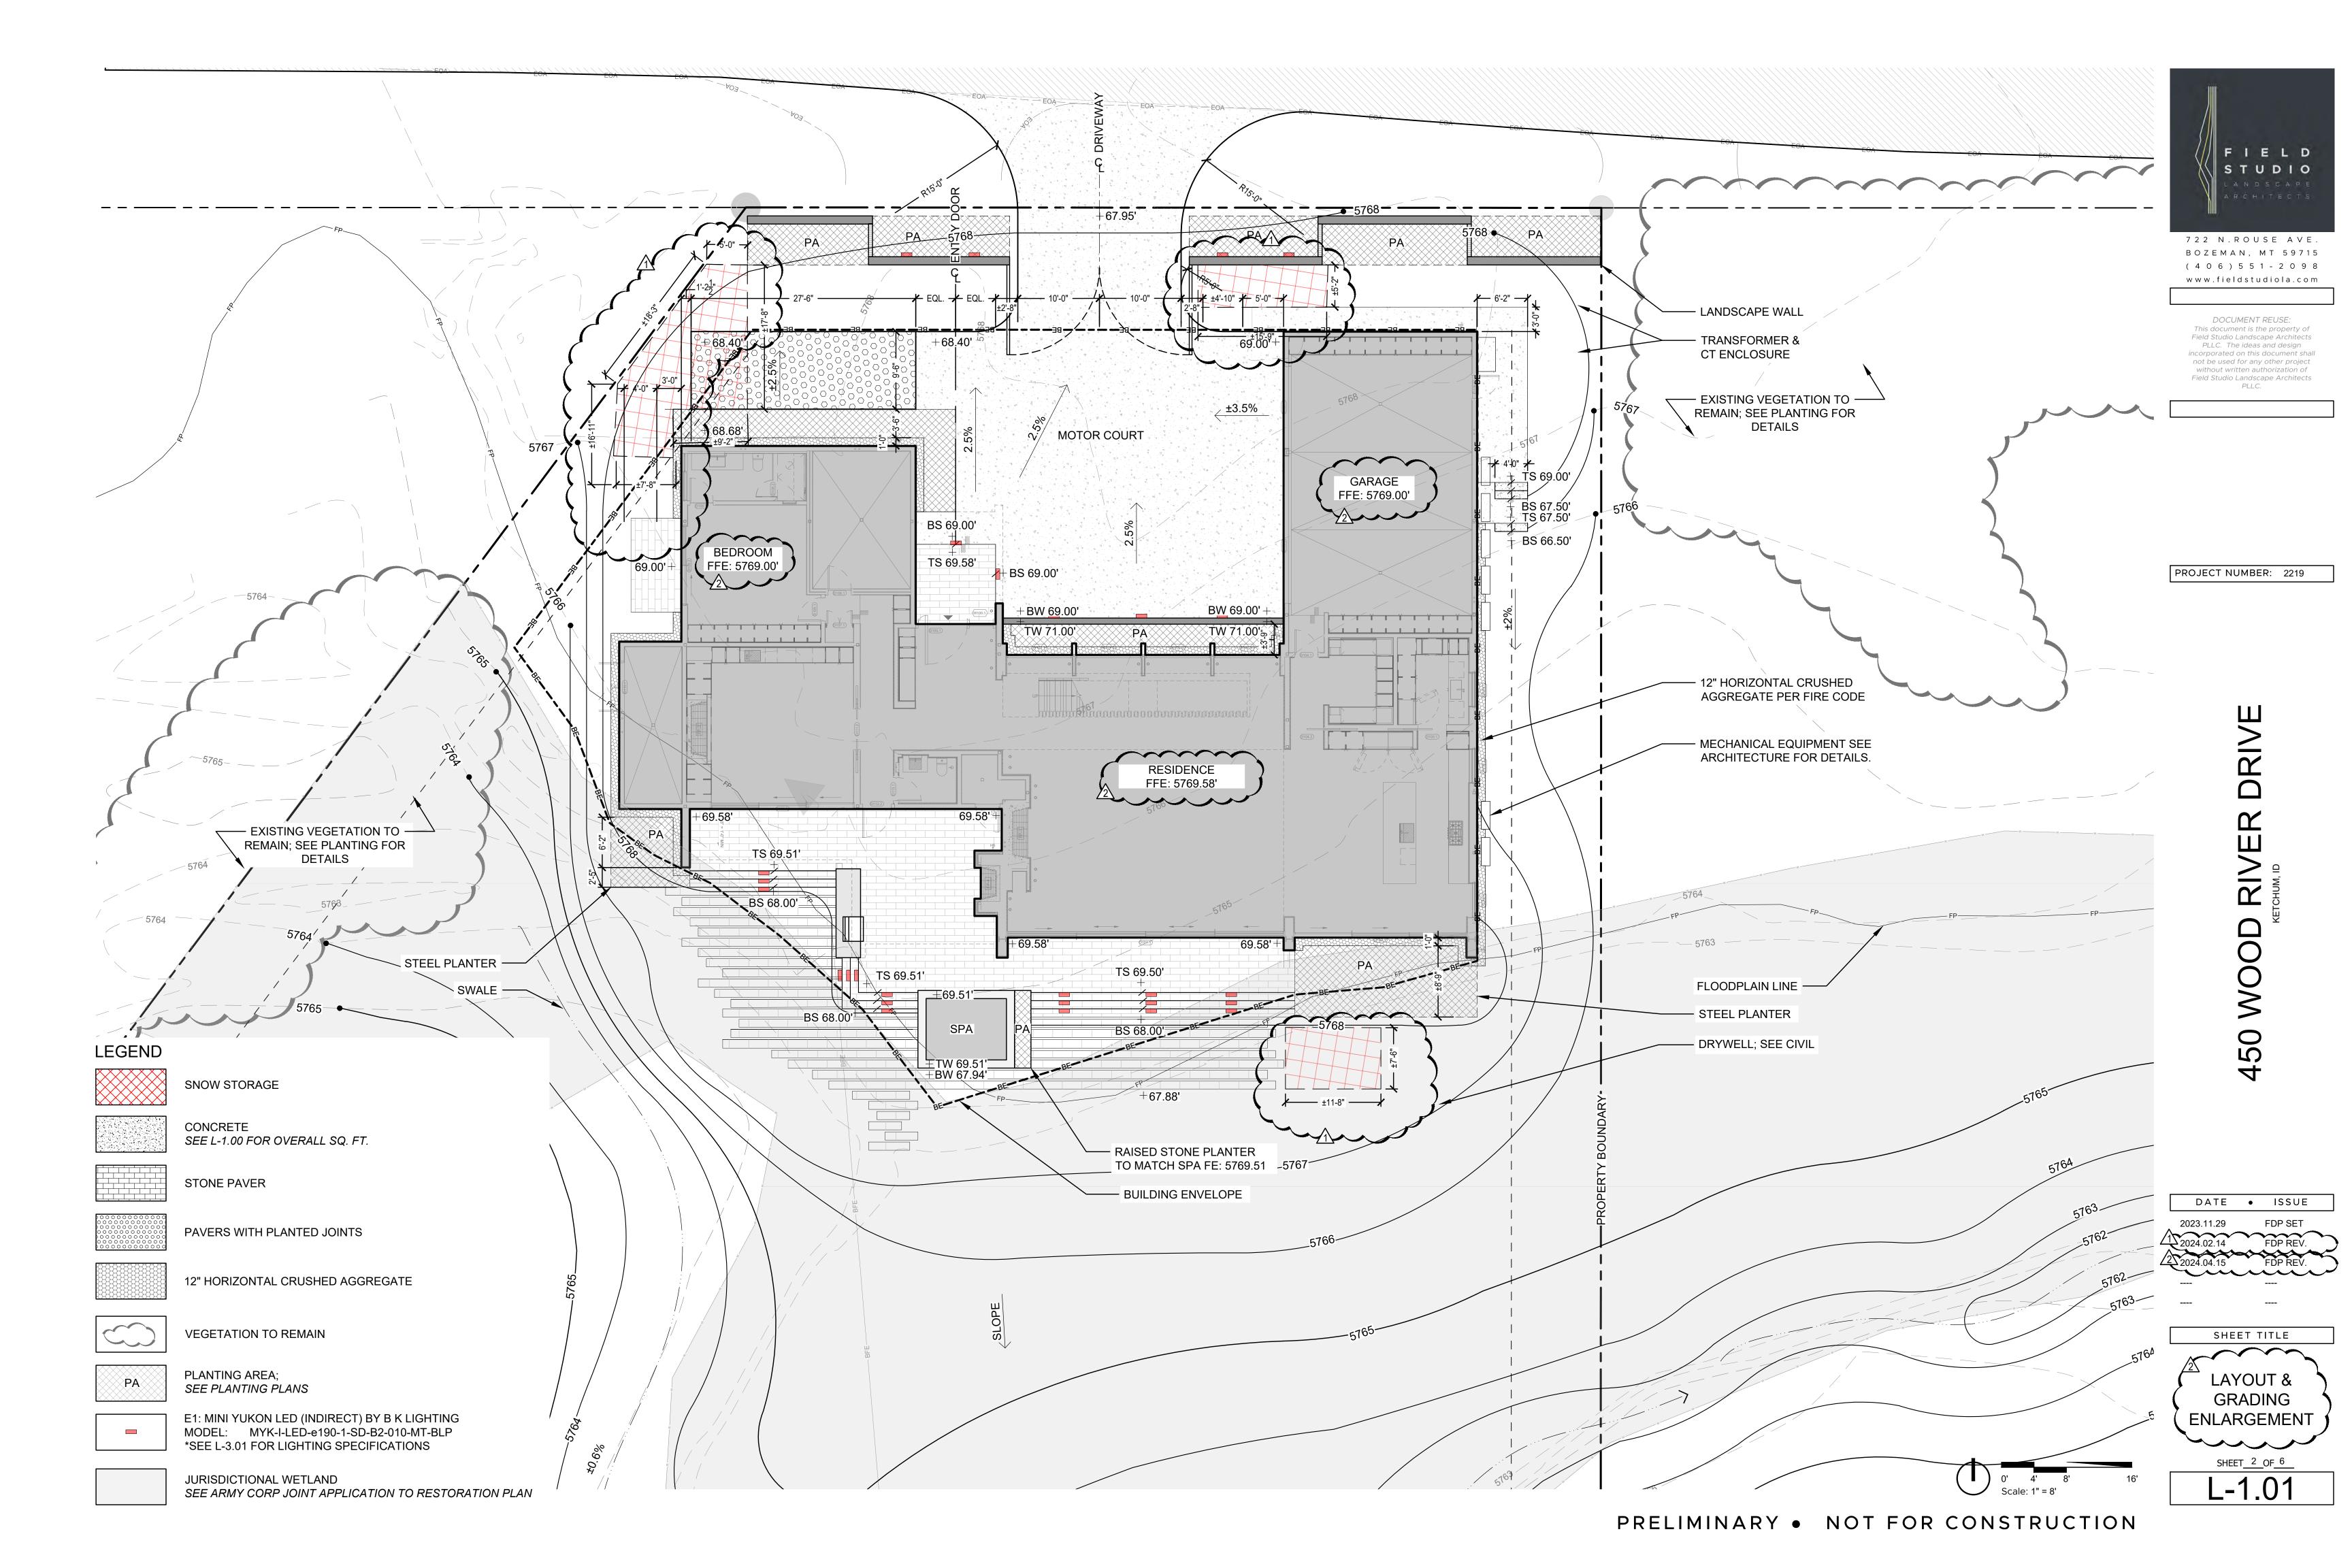DATE ISSUE

2023.11.29 FDP SET

1 2024.02.14 FDP REV.


2 2024.04.15 FDP REV.

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SHEET TITLE

CROSS SECTION

SHEET 3 OF 6 L-1.02

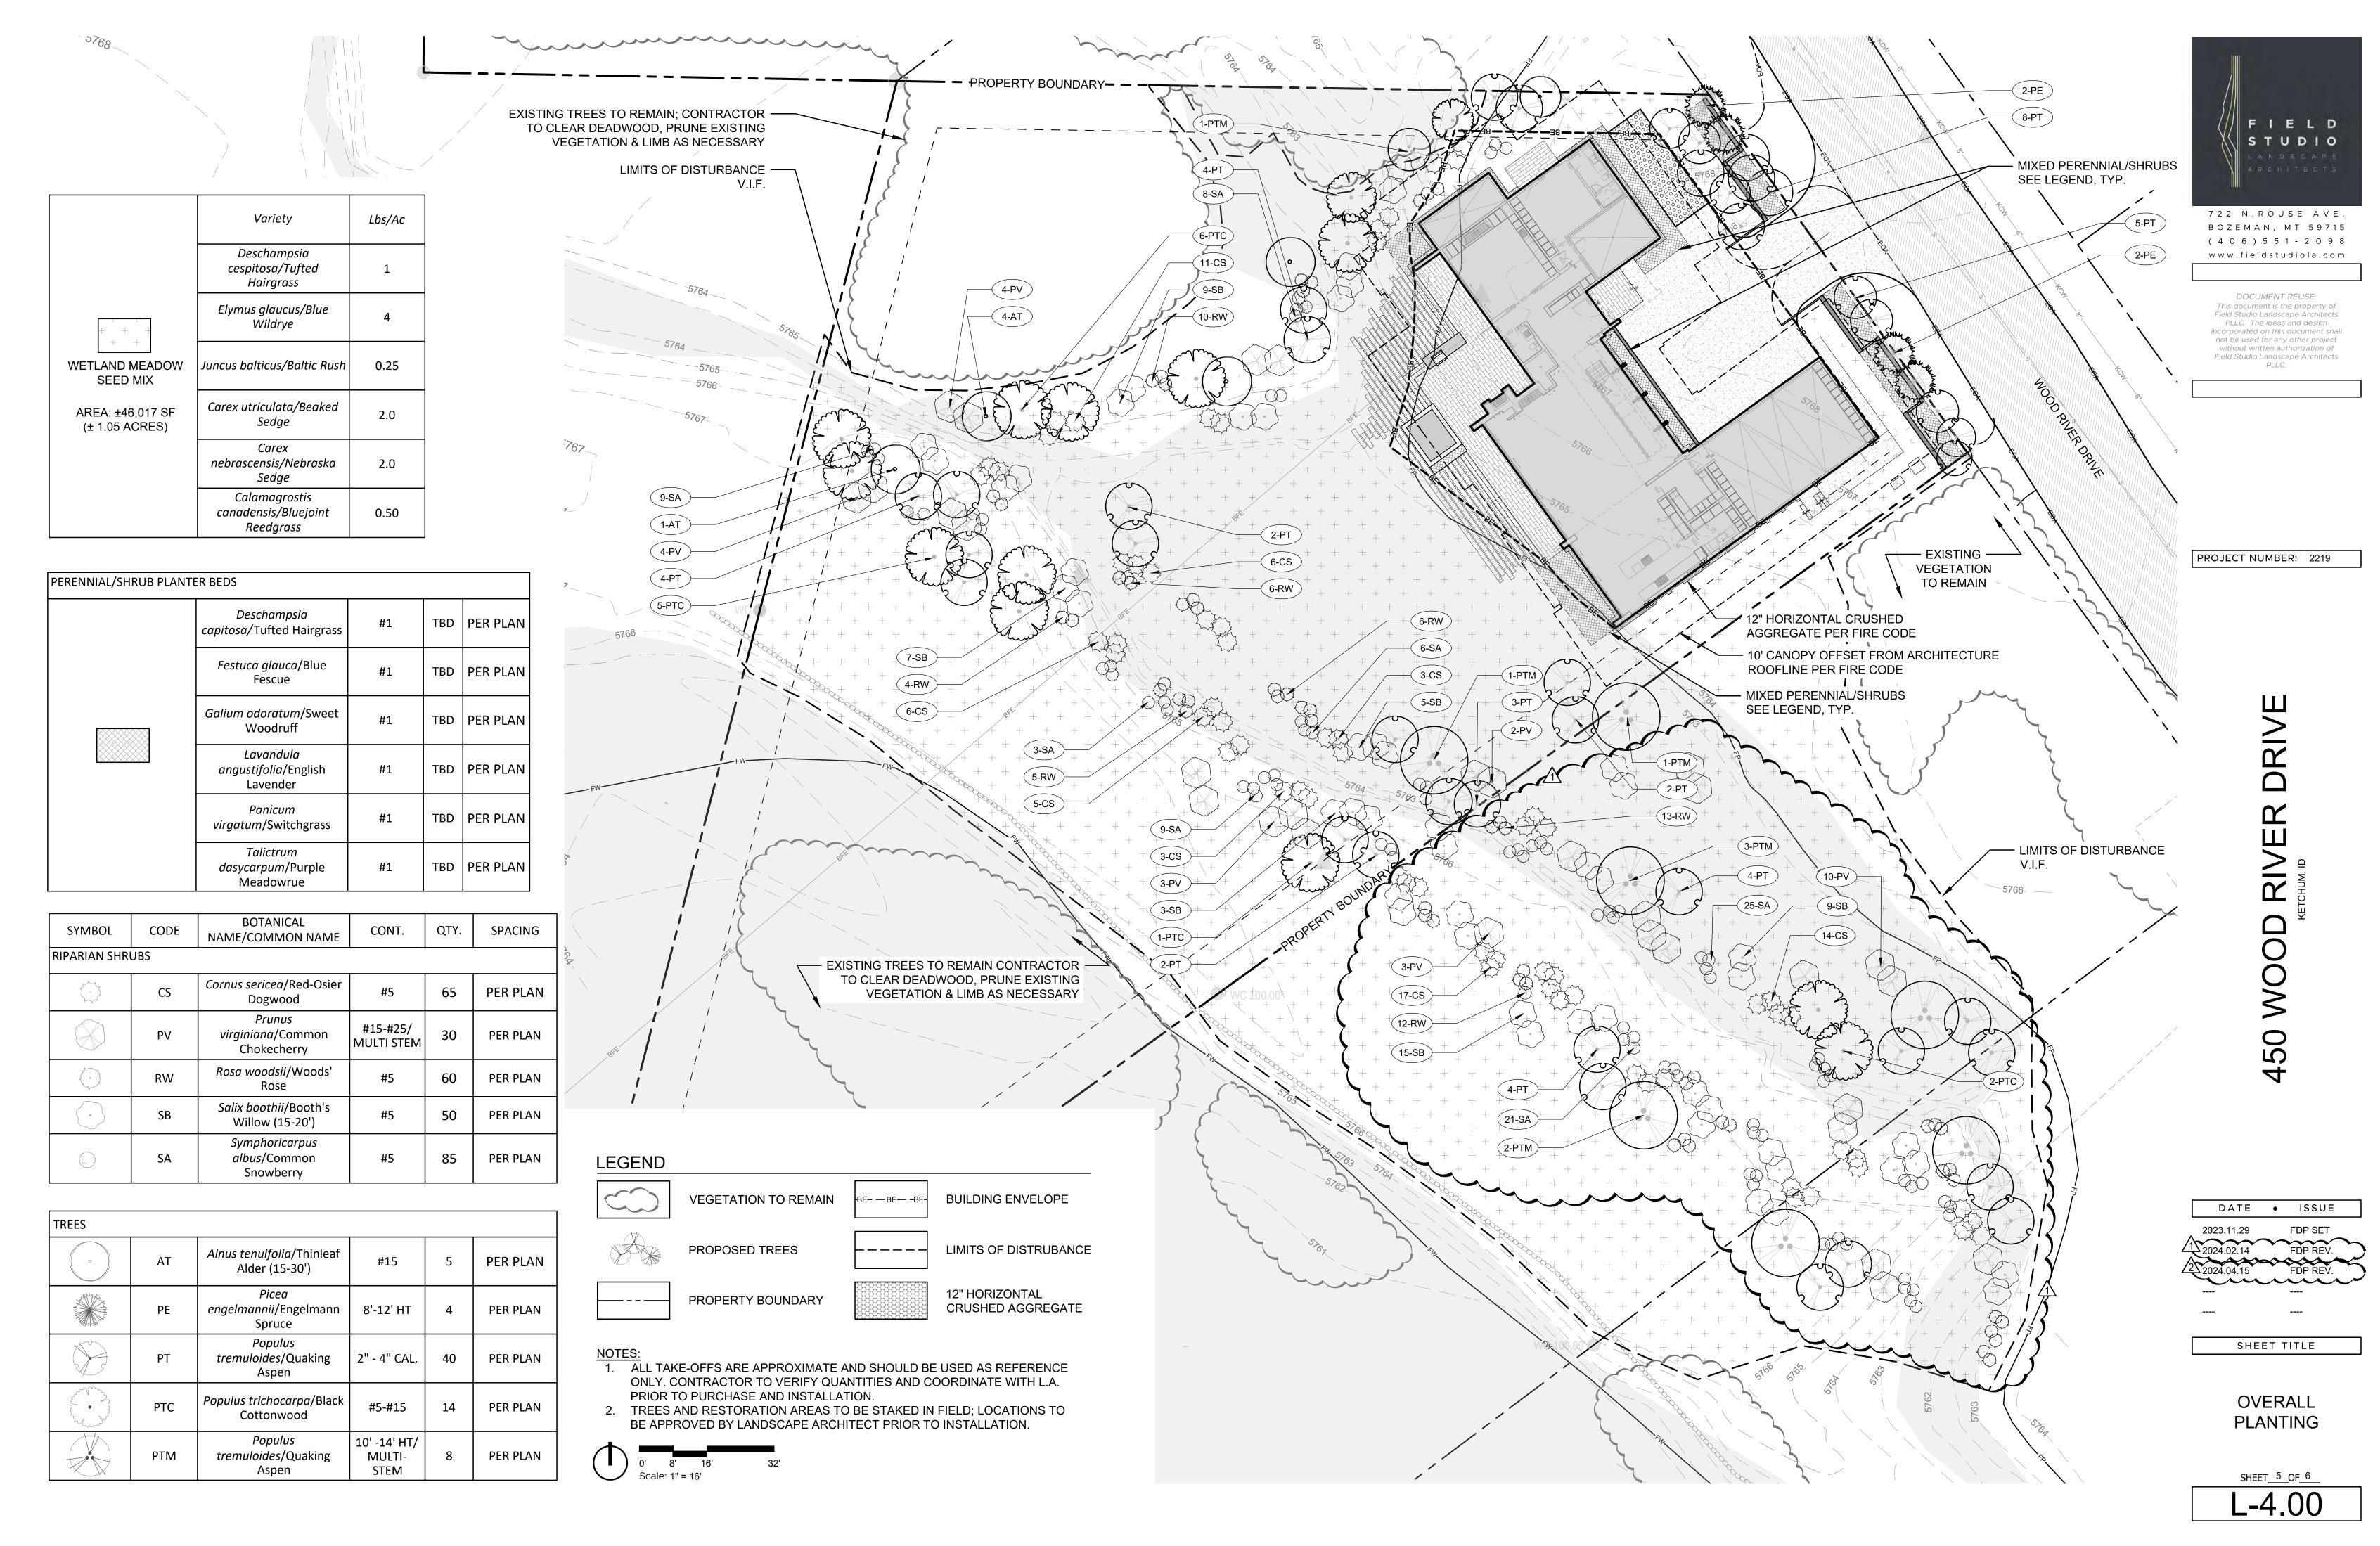


MULCH SHOULD BE 4" DEEP

2. ALL TREES 3" DIAMETER OR LARGER MAY BE STAKED FOR ONE YEAR IF PROPOSED BY LANDSCAPE CONTRACTOR AND/OR APPROVED BY OWNER'S REPRESENTATIVE.

DECIDUOUS TREE PLANTING


SCALE: 1/4" = 1'-0"

SCALE: 1/4" = 1'-0"

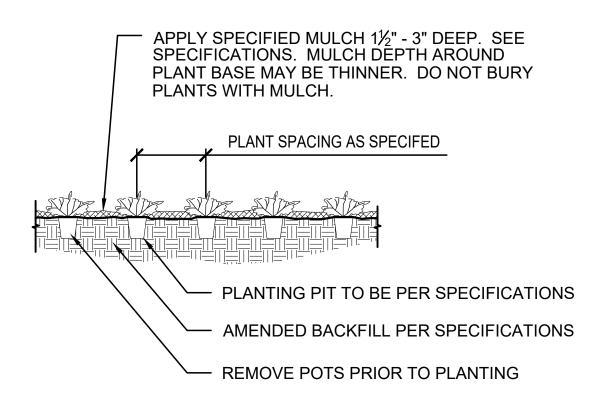


PERENNIALS AND GROUNDCOVERS

PLANT SPACING | A | B | C | D 6" | 6" | 6" | 5" | 6" 8" | 8" | 6" | 7" | 8" 12" | 12" | 8" | 10" | 12" 18" | 18" | 9" | 15½" | 18" 24" | 24" | 18" | 21" | 24" 30" | 30" | 15" | 26" | 30" 36" | 36" | 30" | 31" | 36" 48" | 48" | 30" | 42" | 48"

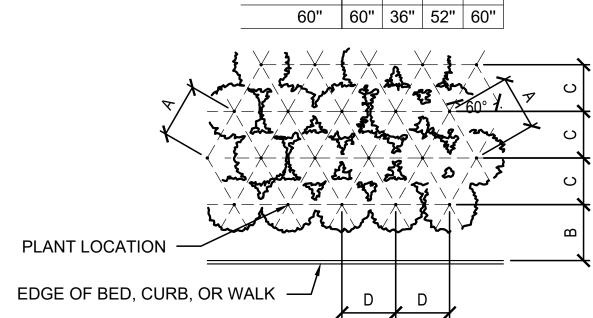

1. ALIGN FRONT ROW PARALLEL TO BED LINE

TRIANGULAR SPACING FOR PLANTING LAYOUT SCALE: 1/4" = 1'-0"

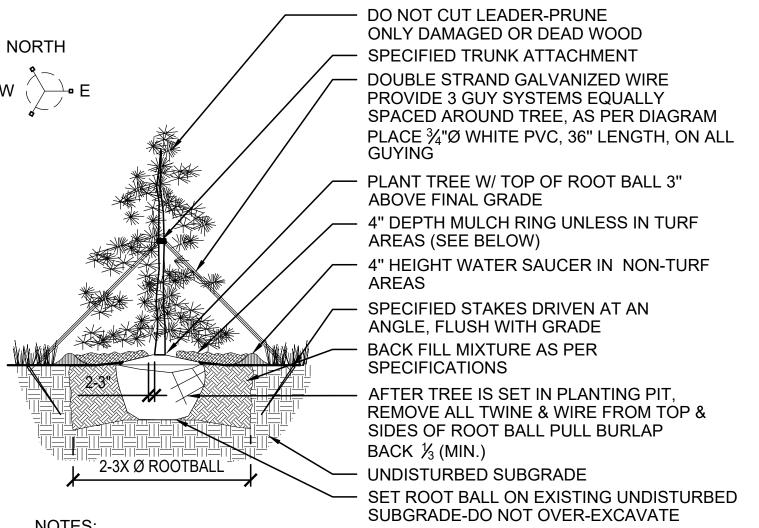


1. PULL MULCH BACK 2" TO 3" FROM TRUNK OF TREE

- 2. INSTALL SPECIFIED MULCH TO DRIP LINE OF TREE WHERE PLANTED IN LAWN AREAS. MULCH TO BE 2" DEEP IN LAWN AREAS.
- 3. DO NOT PROVIDE WATER BASIN IN IRRIGATED LAWN AREAS.

# **EVERGREEN TREE PLANTING**


SCALE: 1/4" = 1'-0"

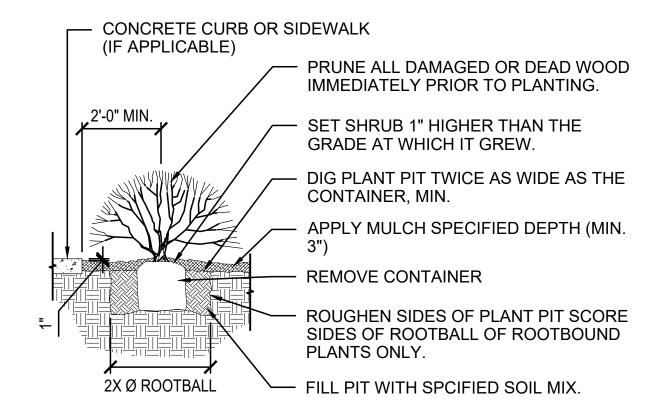

- ANY BROKEN OR CRUMBLING ROOTBALLS WILL BE REJECTED.
- REMOVING THE CONTAINERS WILL NOT BE AN EXCUSE FOR DAMAGED
- 3. HOLD GRADE 1" BELOW EDGE OF WALK OR CURB

SHRUB PLANTING


SCALE: 1/4" = 1'-0"

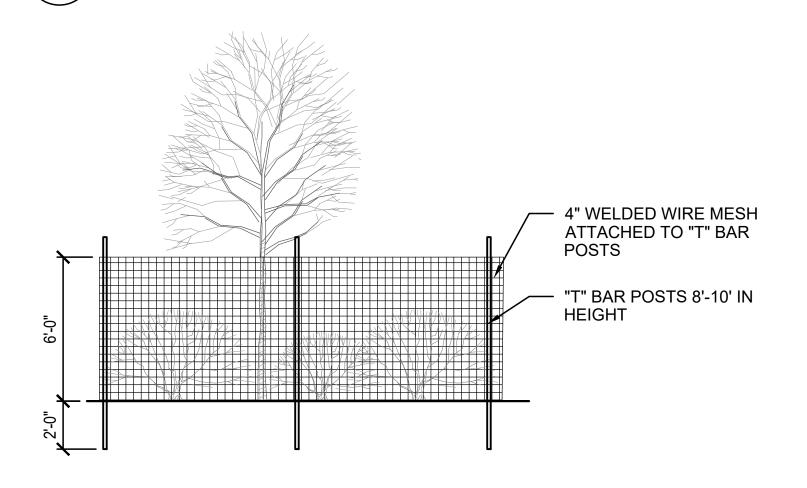

- FINAL DESIGN AND LOCATION TO BE COORDINATED AND APPROVED IN FIELD BY LANDSCAPE ARCHITECT
- 2. "T" BAR POSTS TO BE SPACED APPROPRIATELY TO ENSURE INTEGRITY
- 3. ALL TREES 2" DIAMETER OR LARGER MAY BE STAKED FOR ONE YEAR

WILDLIFE PROTECTION FENCING


SCALE: 1/4" = 1'-0"

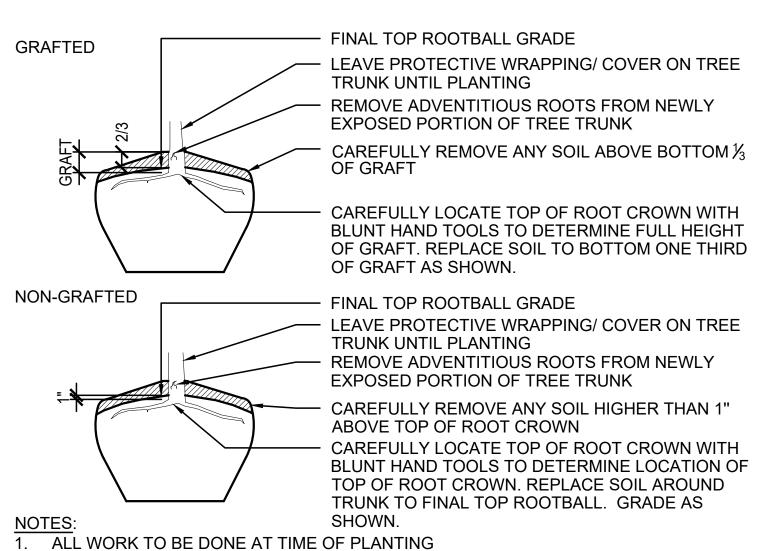

- 2. PEEL BACK ONLY TOP OF BURLAP REQUIRED TO PERFORM WORK. REPLACE BURLAP BEFORE MOVING TREE INTO PLANTING PIT. DO NOT REMOVE WIRE BASKET UNTIL INSIDE PLANTING PIT.
- 3. MEASURE NEW HEIGHT OF ROOTBALL AND DIG PLANTING PIT SO FINAL TOP ROOTBALL GRADE IS 3" ABOVE FINAL GRADE SURROUNDING BALL.



SCALE: 1/2" = 1'-0"

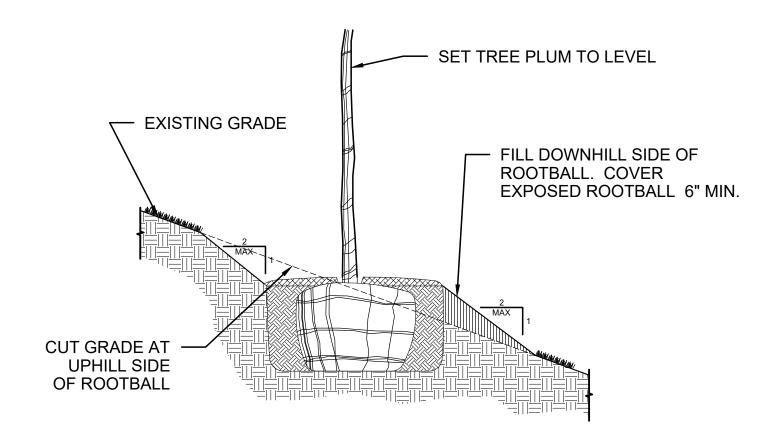

- 1. REFER TO VARIOUS SPECIFIC TREE INSTALLATION DETAILS FOR STAKING, GUYING, MULCHING, ETC.
- 2. THIS INSTALLATION SHALL APPLY TO ALL TREE TYPES AND SIZES PLANTED ON SLOPES LESS THAN 2:1.




SCALE: 1/4" = 1'-0"



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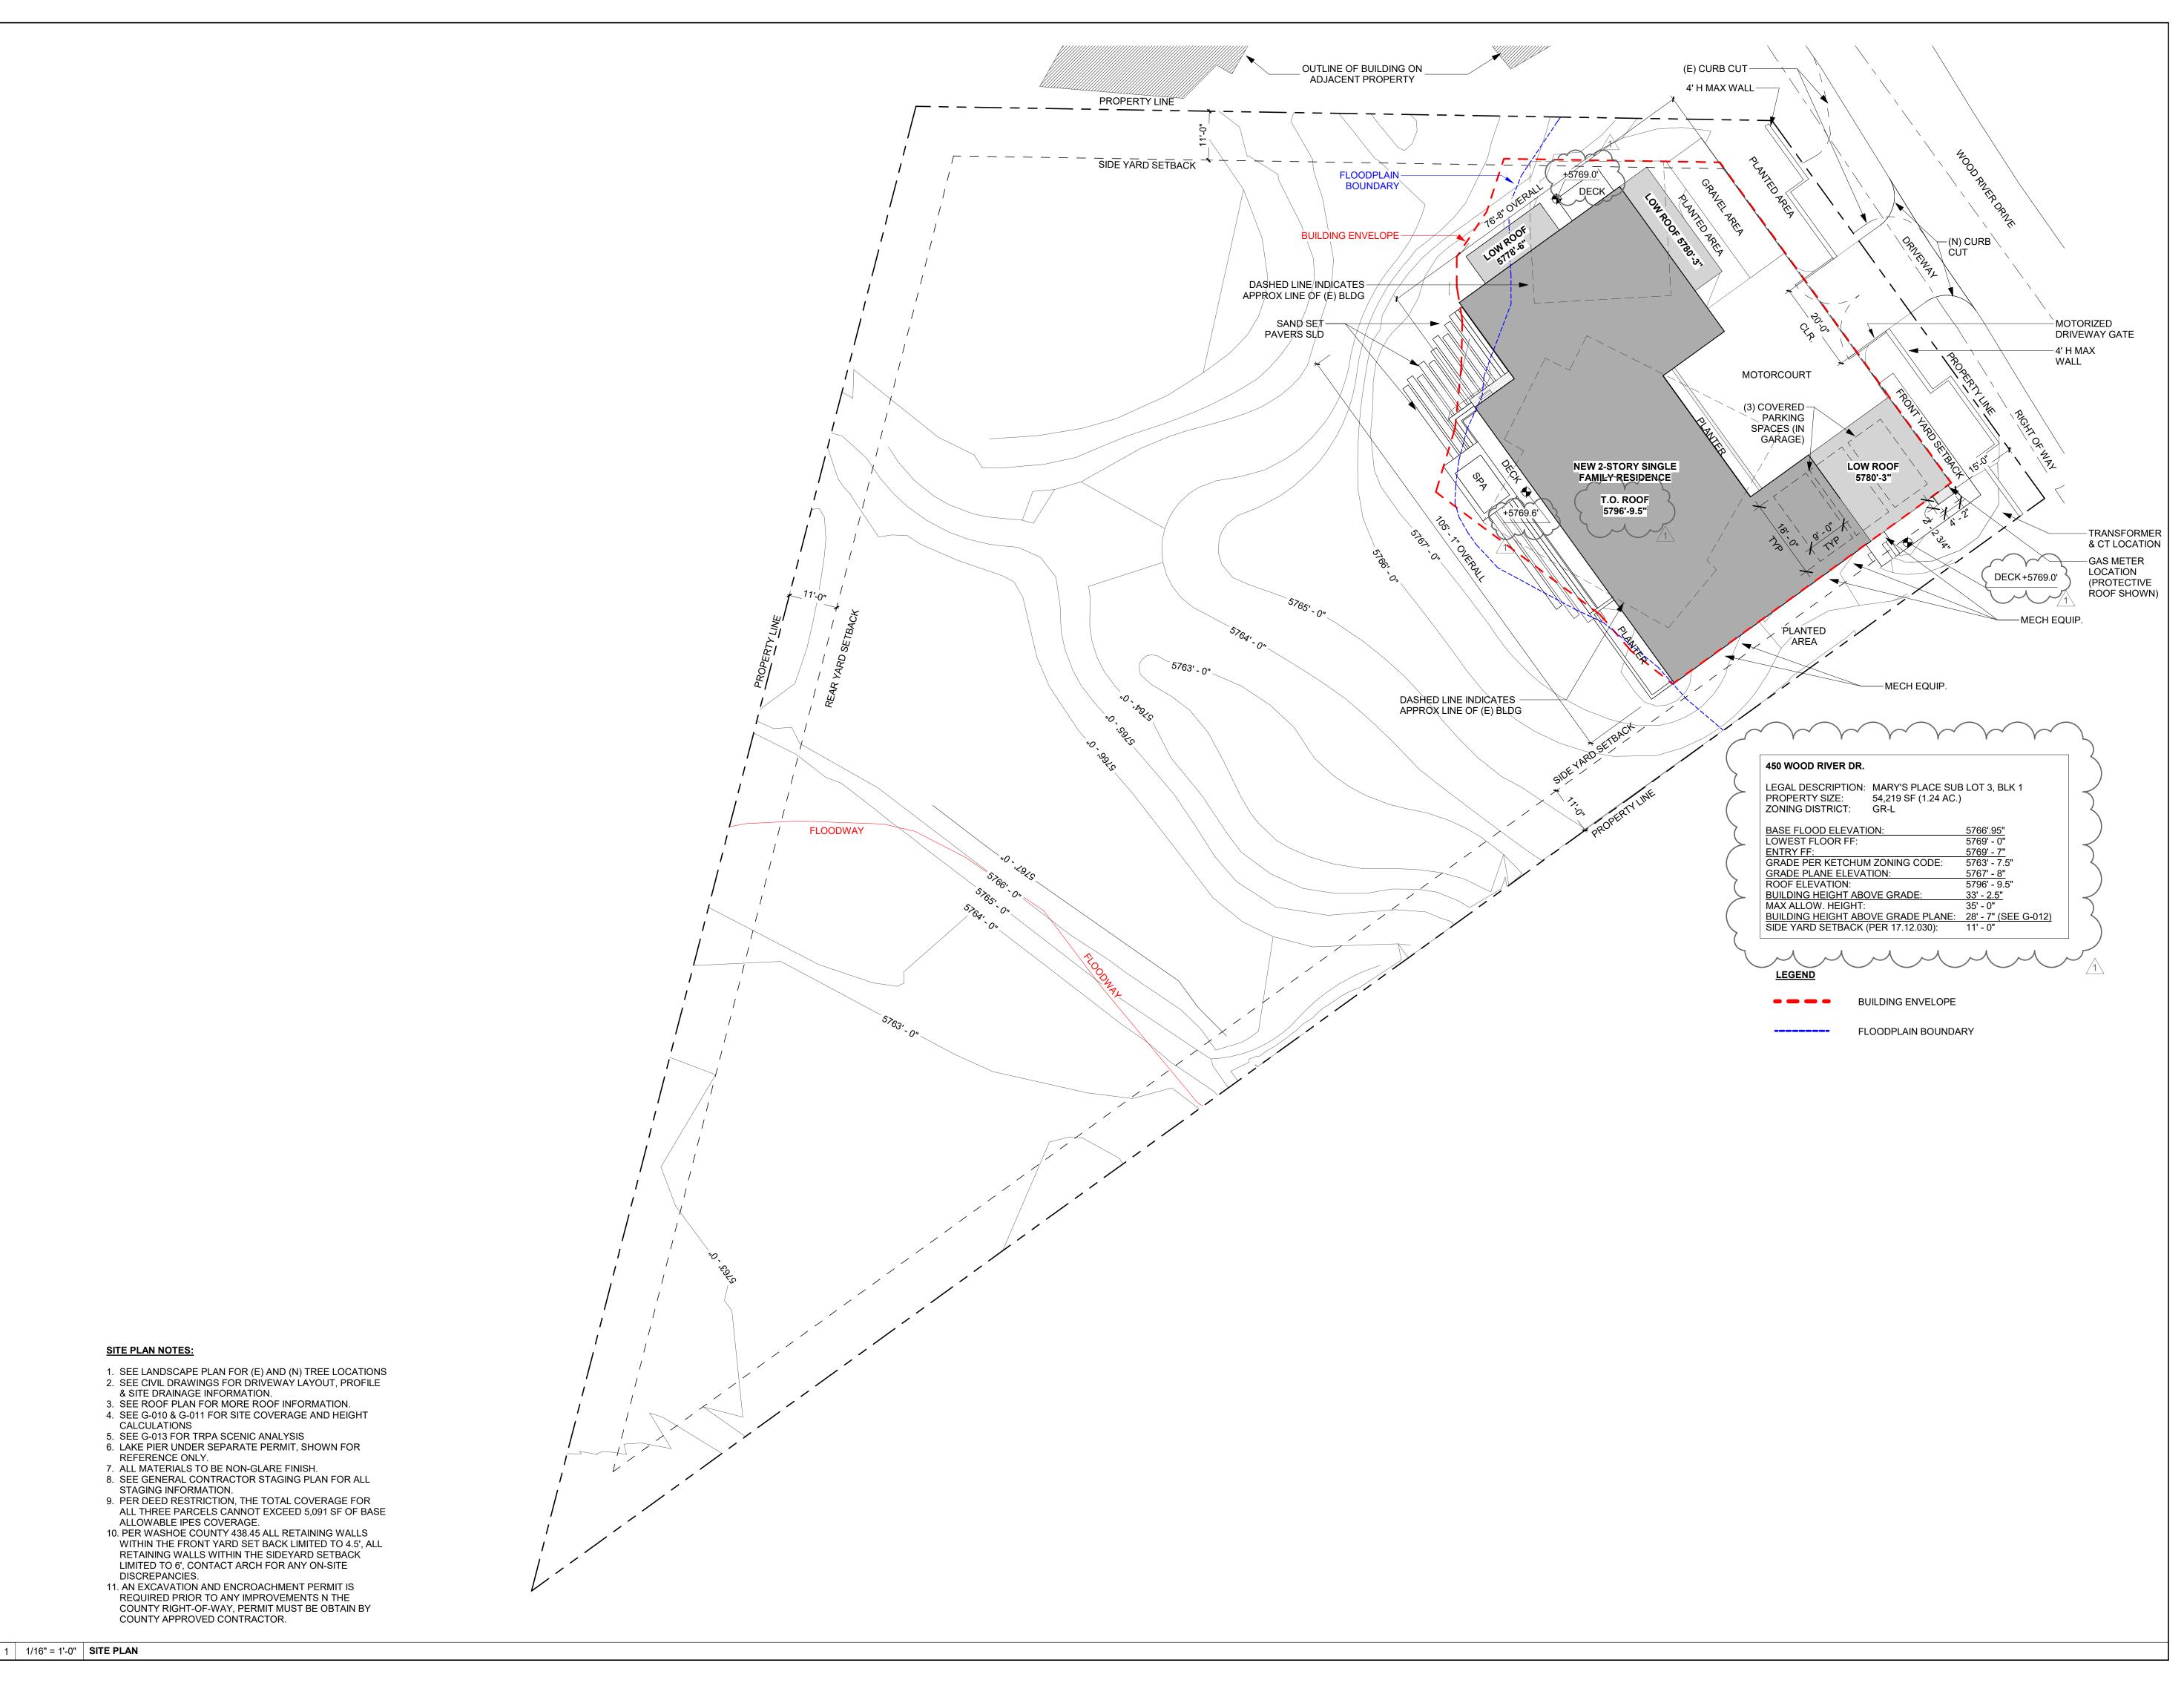
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PROJECT NUMBER: 2219



**PLANTING DETAILS** 

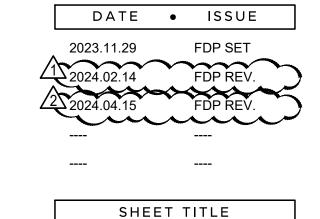SHEET 6 OF 6 L-4.01



OWNER:

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PROJECT ARCHITECT:

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STATE OF IDAHO

1 04.16.2024 FDP APP RESUBMITTAL
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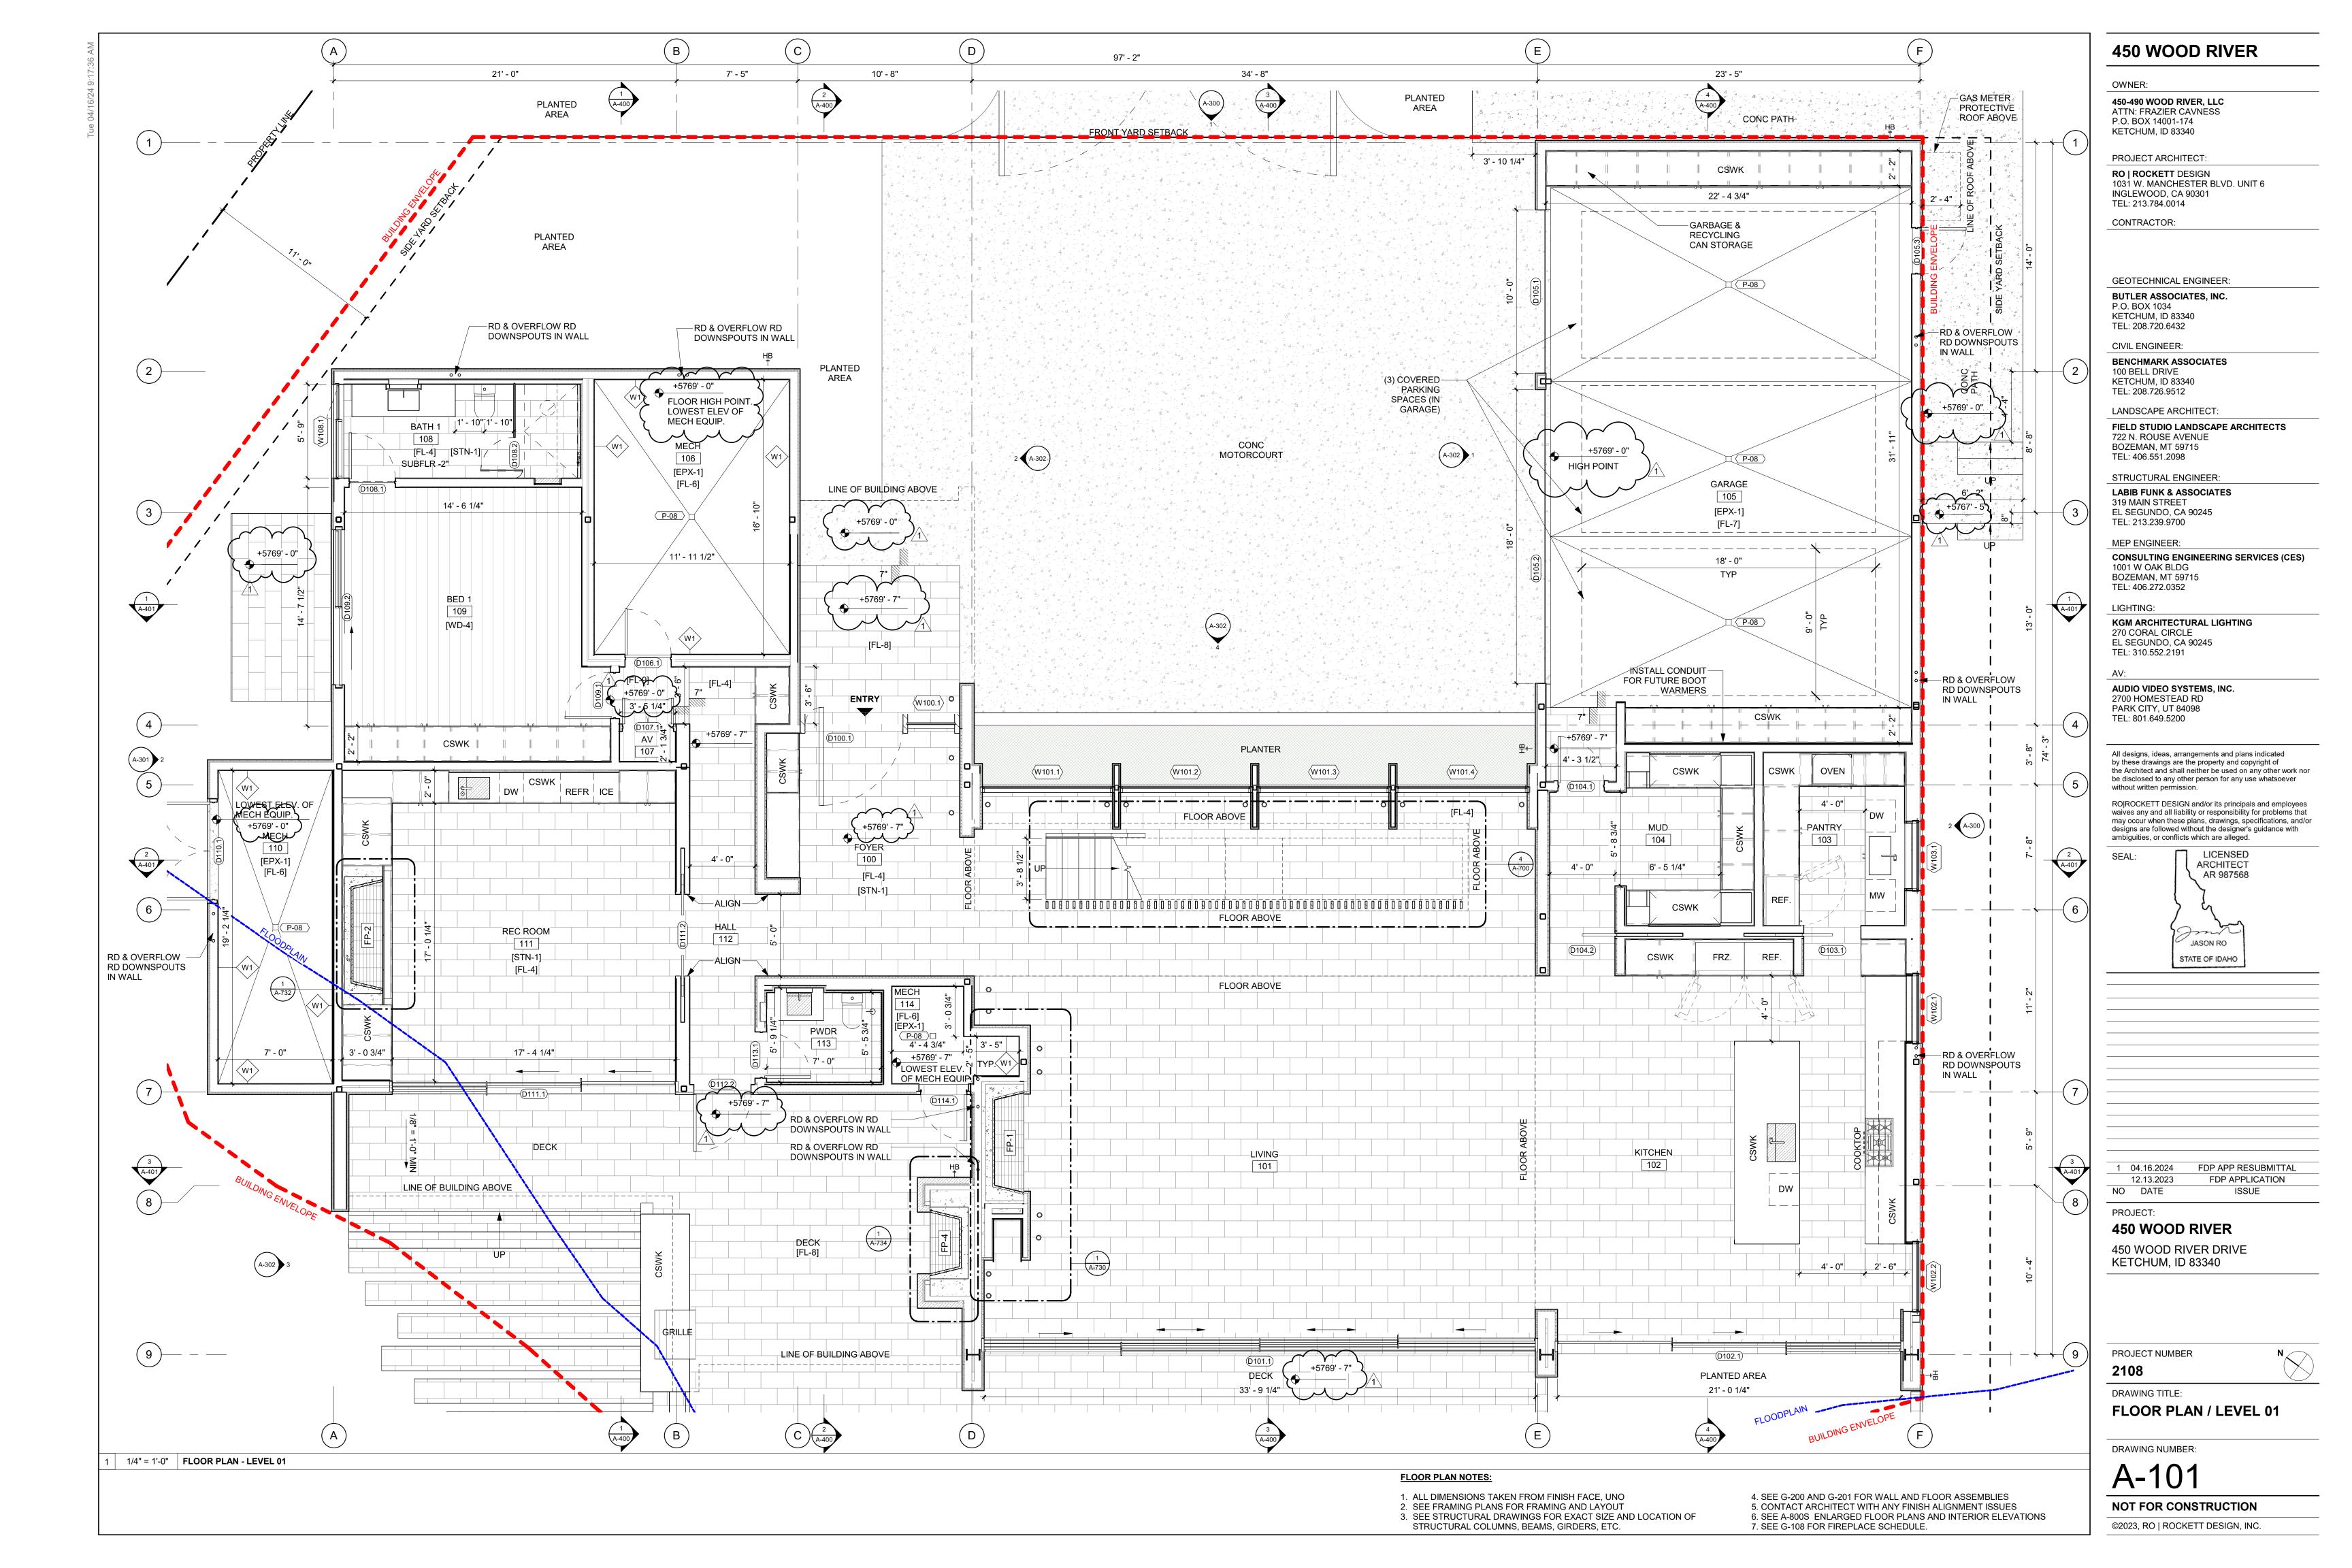
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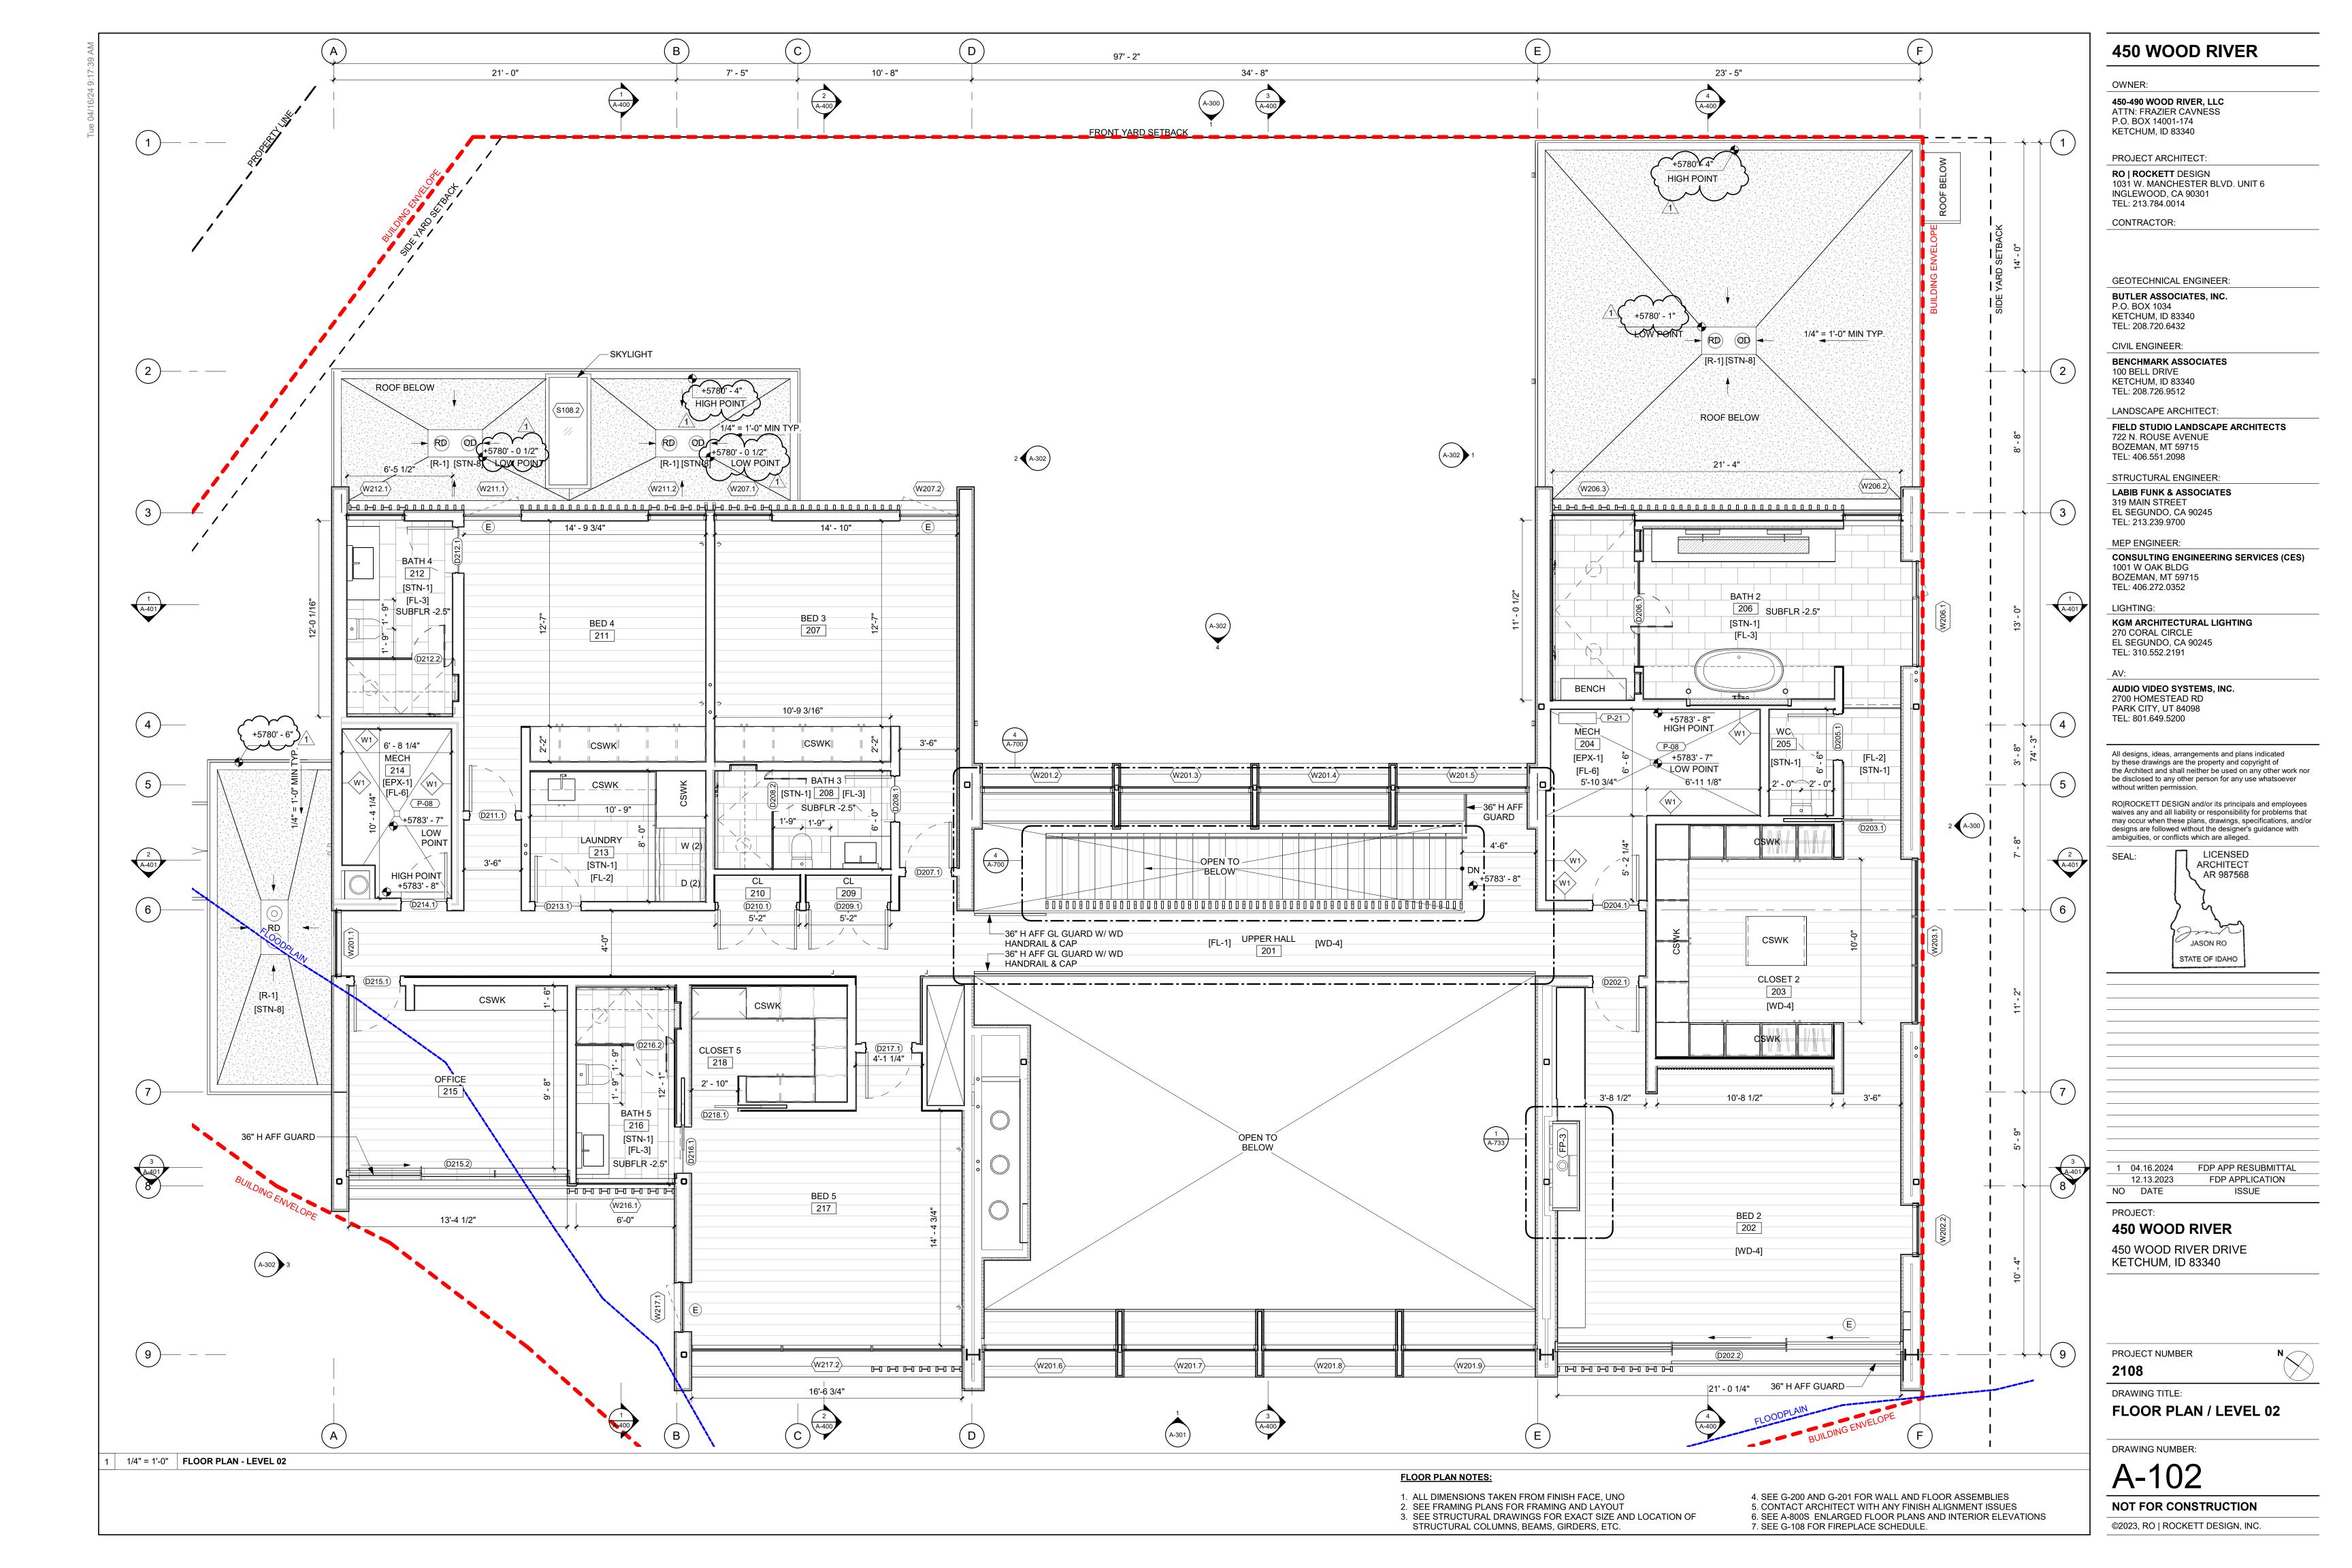
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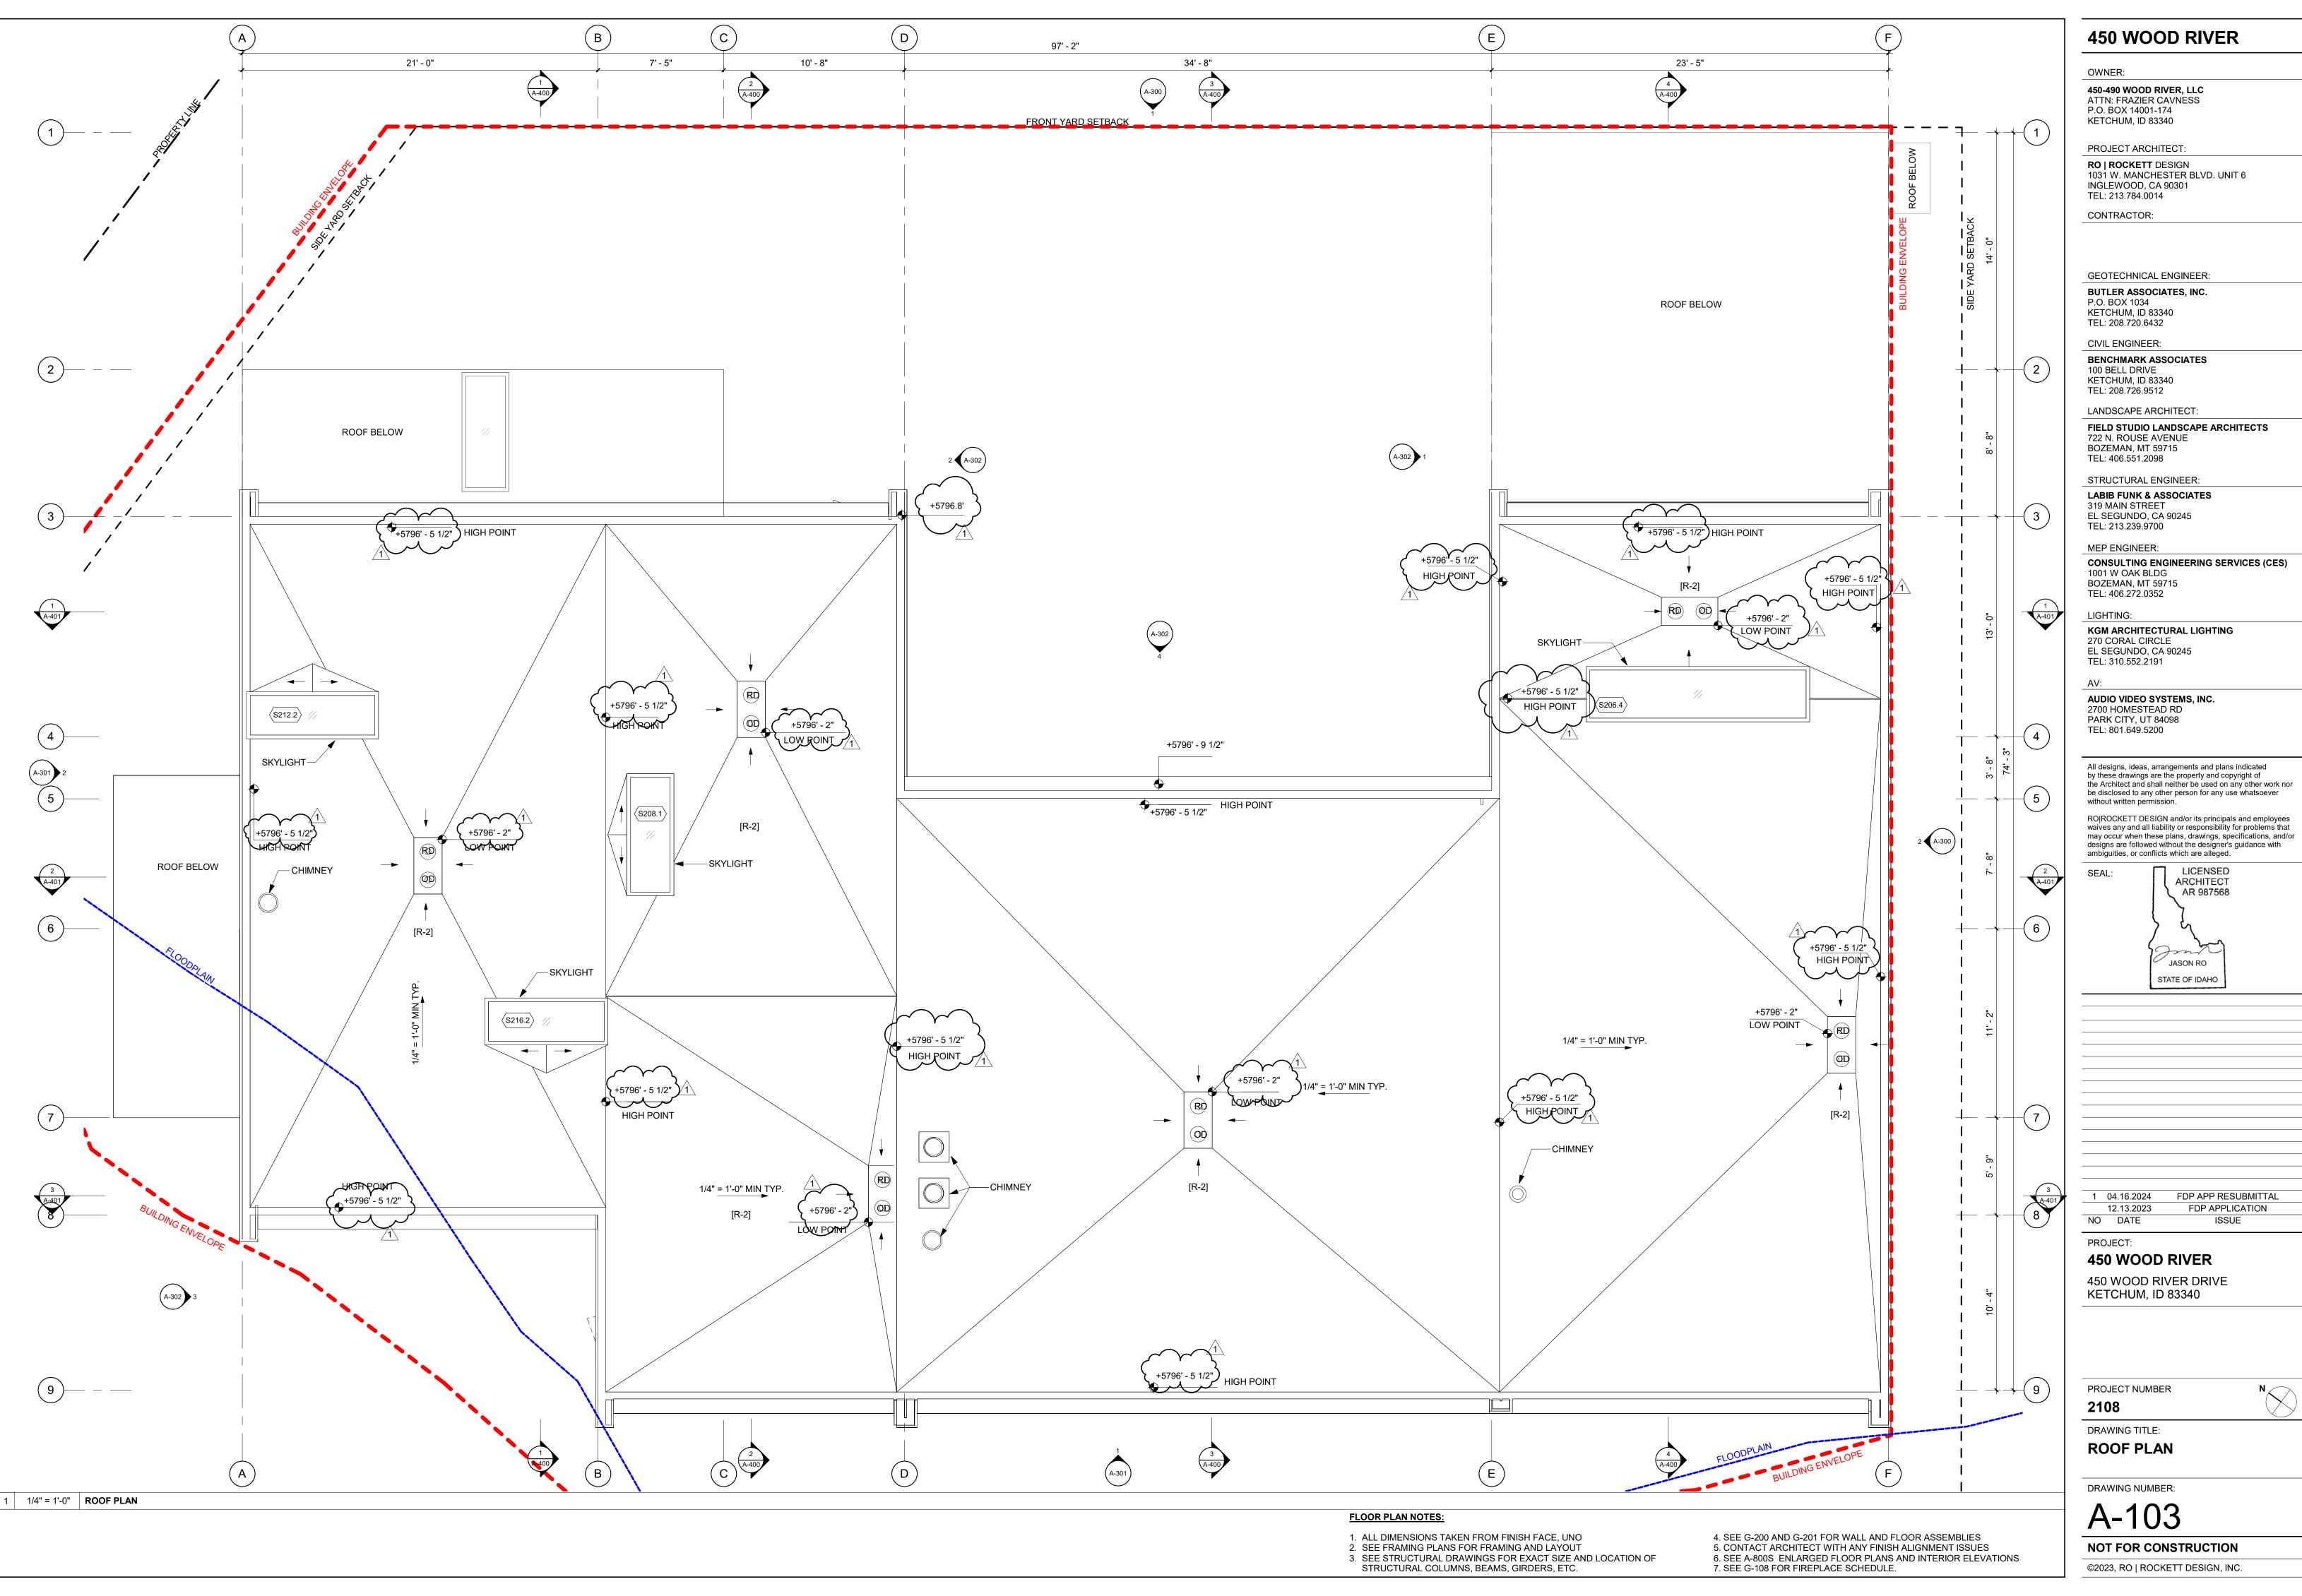
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NOT FOR CONSTRUCTION







1031 W. MANCHESTER BLVD. UNIT 6

FIELD STUDIO LANDSCAPE ARCHITECTS


CONSULTING ENGINEERING SERVICES (CES)

KGM ARCHITECTURAL LIGHTING


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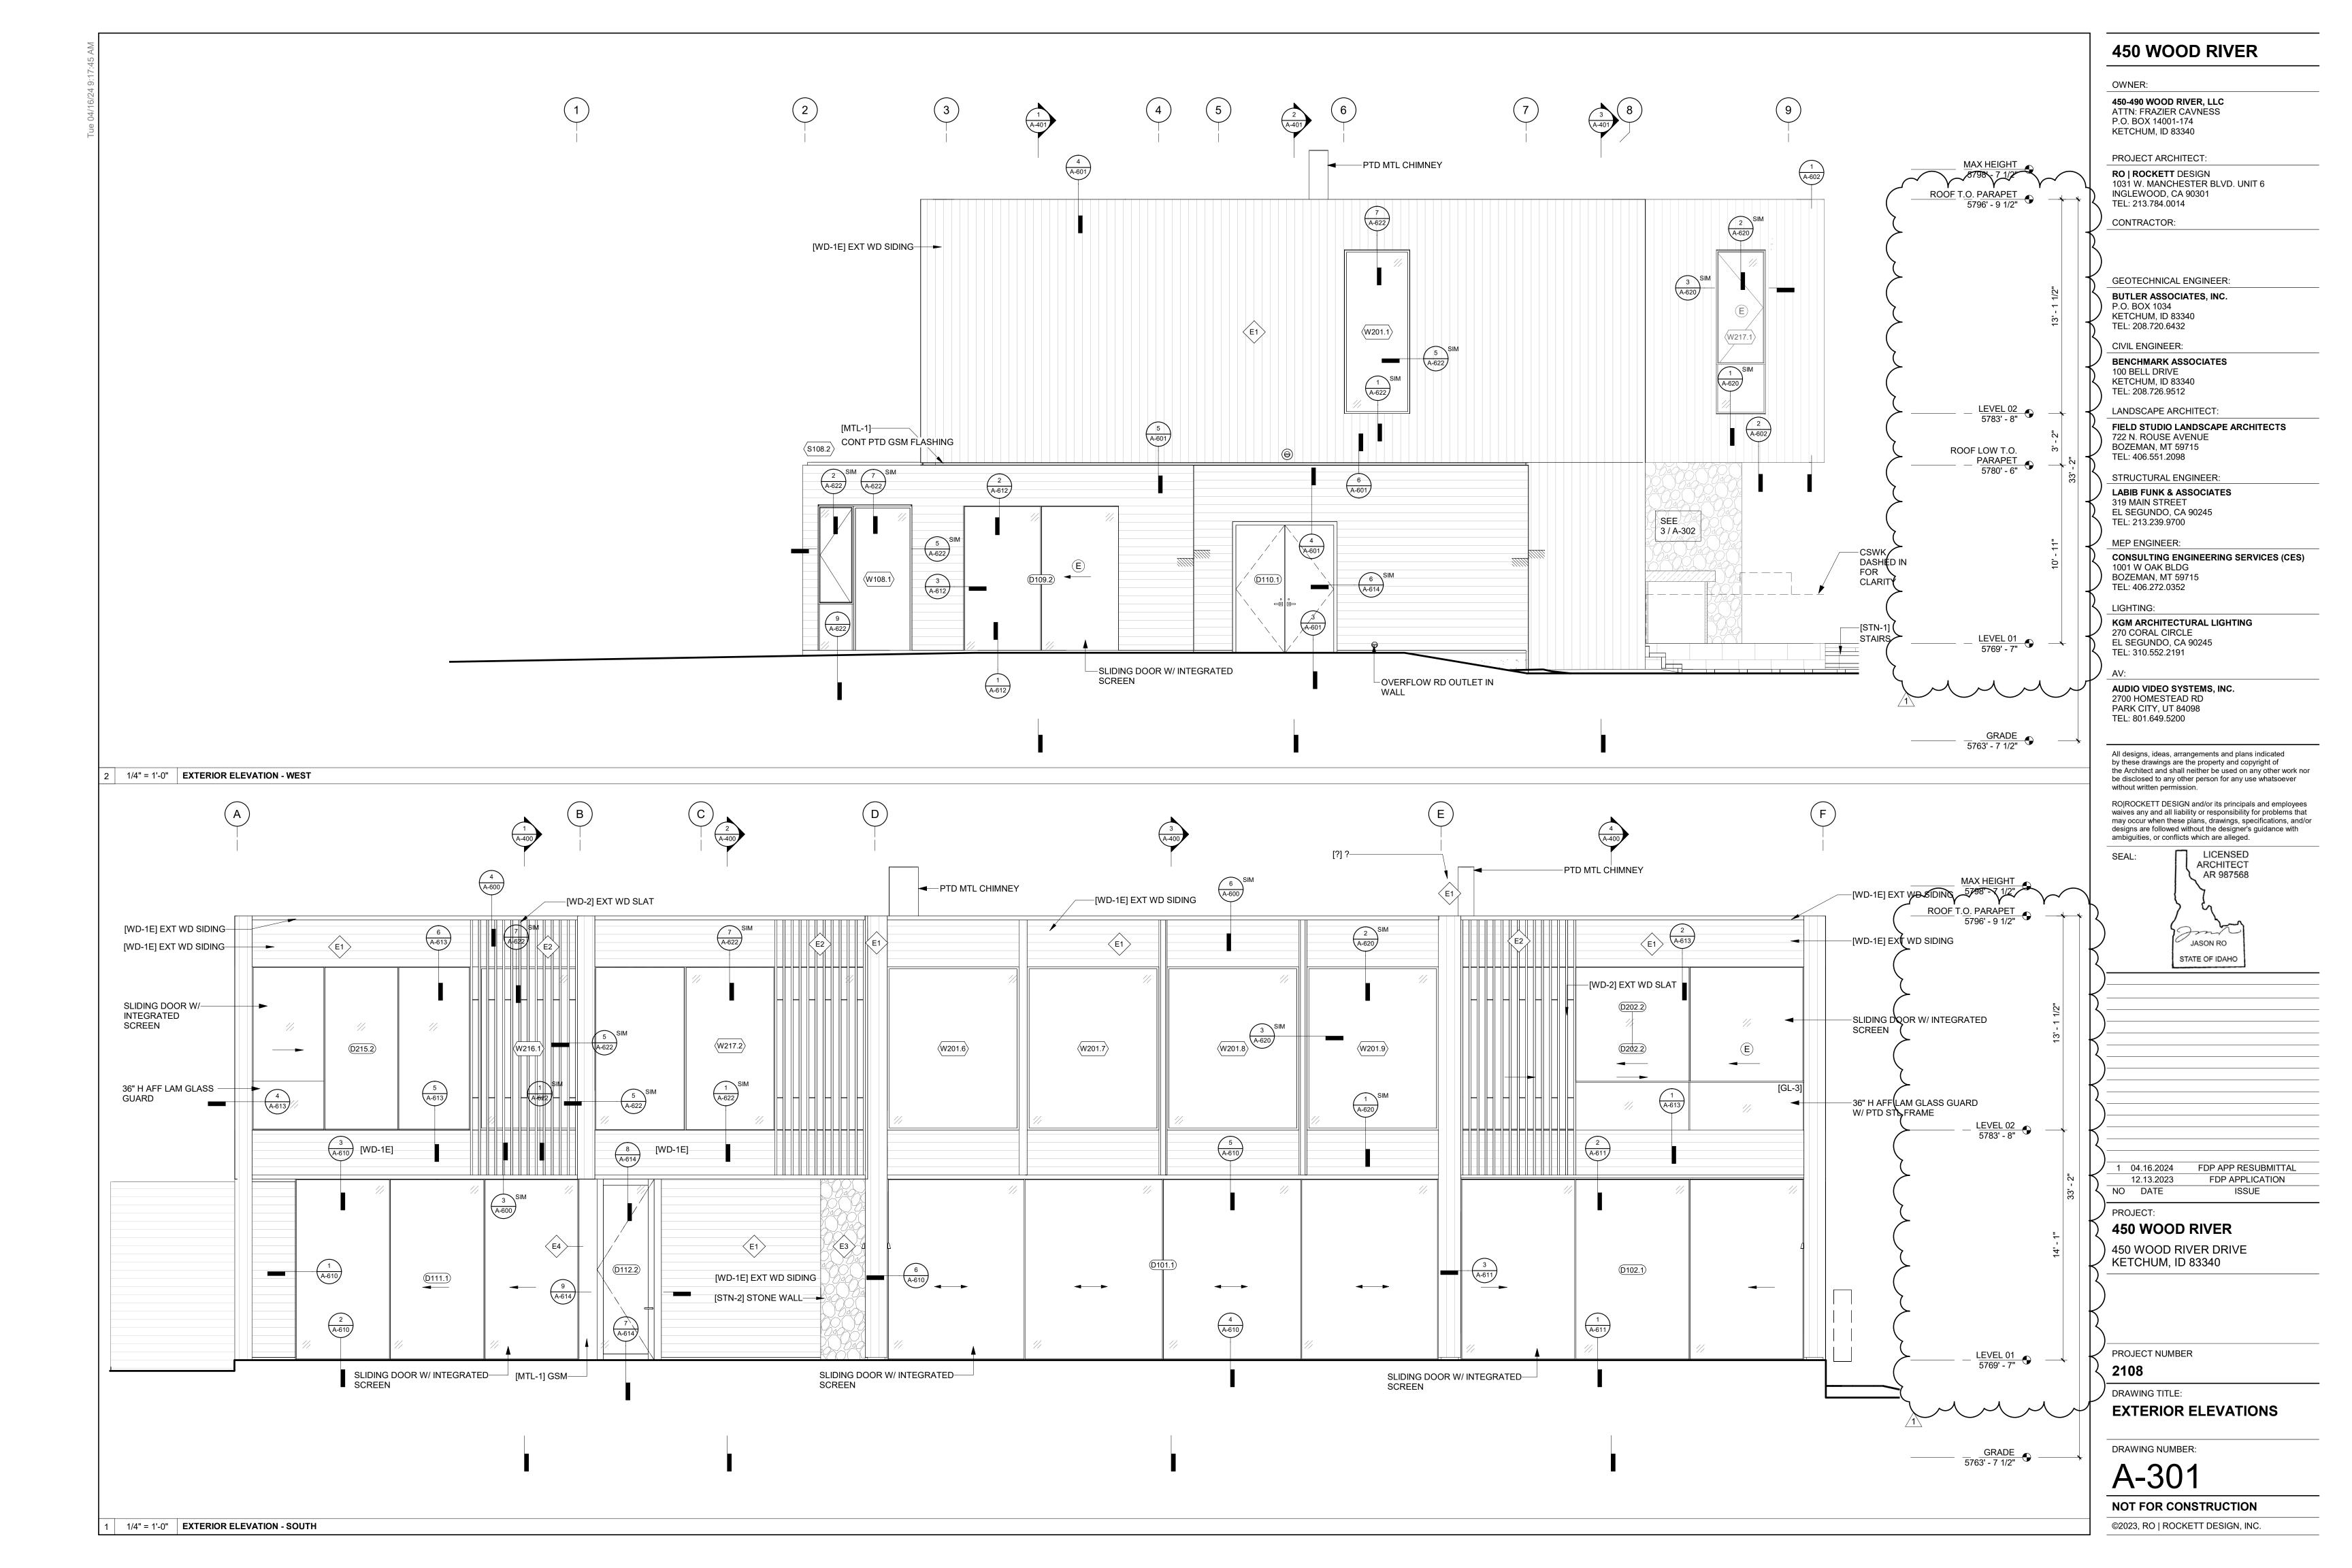
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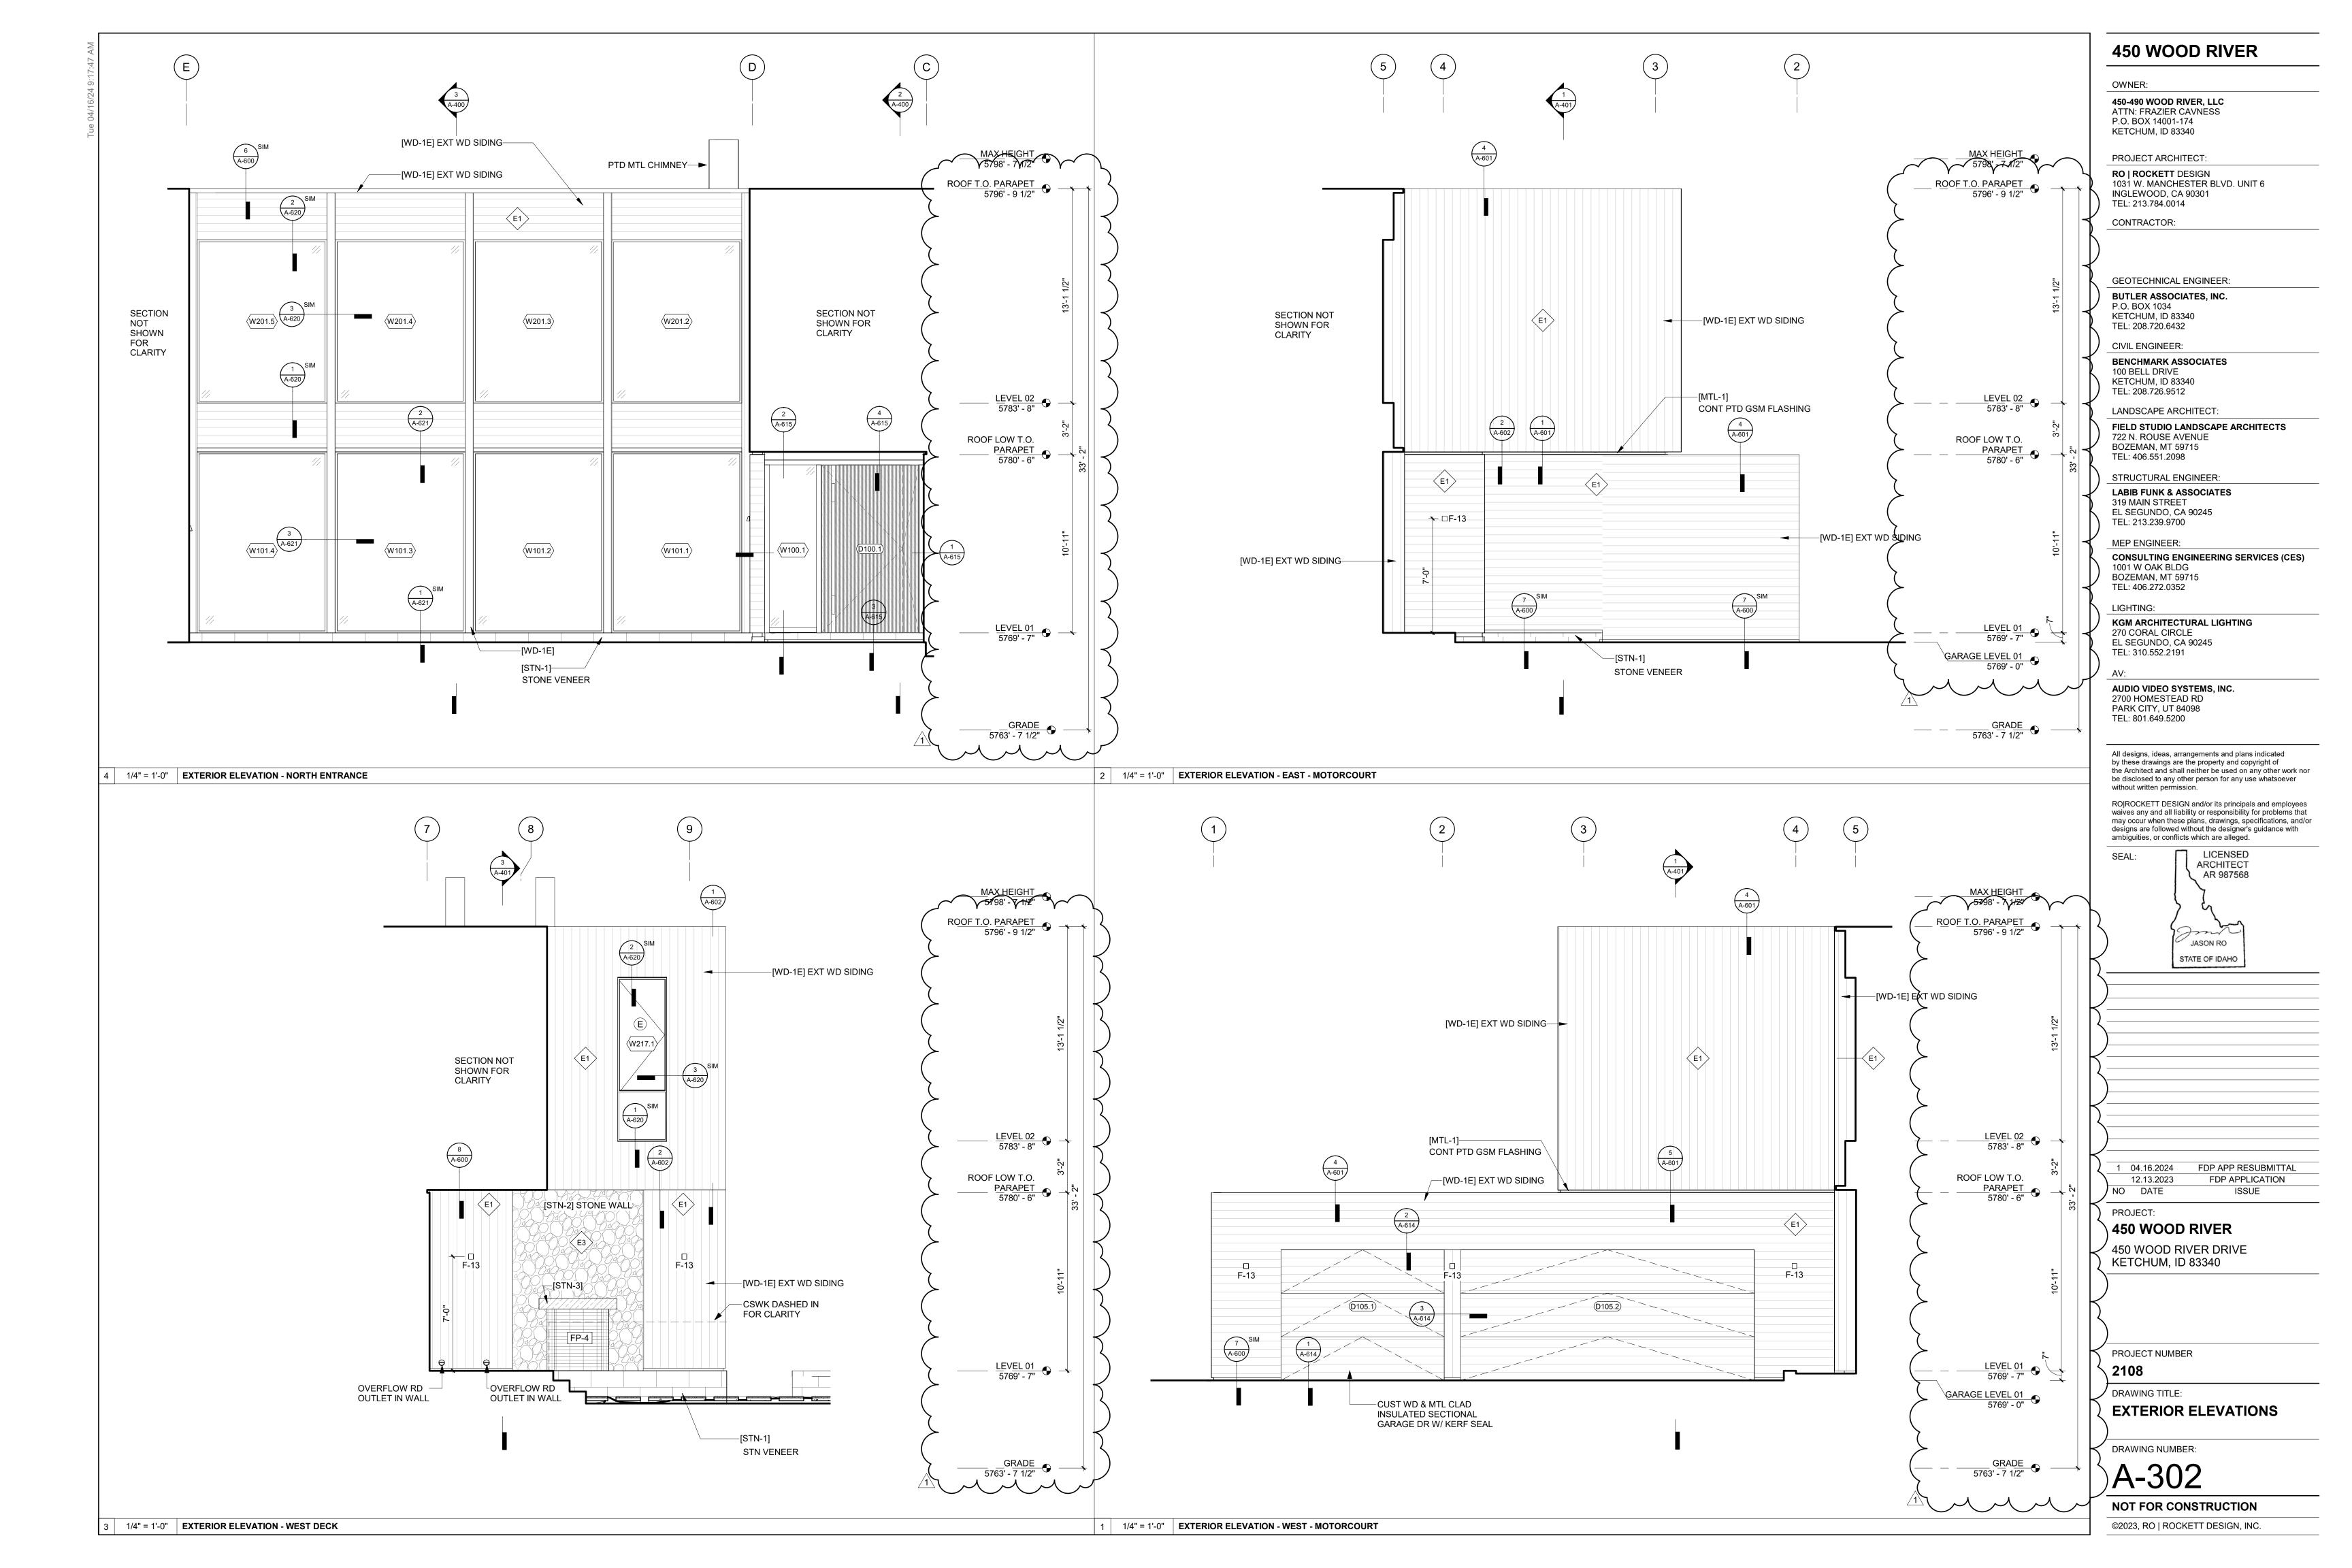
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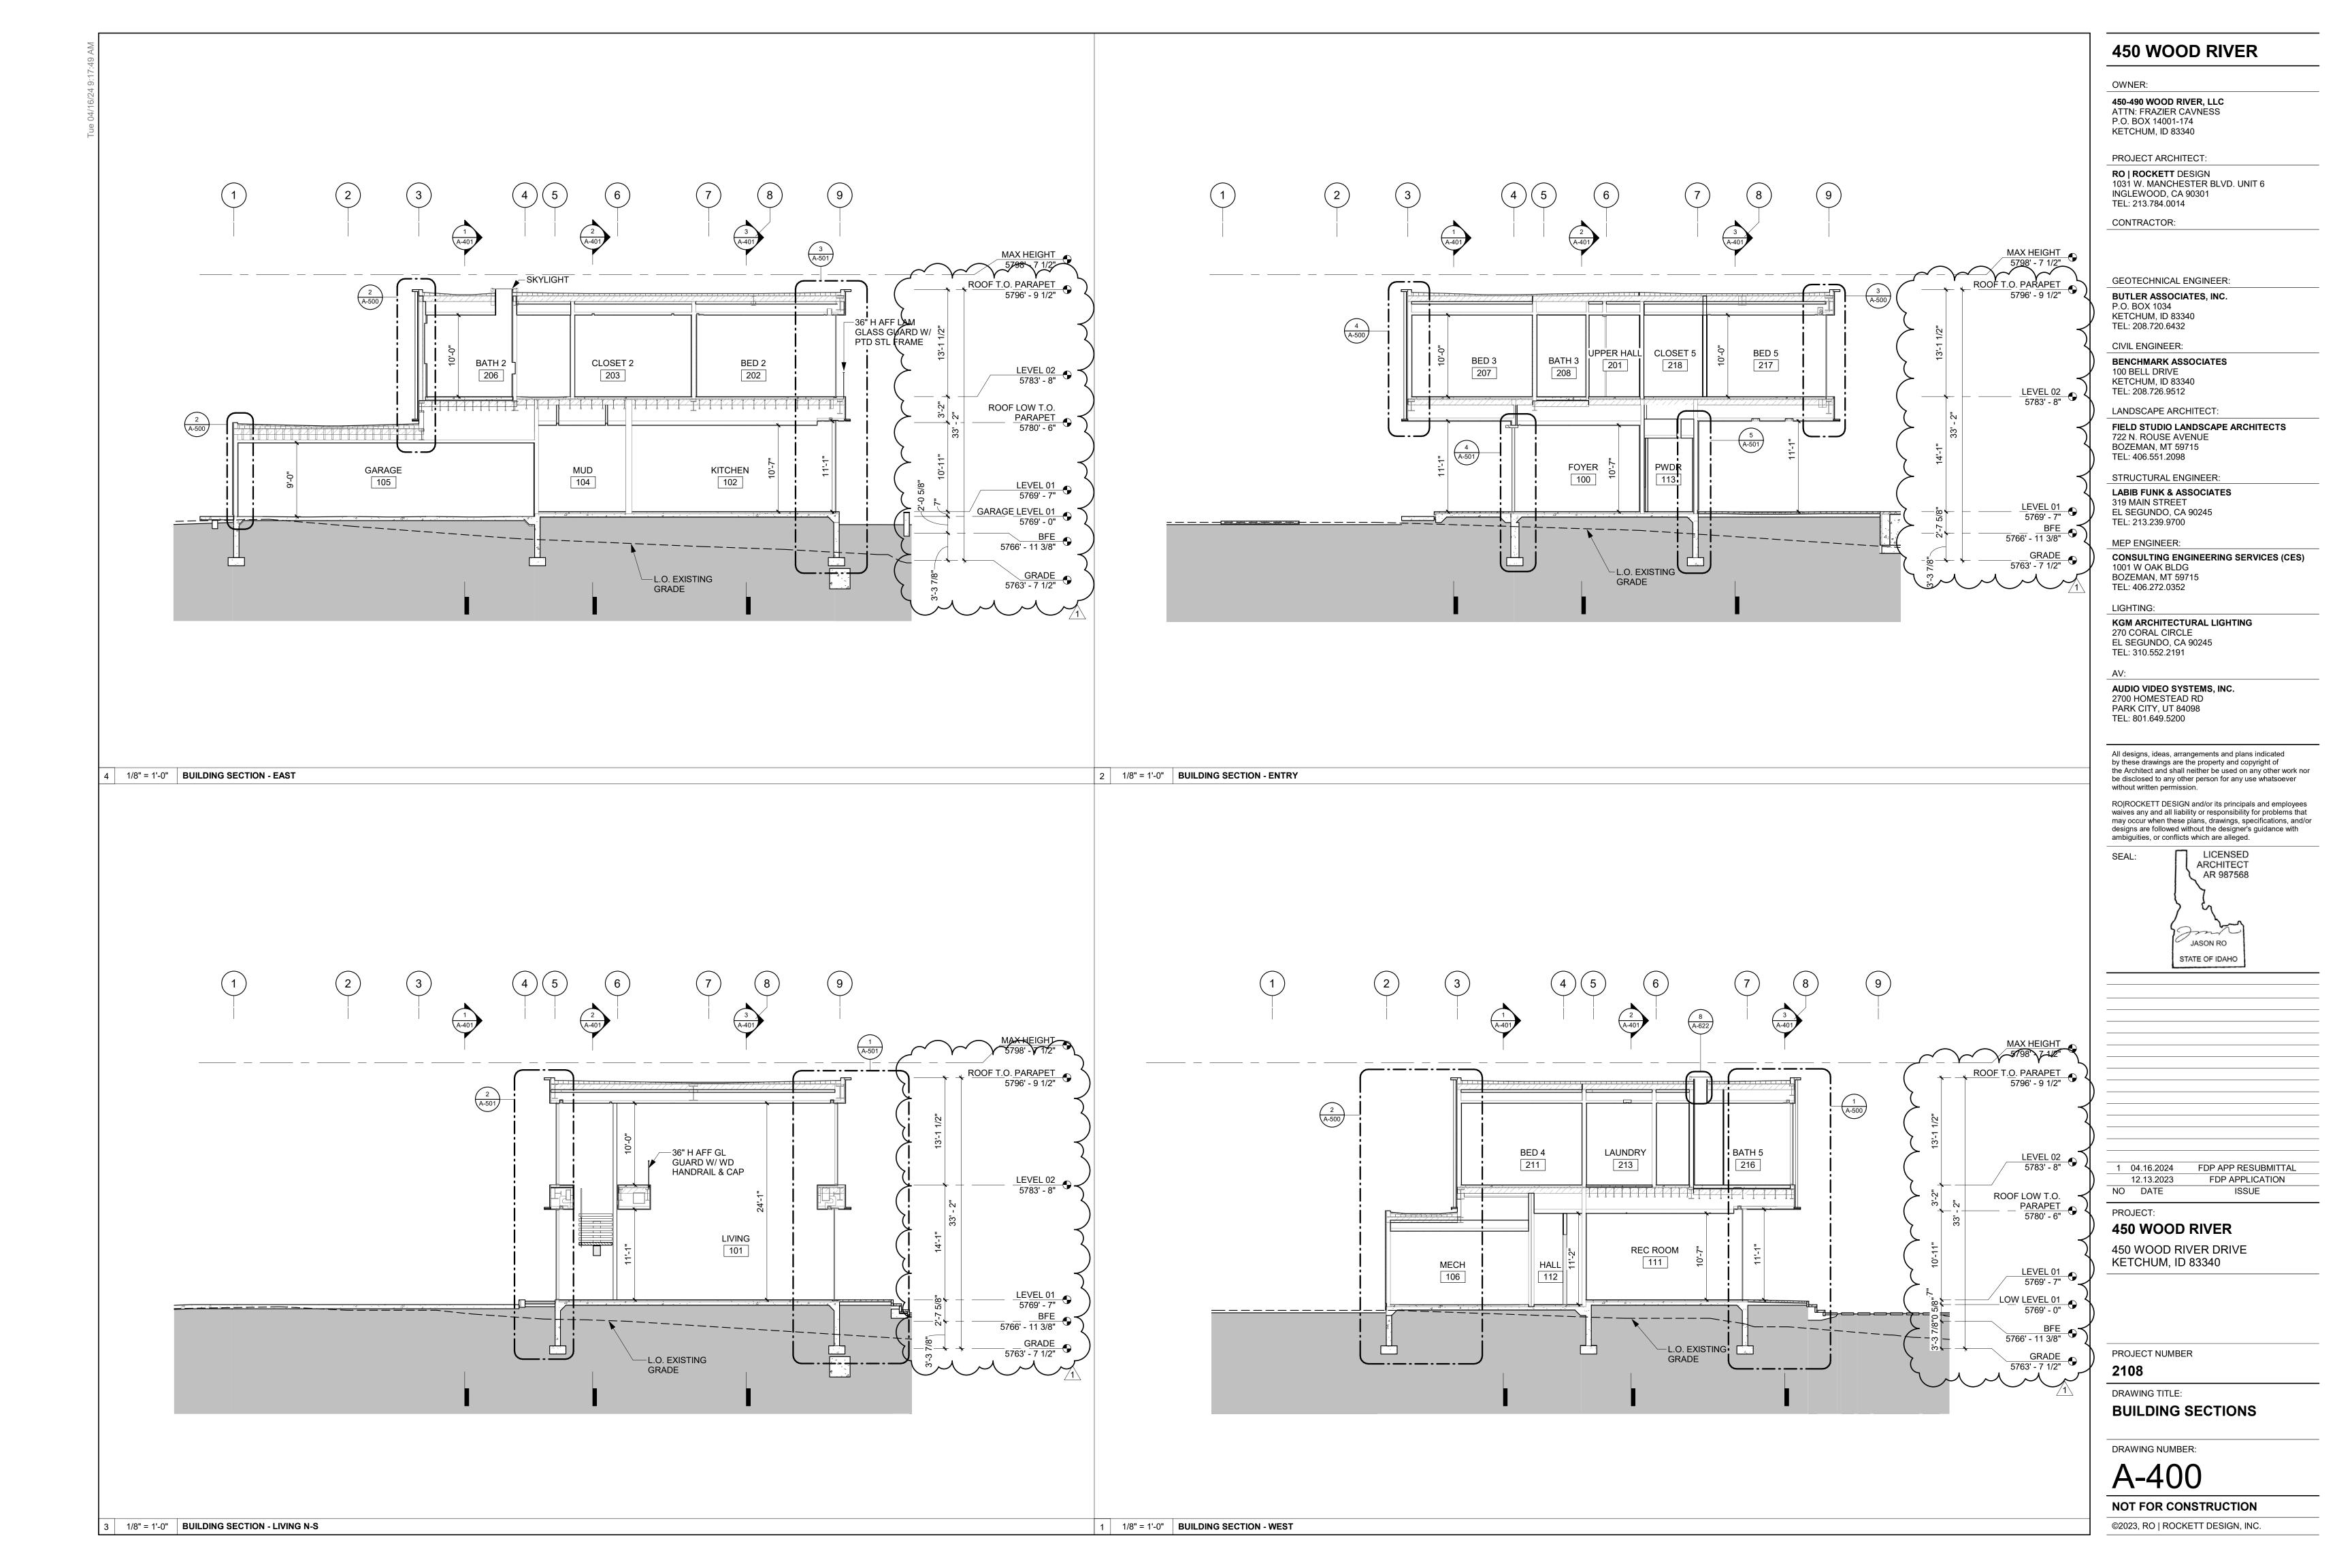



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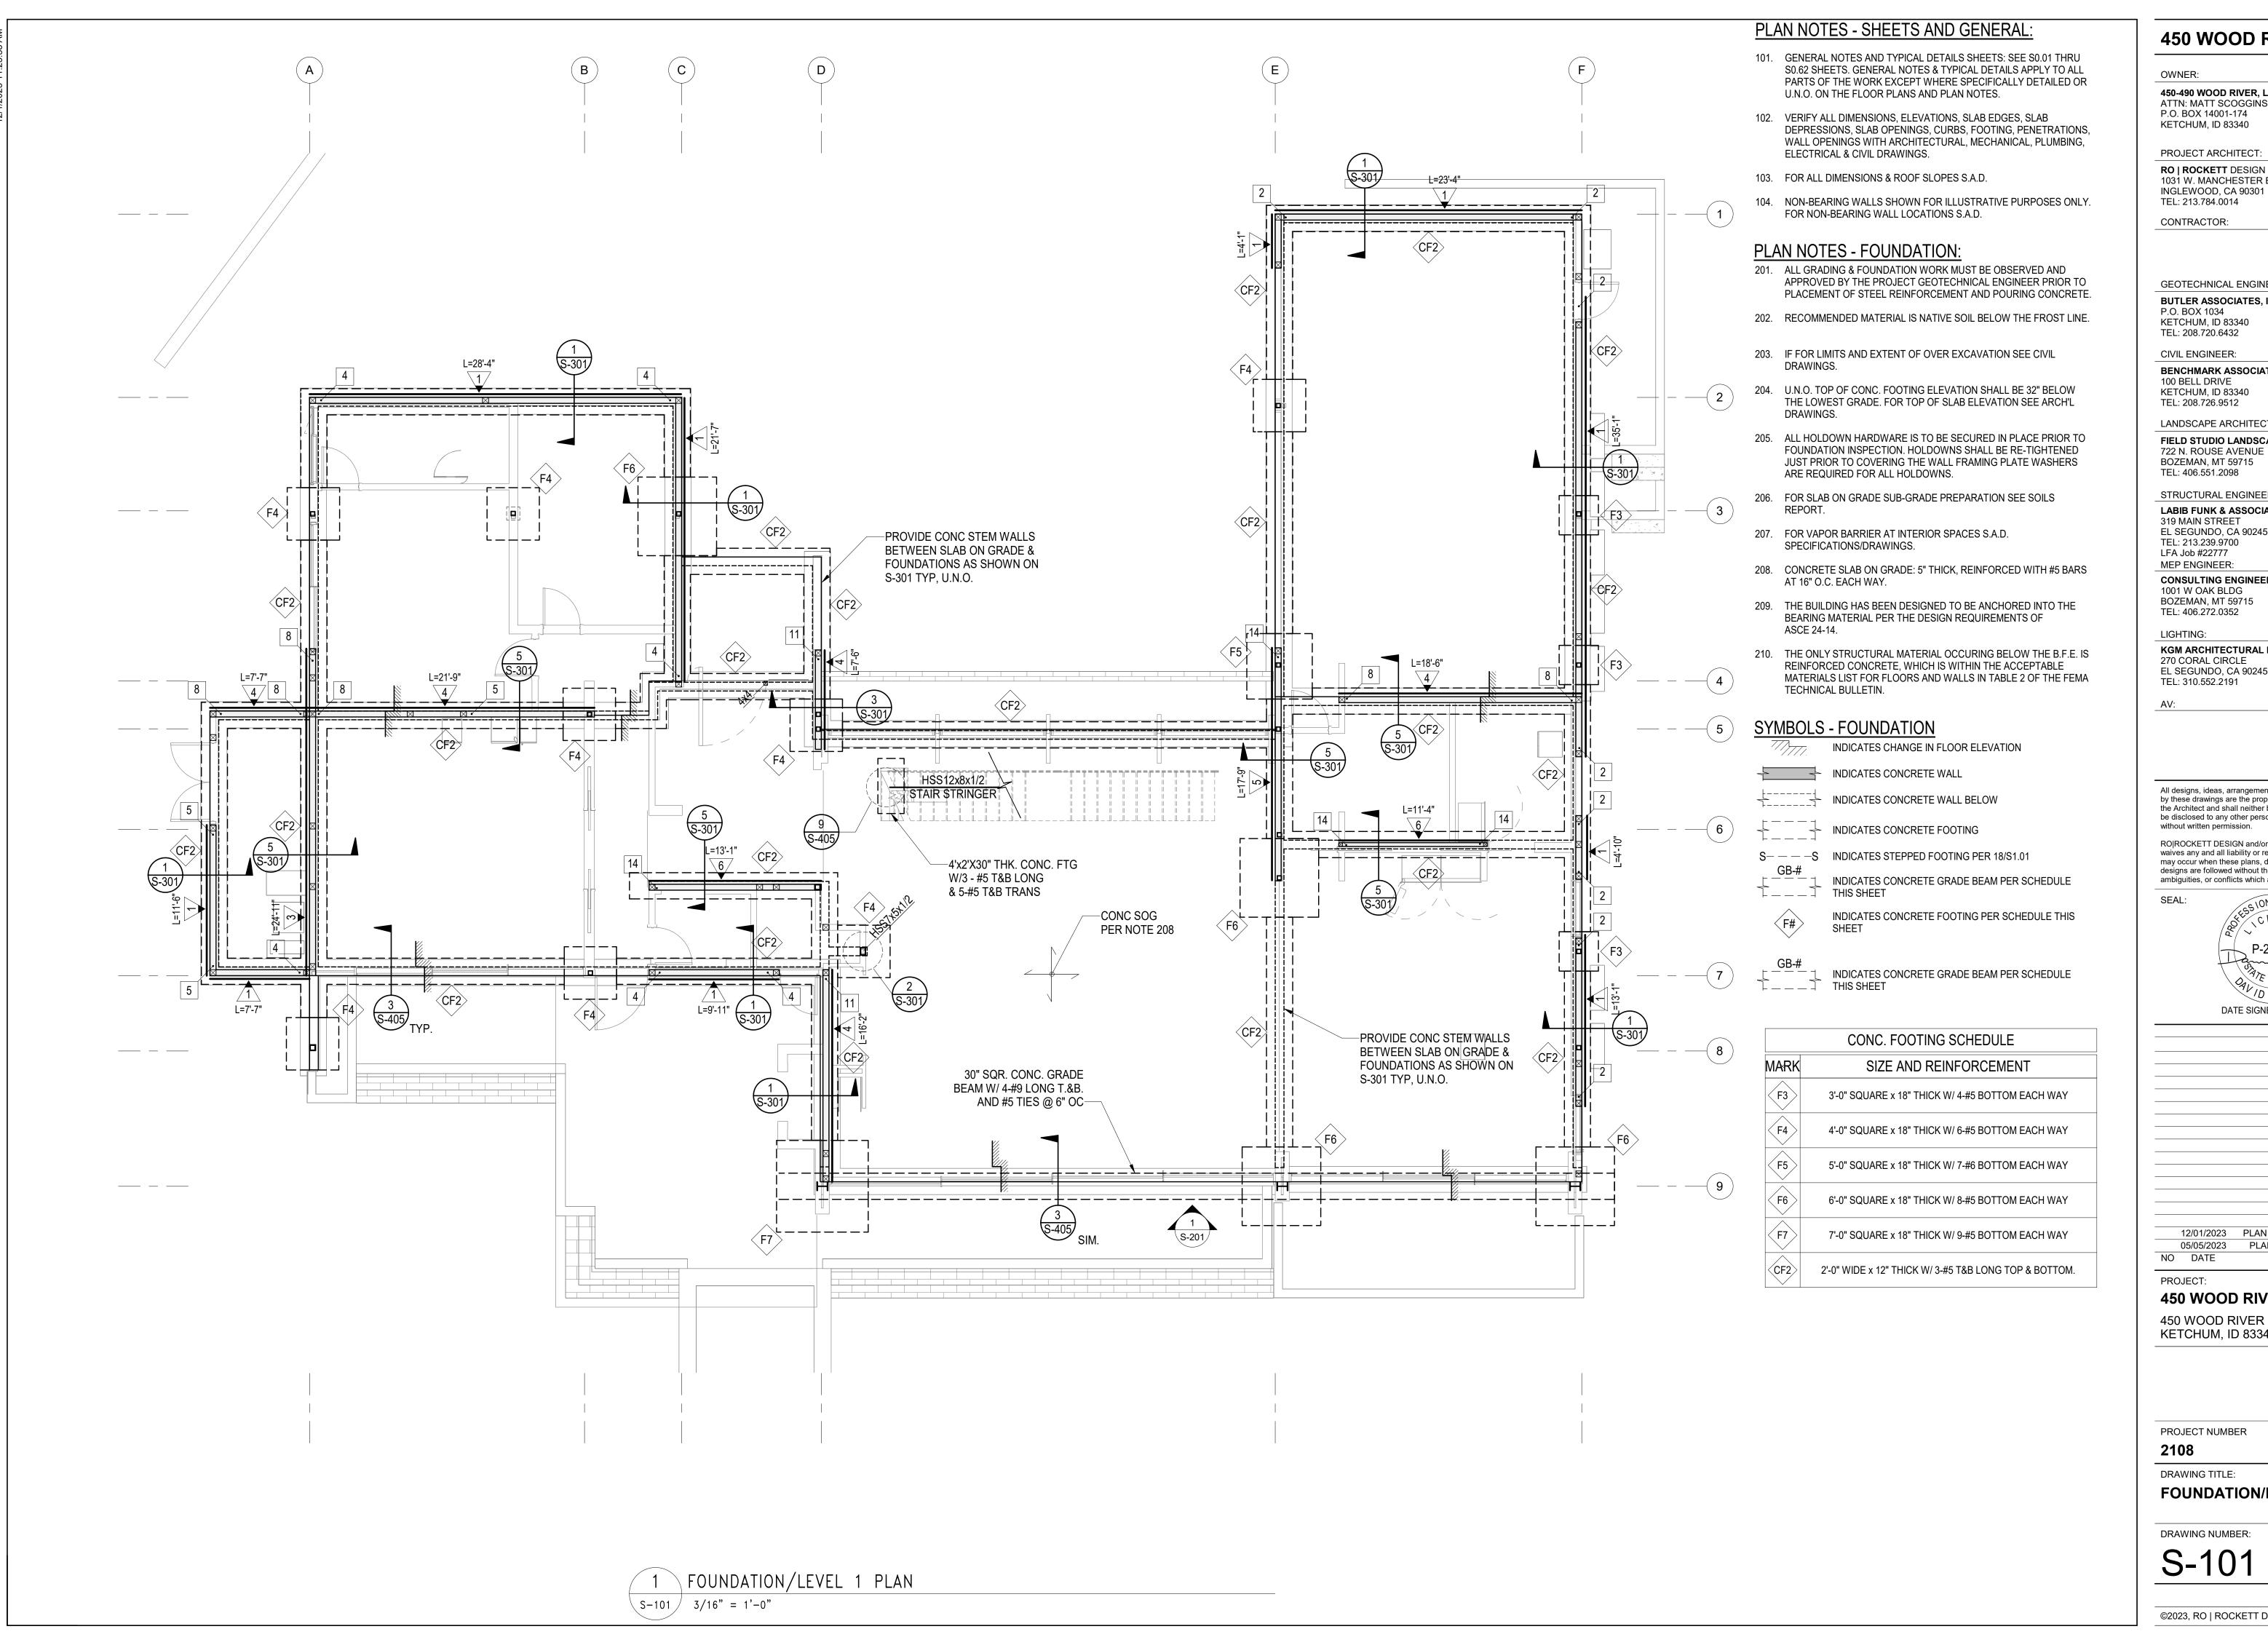




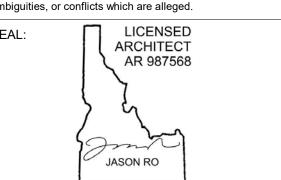



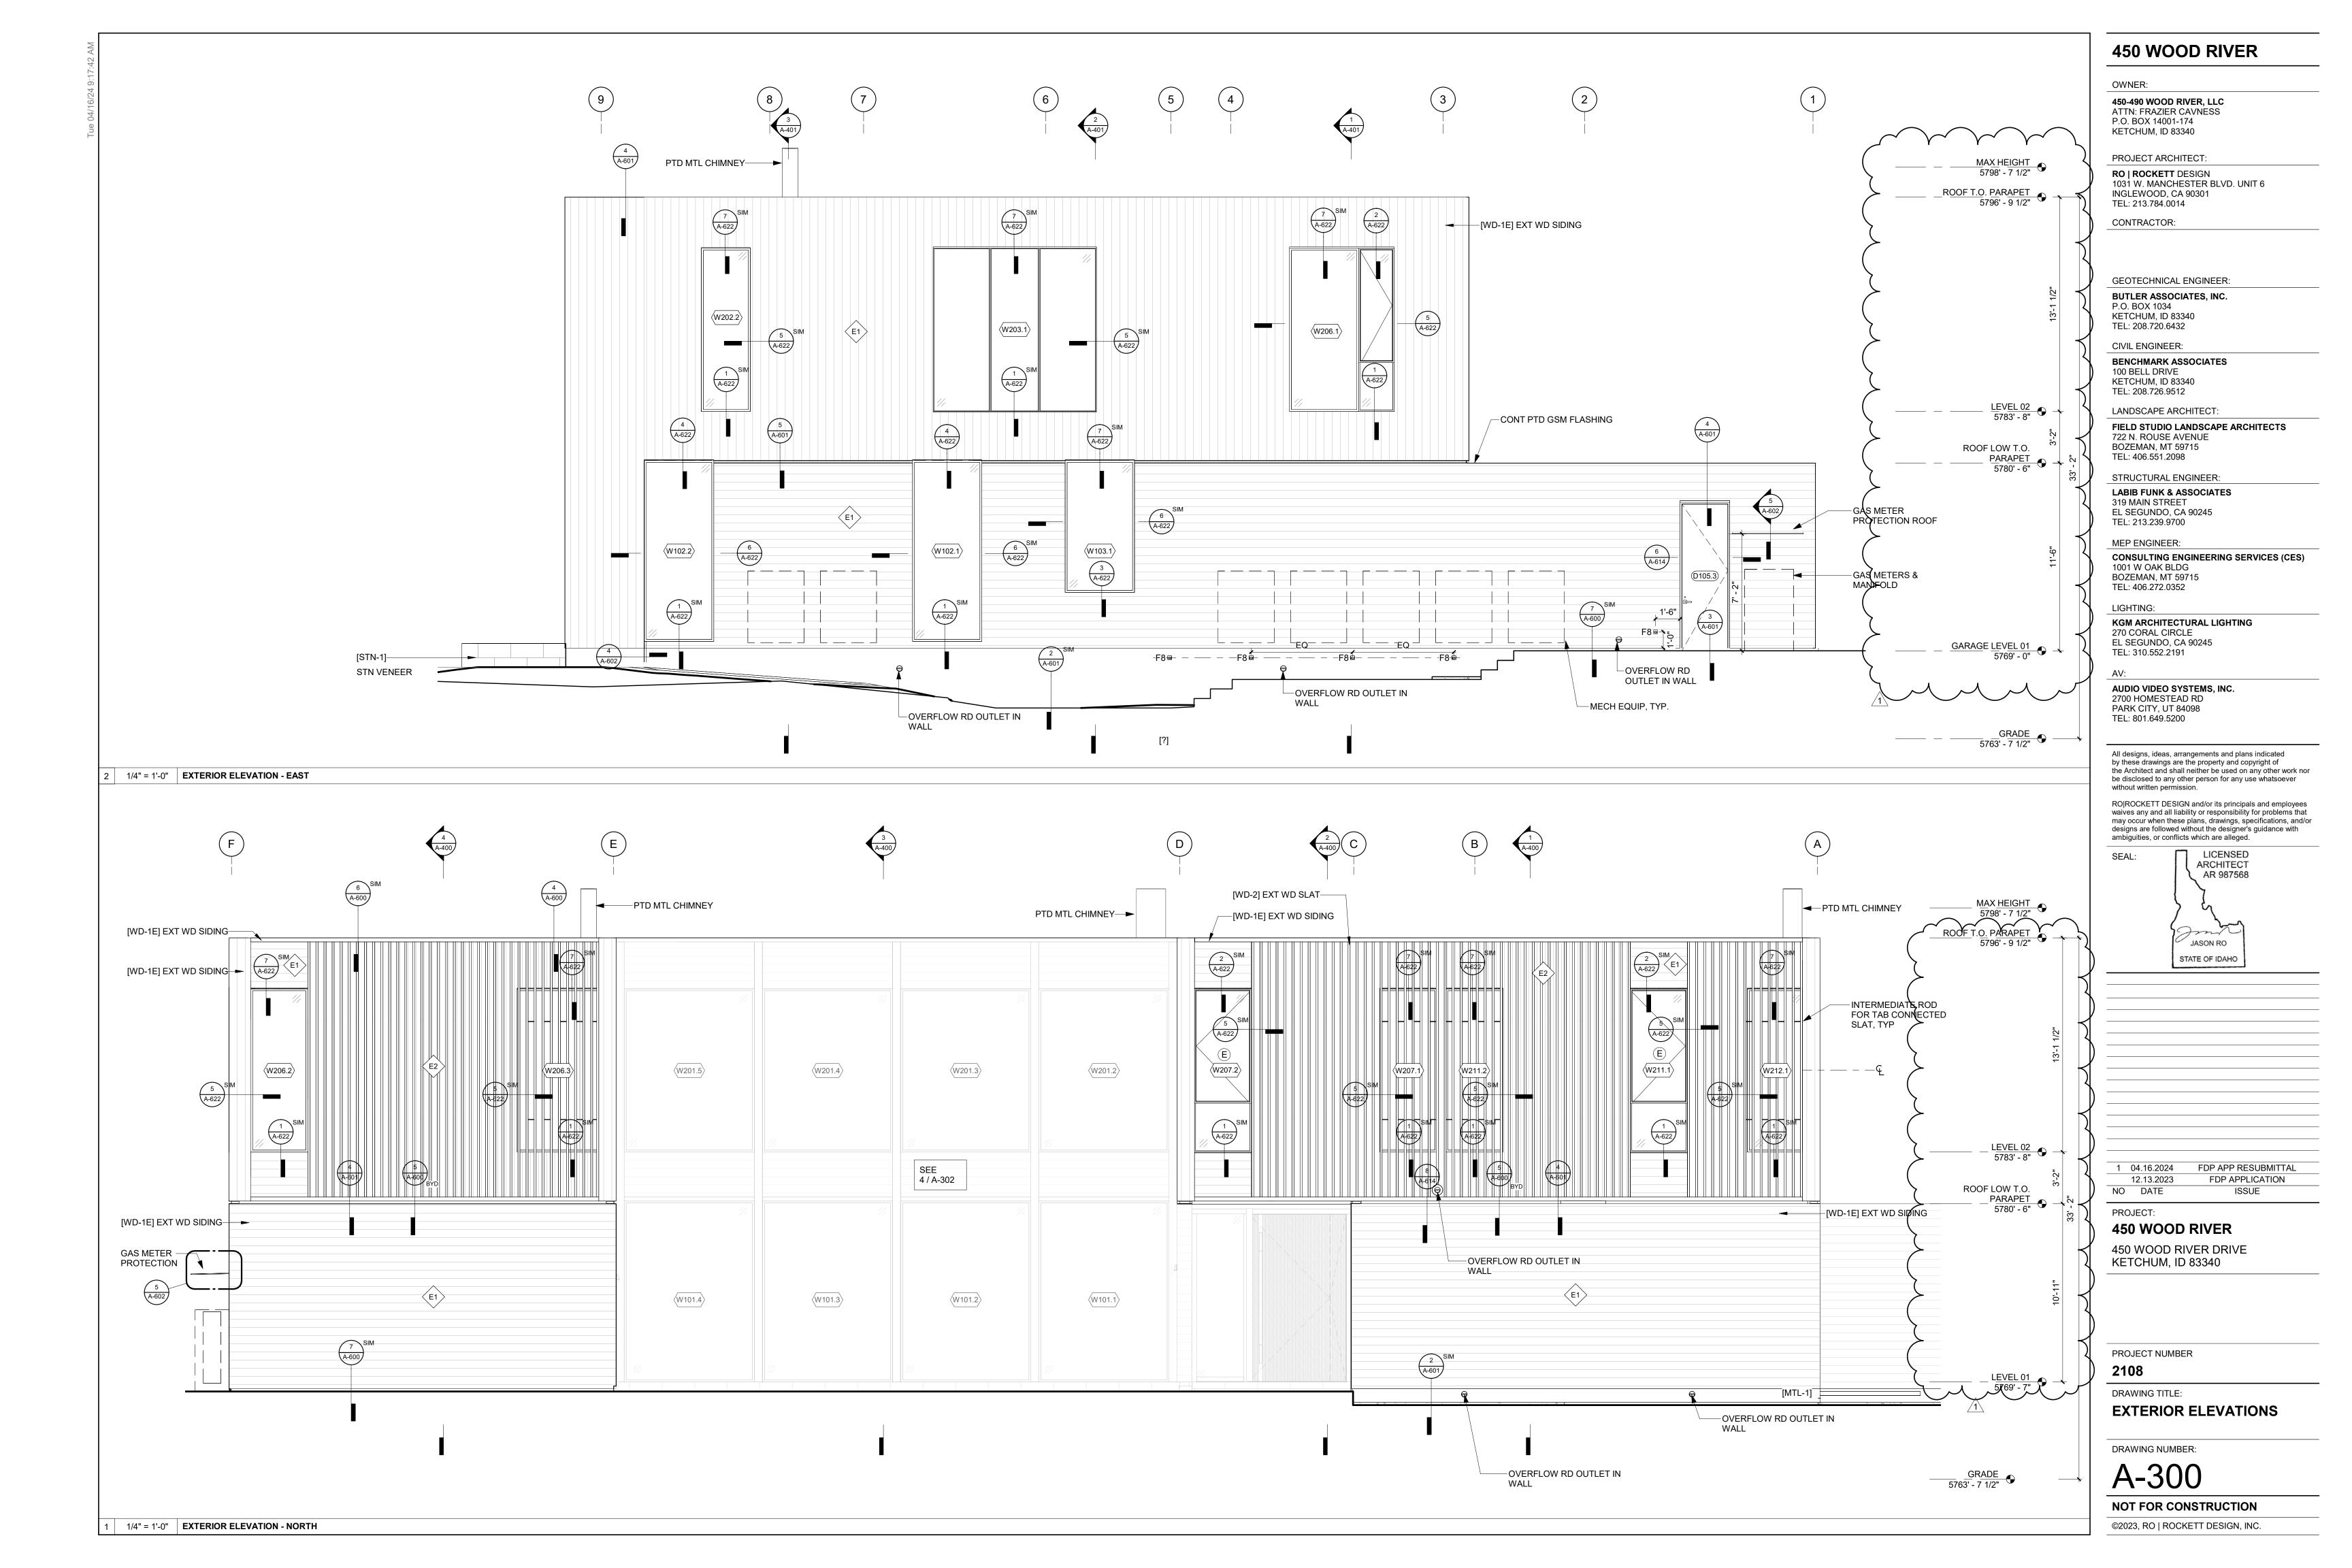

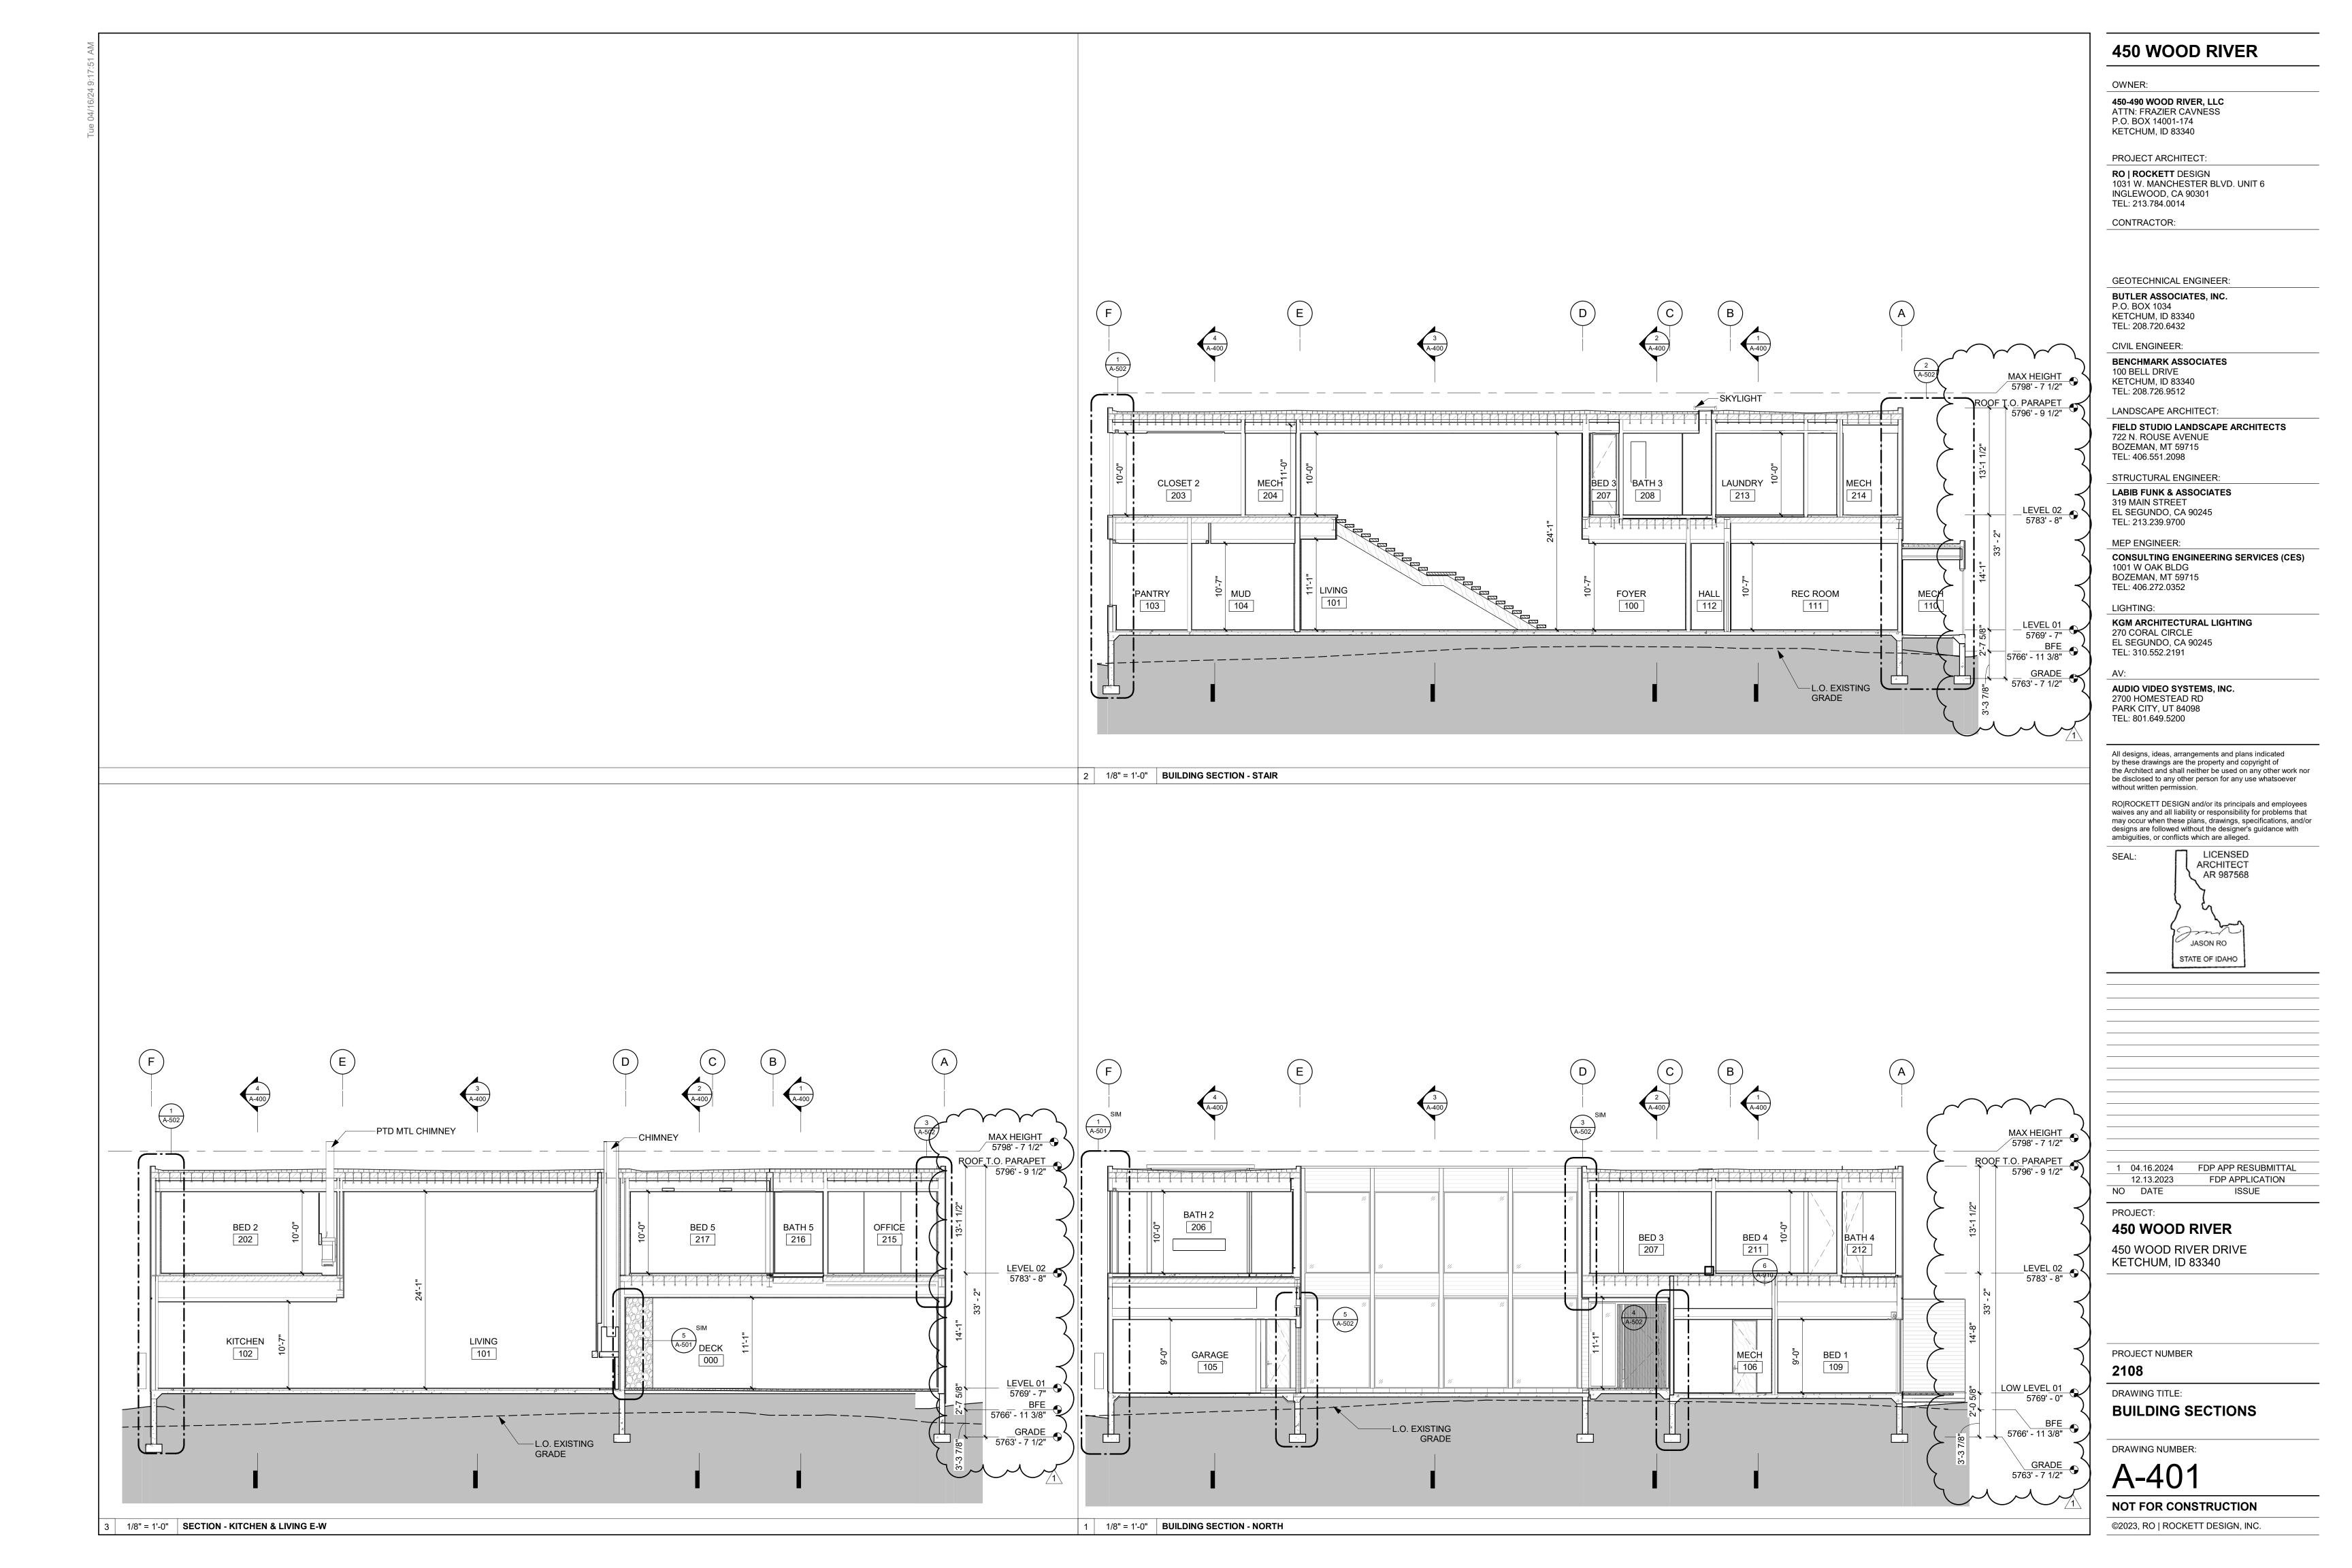

OWNER:

450-490 WOOD RIVER, LLC ATTN: MATT SCOGGINS P.O. BOX 14001-174 KETCHUM, ID 83340

PROJECT ARCHITECT: RO | ROCKETT DESIGN 1031 W. MANCHESTER BLVD. UNIT 6

CONTRACTOR:

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CIVIL ENGINEER: BENCHMARK ASSOCIATES

100 BELL DRIVE KETCHUM, ID 83340

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STRUCTURAL ENGINEER: LABIB FUNK & ASSOCIATES 319 MAIN STREET EL SEGUNDO, CA 90245 TEL: 213.239.9700 LFA Job #22777 MEP ENGINEER:

**CONSULTING ENGINEERING SERVICES (CES)** 1001 W OAK BLDG


BOZEMAN, MT 59715 TEL: 406.272.0352

LIGHTING:

KGM ARCHITECTURAL LIGHTING 270 CORAL CIRCLE EL SEGUNDO, CA 90245 TEL: 310.552.2191

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12/01/2023 PLAN CHECK RESUBMITTAL 05/05/2023 PLAN CHECK SUBMITTAL NO DATE

PROJECT:

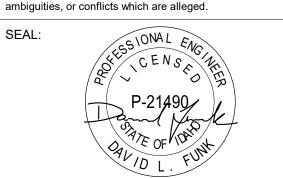450 WOOD RIVER

450 WOOD RIVER DRIVE KETCHUM, ID 83340

PROJECT NUMBER

DRAWING TITLE:

FOUNDATION/LEVEL 1 PLAN

DRAWING NUMBER:

S-101