



City of Ketchum Planning & Building

OFFICIAL	USE ONLY
File Number:	P23-081
Date Receive	d: 9/11/23
By:	HLN
Fee Paid:	\$250
Approved Da	ite:
Denied Date:	
By:	

Floodplain Development Permit and Riparian Alteration Application

NOTE: This permit is required for all properties containing 100 year floodplain area and Riparian Setbacks

PROPERTY OWNER INFORMATION	N		
THE RESIDENCE OF THE PARTY OF T	YICHARL HARRIEY		
Property Owner's Mailing Addre		AYE. \$ 593 HONE	LULU . HI 96816
Phone: 909 - 358 -	1330	7.46. 1 507,0000	-000, WI 1001-
mail: MH 96816 C			
ROJECT INFORMATION			
roject Name: HARTLEY	/		
		KURT EGGETS	
roject Representative's Phone:	208-725-0988		
roject Representative's Mailing		CETURUM, ID 8339	ED .
roject Representative's Email:	KUNT P EGGETTS ASSOCI		
rchitect's name, phone number			
	one number, e-mail: KURT EUG	ETVS	
nvironmental consultant's nam			
ngineer's name, phone number			
	VER ROCK ROAD		
egal Description of parcel: 13	1660000 SUB #1 L	OT 1 BLOCK-1	
ot Size: 2-9 Aunes			
oning District: LP 2			
verlay Zones - indicate all that	apply: Floodplain Flood	way Riparian Zone	☐ Avalanche ☐ Mountain
rief description of project scope	e:		10
	HOUSE APOITION AND	Acussom Publin	6 UNIT
alue of Project: \$ 500,00	0		
YPE OF PROJECT - indicate all t	hat apply:		
New Building in Floodplain	☐ Building Addition in Floodplain	☐ Streambank Stabilization /	Other. Please describe:
Riparian Alteration	☐ Floodplain Development	Stream Alteration	MONE OF THESE
ROPOSED SETBACKS - if project	t is a new building or an addition to a	n existing building	
ront: 33	Side: 22	Side: 15	Rear: 491
DDITIONAL INFORMATION			
/ill fill or excavation be required	d in floodplain, floodway or riparian zo	ne? Yes □ No l	×
Yes, Amount in Cubic Yards:	Fill: CY Excavation:	CY	
/ill Existing Trees or Vegetation	be Removed? Yes 🔀	No 🗆	
/ill new trees or vegetation be p	planted? Yes 🗡 N	o 🗆	
	1		
	event of a dispute concerning the inte		
	hich the City of Ketchum is the prevailing		
	nses of the City of Ketchum. I, the unde		on submitted with and upon
this application form is tr	ue and accurate to the best of my know	COLUMN COLUMN	
KAN. E	1-		17.23
Signature of Owner/Renr	ecentative	Date	

FLOODPLAIN MANAGEMENT OVERLAY EVALUATION STANDARDS

Please provide a narrative to address each of the criteria below.

Criteria for Evaluation of Applications: The criteria of floodplain development permit applications and riparian alteration permits shall be as follows:

- 1. The proposal preserves or restores the inherent natural characteristics of the river, floodplain, and Riparian Zone, including riparian vegetation and wildlife habitat. Development does not alter river channel unless all stream alteration criteria for evaluation are also met. Ho DEVELOPMENT IS PROPOSED IN THE FLOODPUM OR RIPHILIM ZONE.
- 2. No temporary construction activities, encroachment, or other disturbance into the twenty-five foot (25') Riparian Zone, including encroachment of below grade structures, shall be permitted, except for approved stream stabilization work and restoration work associated with a riparian zone that is degraded. NO ACTIVITIES ARE PROPESSO IN THE 25' RIPARIAN ZONE.
- 3. No permanent development shall occur within the twenty-five foot (25') Riparian Zone, except for approved stream stabilization work and restoration work associated with permit issued under this title, or exceptions as described below:

 NO PERMEMONIAN DEVELOPMENT 13 PROPOSED IN THE 25' PARMEN ZONE.

 a. Access to a property where no other primary access is available.
 - b. Emergency access required by the Fire Department.
 - c. A single defined pathways or staircases for the purpose of providing access to the river channel and in order to mitigate multiple undefined social paths.
 - d. Development by the City of Ketchum
- 4. New or replacement planting and vegetation in the Riparian Zone shall include plantings that are low growing and have dense root systems for the purpose of stabilizing stream banks and repairing damage previously done to riparian vegetation. Examples of such plantings most commonly include red osier dogwood, common chokecherry, serviceberry, elderberry, river birch, skunk bush sumac, Beb's willow, Drummond's willow, little wild rose, gooseberry, and honeysuckle. However, in rare instances the distance from the top-of-bank to the mean high-water mark is significant and the native vegetation appropriate for the Riparian Zone are low growing, drought resistant grasses and shrubs. Replacement planting and vegetation shall be appropriate for the specific site conditions. Proposal does not include vegetation within the twenty-five foot (25') Riparian Zone that is degraded, not natural, or which does not promote bank stability.
- 5. Landscaping and driveway plans to accommodate the function of the floodplain allow for sheet flooding. Surface drainage is controlled and shall not adversely impact adjacent properties including driveways drained away from paved roadways. Culvert(s) under driveways may be required. Landscaping berms shall be designed to not dam or otherwise obstruct floodwaters or divert same onto roads or other public pathways.
- 6. Floodwater carrying capacity is not diminished by the proposal.

N/A

- 7. Impacts of the development on aquatic life, recreation, or water quality upstream, downstream or across the stream are not negative.
- 8. Building setback in excess of the minimum required along waterways is encouraged. An additional tenfoot (10') building setback beyond the required twenty-five foot (25') Riparian Zone is encouraged to provide for yards, decks and patios outside the twenty five foot (25') Riparian Zone.

9. The top of the lowest floor of a building located in, or partially within, the SFHA shall be at or above the Flood Protection Elevation (FPE). A building is considered to be partially within the SFHA if any portion of the building or appendage of the building, such as footings, attached decks, posts for upper story decks, are located within the SFHA. See section 17.88.060, figures 1 and 2 of this chapter to reference construction details. See Chapter 17.08 of this title for definition of "lowest floor."

a. In the SFHA where Base Flood Elevations (BFEs) have been determined, the FPE shall be twenty-four inches (24") above the BFE for the subject property; twenty-four inches (24") or two (2) feet is the required freeboard in Ketchum city limits. N/A - NO BULLDING IN FLOODPLAIN.


b. In the SFHA where no BFE has been established, the FPE shall be at least two (2) feet above the highest adjacent grade.

- The backfill used around the foundation in the SFHA floodplain shall provide a reasonable transition to existing grade but shall not be used to fill the parcel to any greater extent.
 - a. Compensatory storage shall be required for any fill placed within the floodplain.
 - b. A CLOMR-F shall be obtained prior to placement of any additional fill in the floodplain.
- 11. All new buildings located partially or wholly within the SFHA shall be constructed on foundations that are designed by a licensed professional engineer.
- 12. Driveways shall comply with City of Ketchum street standards; access for emergency vehicles has been adequately provided for by limiting flood depths in all roadways to one foot (1-ft) or less during the 1% annual chance event.
- 13. Landscaping or revegetation shall conceal cuts and fills required for driveways and other elements of the development.
- 14. (Stream alteration.) The proposal is shown to be a permanent solution and creates a stable situation.
- 15. (Stream alteration.) No increase to the one percent (1%) annual chance flood elevation at any location in the community, based on hydrologic and hydraulic analysis performed in accordance with standard engineering practice and has been certified and submitted with supporting calculations and a No Rise Certificate, by a registered Idaho engineer.
- (Stream alteration.) The project has demonstrated No Adverse Impact or has demonstrated all impacts will be mitigated.

- 17. (Stream alteration.) The recreational use of the stream including access along any and all public pedestrian/fisher's easements and the aesthetic beauty shall not be obstructed or interfered with by the proposed work.
- 18. (Stream alteration.) Fish habitat shall be maintained or improved as a result of the work proposed.
- 19. (Stream alteration.) The proposed work shall not be in conflict with the local public interest, including, but not limited to, property values, fish and wildlife habitat, aquatic life, recreation and access to public lands and waters, aesthetic beauty of the stream and water quality.
- 20. (Stream alteration.) The work proposed is for the protection of the public health, safety and/or welfare such as public schools, sewage treatment plant, water and sewer distribution lines and bridges providing particularly limited or sole access to areas of habitation.
- 21. (Wetlands) Where development is proposed that impacts any wetland the first priority shall be to move development from the wetland area. Mitigation strategies shall be proposed at time of application that replace the impacted wetland area with an equal amount and quality of new wetland area or riparian habitat improvement.

HARTLEY RESIDENCE REMODEL

AUGUST 21st, 2023 130 RIVER ROCK RD KETCHUM, ID 83340

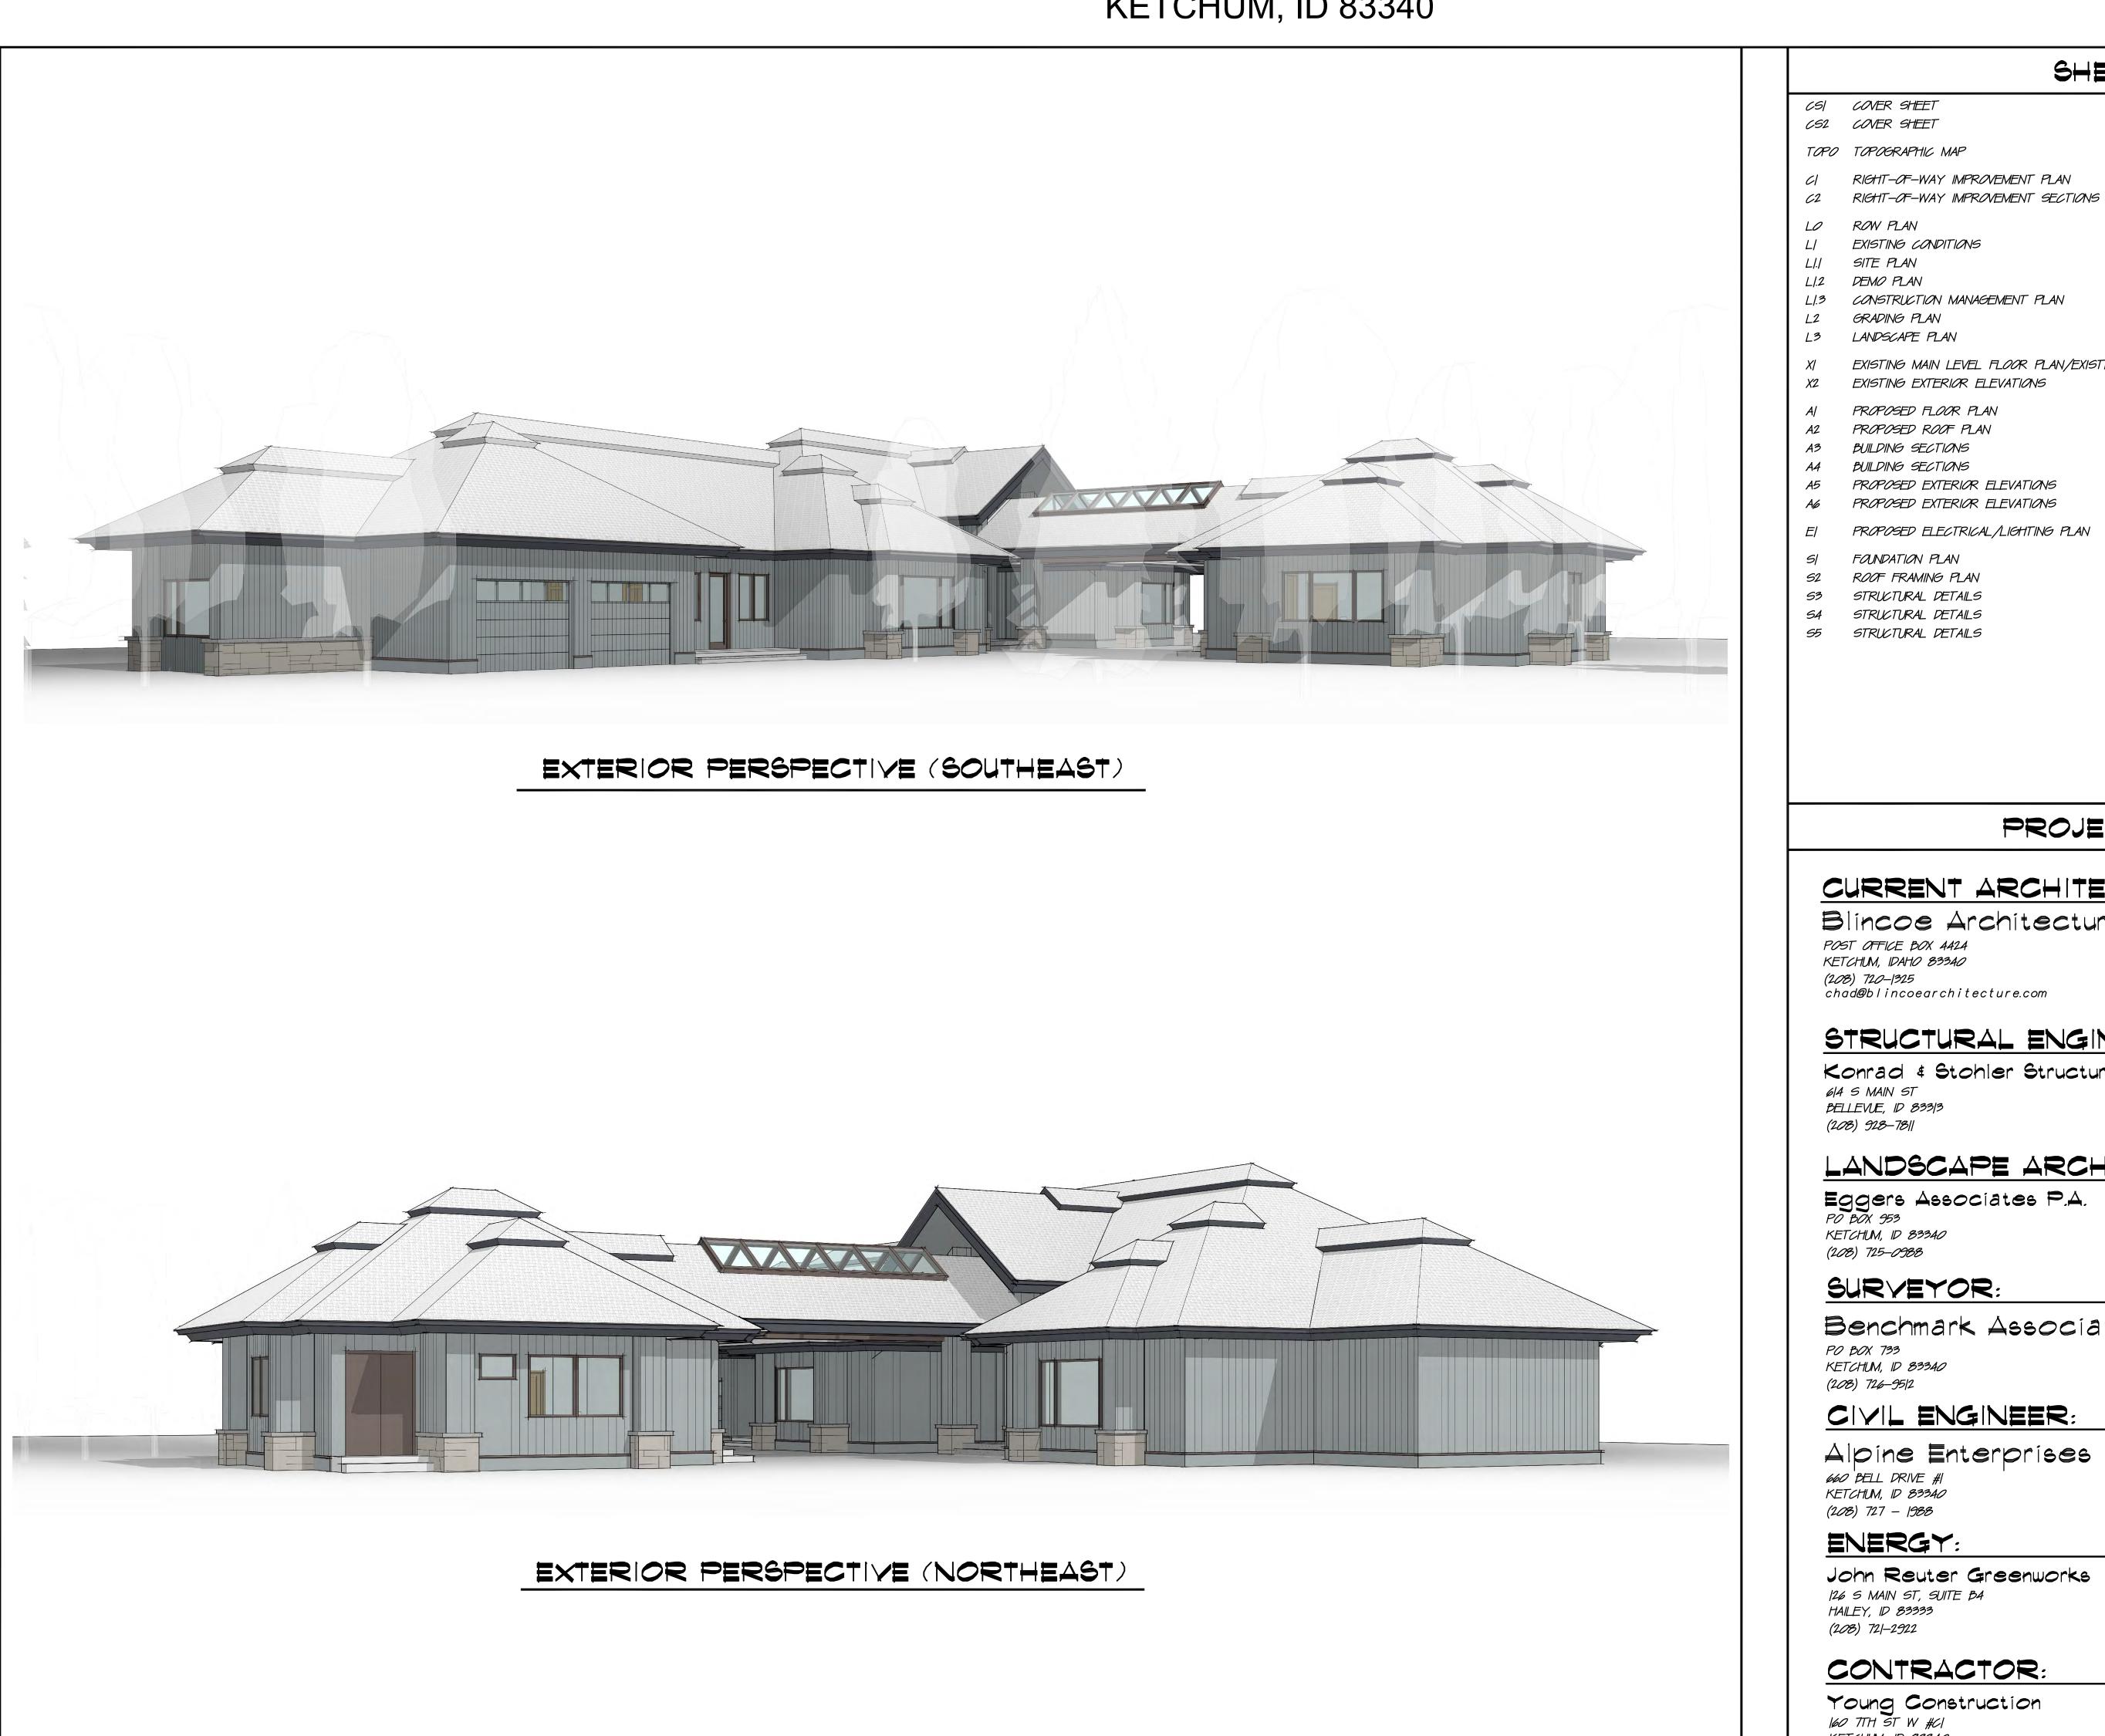

SHEET INDEX

- RIGHT-OF-WAY IMPROVEMENT PLAN
- EXISTING CONDITIONS
- CONSTRUCTION MANAGEMENT PLAN
- EXISTING MAIN LEVEL FLOOR PLAN/EXISTING ROOF PLAN/DEMOLITION PLAN

- BUILDING SECTIONS
- BUILDING SECTIONS
- PROPOSED EXTERIOR ELEVATIONS
- PROPOSED ELECTRICAL/LIGHTING PLAN
- ROOF FRAMING PLAN
- STRUCTURAL DETAILS

PROJECT TEAM

CURRENT ARCHITECT:

Blincoe Architecture

chad@blincoearchitecture.com

STRUCTURAL ENGINEER:

Konrad & Stohler Structural Engineering, LLC

LANDSCAPE ARCHITECT:

Benchmark Associates

Alpine Enterprises INC.

John Reuter Greenworks

CONTRACTOR:

KETCHUM, ID 83340


(208) 725-2001


REMO

PLOT DATE: **DESIGN REVIEW:** CONSTRUCTION:

HARTLEY RESIDENCE REMODEL

AUGUST 21st, 2023 130 RIVER ROCK RD KETCHUM, ID 83340

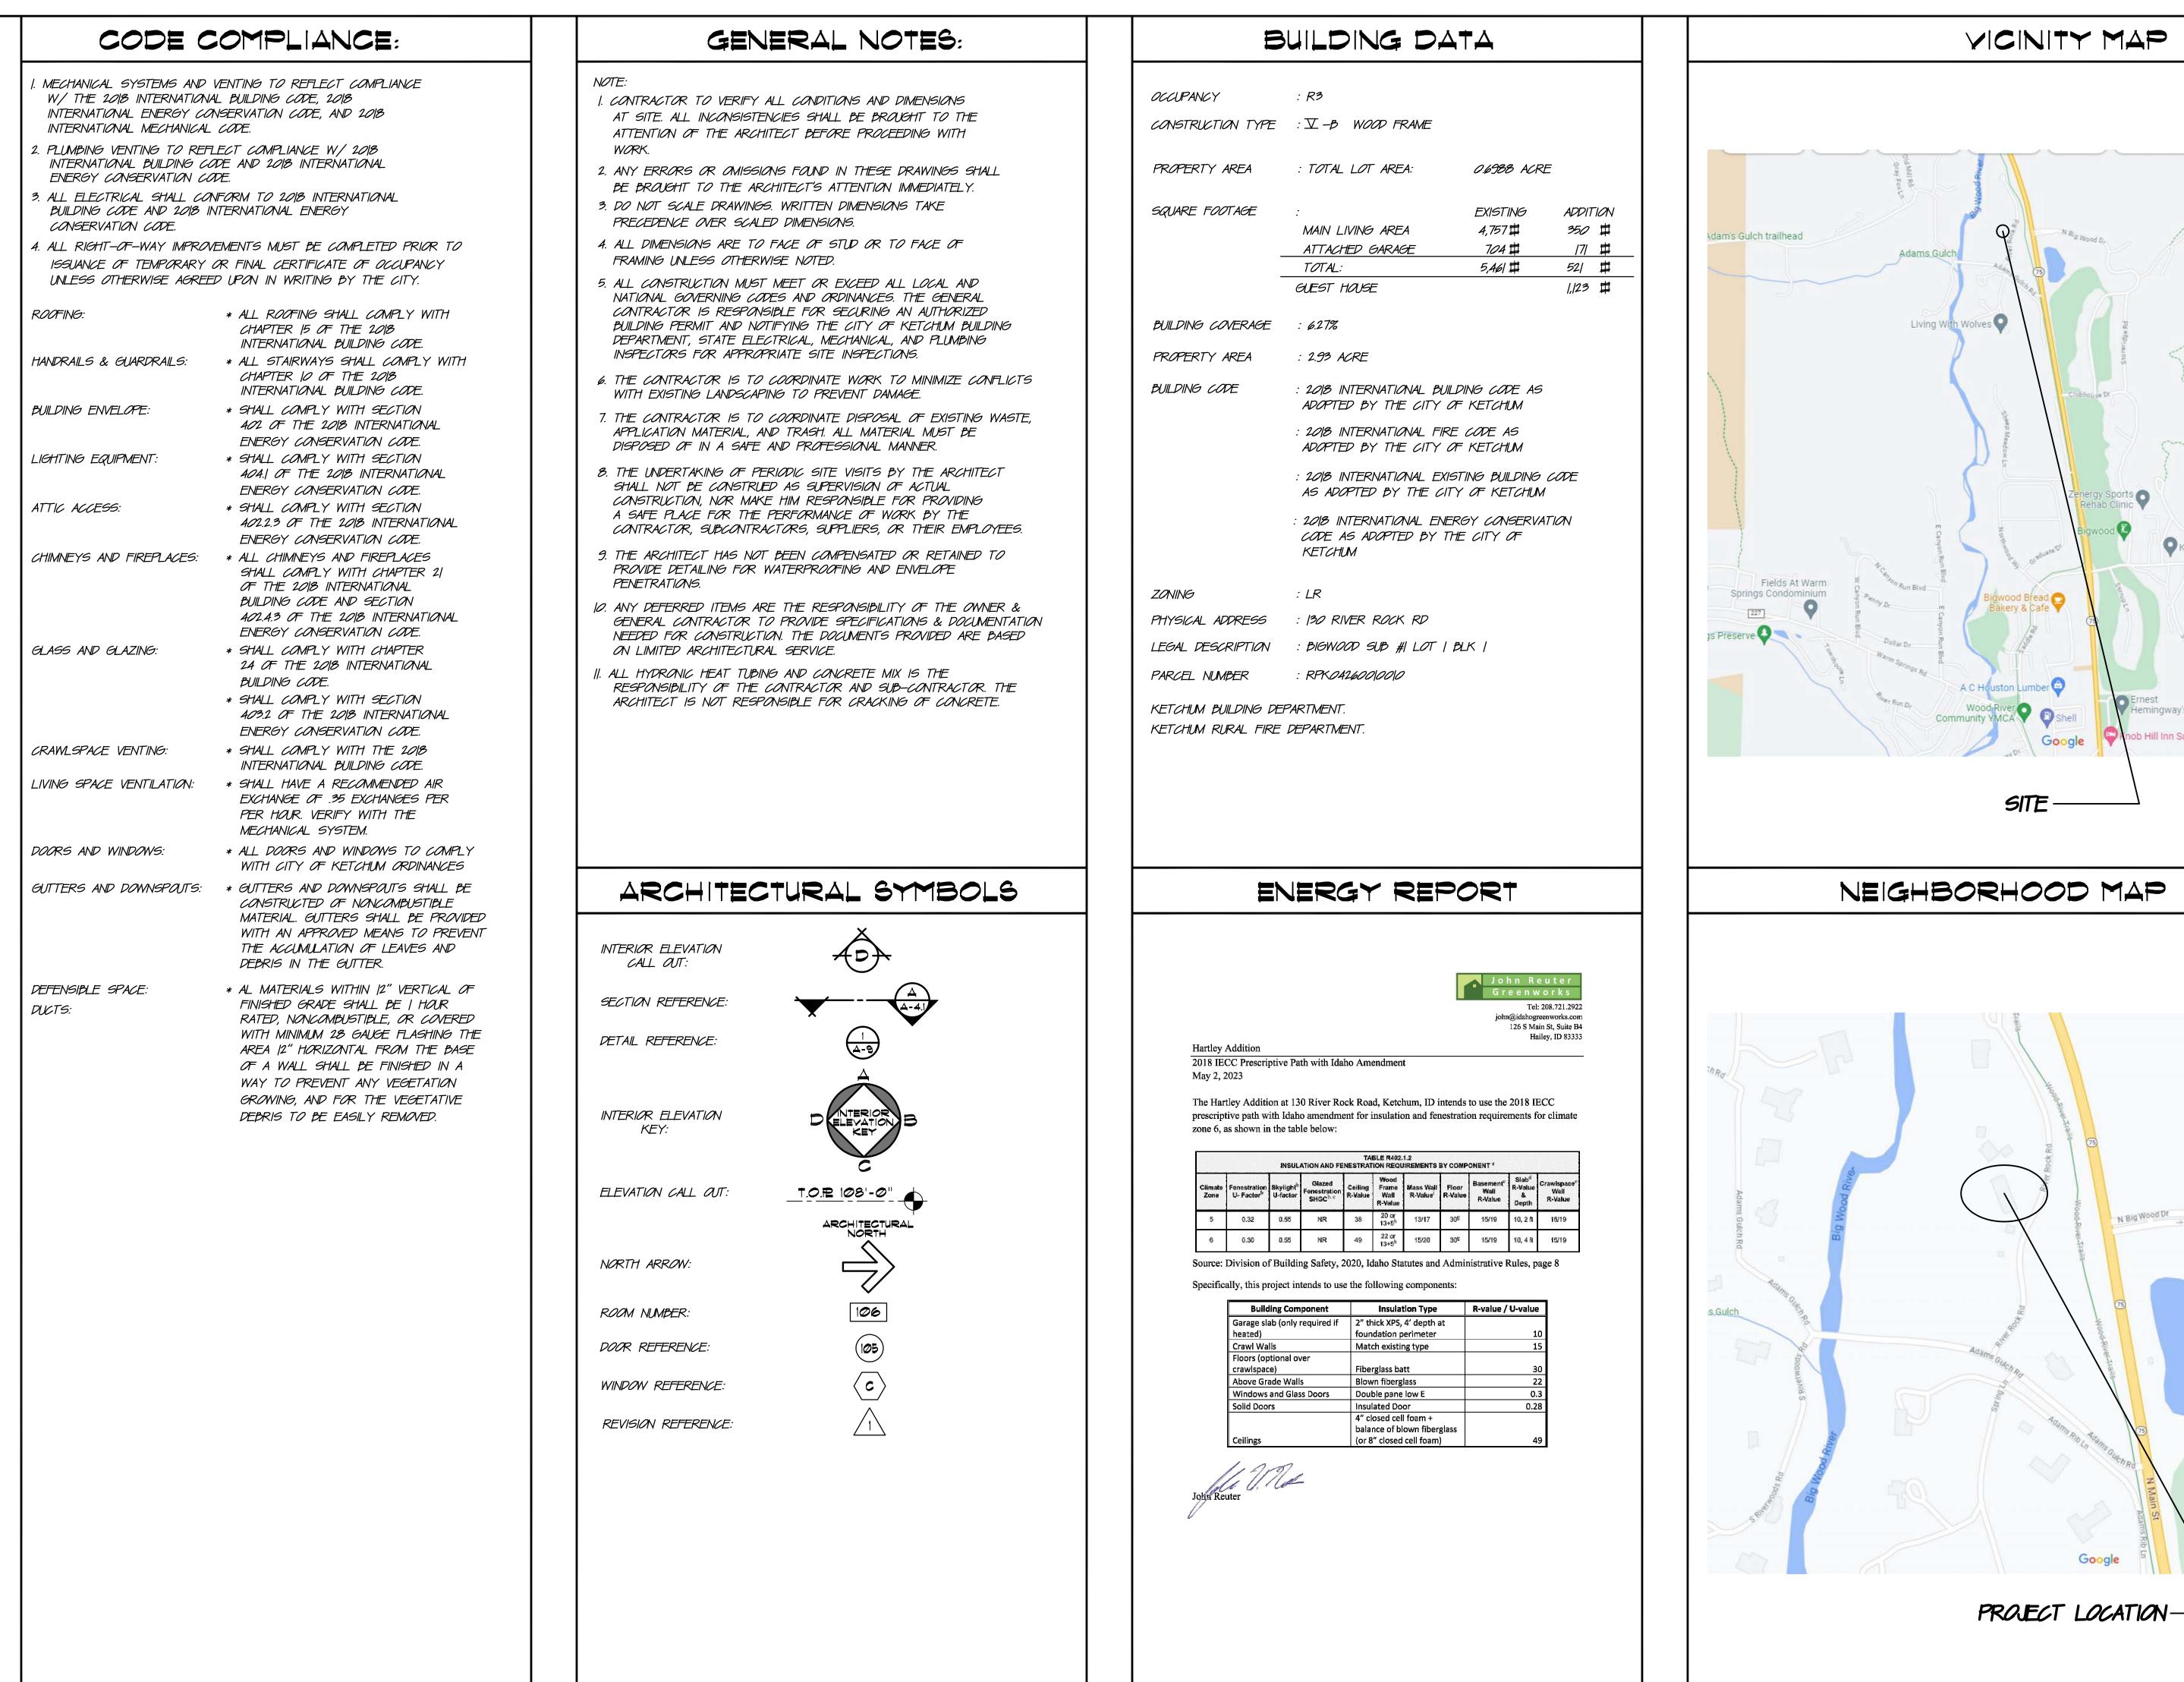

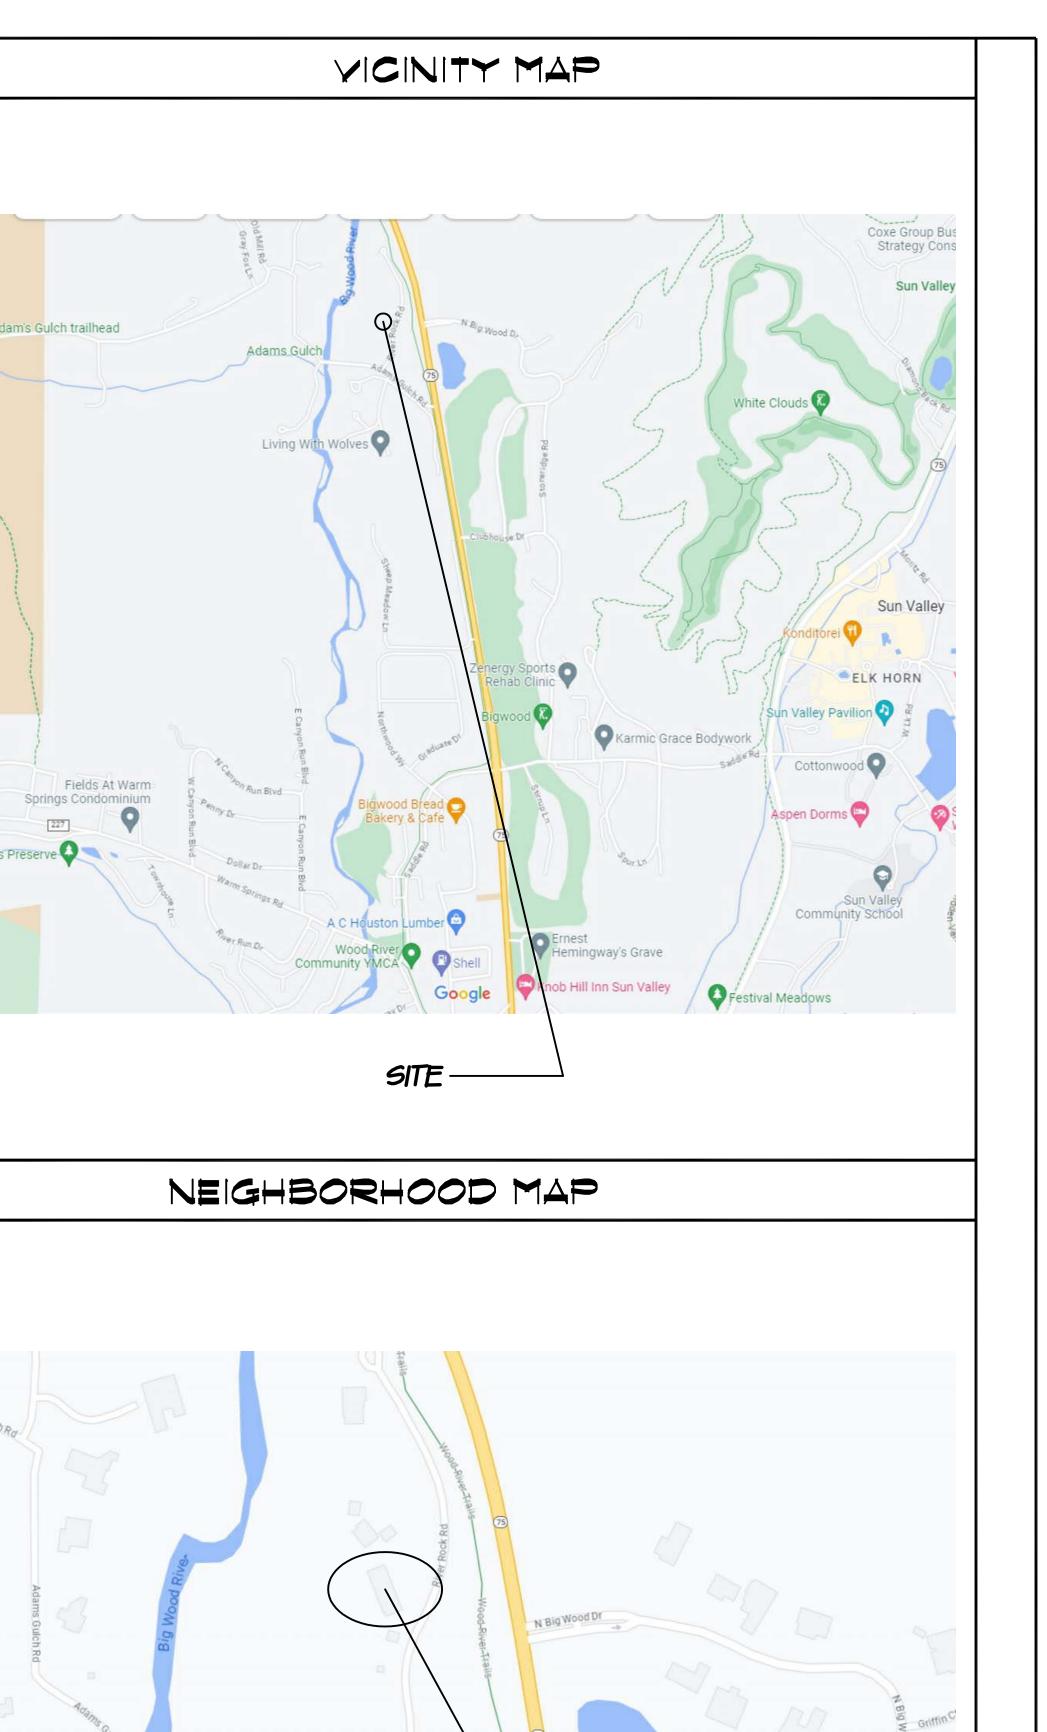

PLOT DATE: **DESIGN REVIEW:** CONSTRUCTION:

006.22

4/20/23

Blinc

ВА

LICENSED ARCHITECT AR 984602

CHAD E. BLINCOE

STATE OF IDAHO



NOTES

THE PURPOSE OF THIS MAP IS TO SHOW LIMITED SITE INFORMATION AS IT EXISTED ON THE DATE THE FIELD SURVEY WAS PERFORMED IN RELATION TO PLATTED LOT LINES. CHANGES MAY HAVE OCCURRED TO SITE CONDITIONS SINCE SURVEY DATE. LOT LINES ARE BASED ON FOUND MONUMENTS. ALL FOUND MONUMENTS WERE ACCEPTED AS EITHER ORIGINAL CORNERS, OR REPLACEMENTS OF ORIGINAL CORNERS. SET MONUMENTS WERE ESTABLISHED USING PROPORTIONED DISTANCES AND BEARINGS ADJUSTED TO BLAINE

REFERENCED SURVEYS: PLAT OF BIGWOOD SUBDIVISION NO. 1, INST. NO. 278229

BOUNDARY DIMENSIONS SHOWN HEREON ARE MEASURED. FOR RECORD DIMENSIONS, SEE REFERENCED SURVEYS.

VERTICAL DATUM: ELEVATIONS BASED ON NAVD 88 (GEOID03) DATUM UTILIZING SMARTNET CORS STATION IDKM.

UNDERGROUND UTILITIES WERE NOT LOCATED AND ARE NOT SHOWN HEREON. THIS MAP WAS PREPARED FOR THE EXPRESS USE OF THE CLIENT AND IS NOT TRANSFERABLE TO OTHERS WITHOUT WRITTEN CONSENT BY BENCHMARK ASSOCIATES AND IS NOT VALID OR TO BE USED BY OTHER PARTIES FOR ANY REASON INCLUDING BUT NOT LIMITED TO REAL ESTATE TRANSACTIONS,

BUILDING APPLICATIONS, PERMITS, ETC. A TITLE POLICY HAS NOT BEEN SUBMITTED TO BENCHMARK ASSOCIATES, NOR HAS A TITLE SEARCH BEEN REQUESTED. CERTAIN INFORMATION CONTAINED WITHIN SAID POLICY MAY NOT APPEAR ON THIS MAP OR MAY AFFECT ITEMS SHOWN ON THIS MAP.

ELECTRONIC DATA: BENCHMARK ASSOCIATES ACCEPTS NO RESPONSIBILITY OR LIABILITY FOR THE REUSE. DISTRIBUTION OR ACCURACY OF DATA CONTAINED ON ELECTRONIC COPIES OF THIS DRAWING. THE STAMPED HARD COPY OF THIS DRAWING IS THE FINAL PRODUCT.

THIS DRAWING IS VOID AFTER 2 YEARS AND NO FURTHER COPIES OR DIGITAL FILES WILL BE TRANSMITTED.

EASEMENTS, ENCUMBRANCES AND RESTRICTI

10. BUILDING AREA: BUILDING ENVELOPE IF SHOWN, IS PER PLAT. SETBACK AND FOOTPRINT REQUIREMENTS PER CURRENT CITY/COUNTY ORDINANCES MAY VARY FROM PLAT. IT IS RECOMMENDED THAT SAID ORDINANCES BE REVIEWED PRIOR TO DESIGN.

GENERAL RESTRICTIONS: EXCEPT AS SPECIFICALLY STATED OR SHOWN ON THIS MAP, THIS SURVEY DOES NOT PURPORT TO REFLECT ANY OF THE FOLLOWING WHICH MAY APPLICABLE TO THE SUBJECT OF REAL ESTATE: EASEMENTS, OTHER THAN THOSE SHOWN OR LISTED HEREON, BUILDING SETBACK LINES, RESTRICTIVE COVENANTS, SUBDIVISION RESTRICTIONS, ZONING, WETLANDS, AVALANCHE OR ANY OTHER LAND-USE REGULATIONS OR HAZARDS.

BASIS OF BEARINGS IS IDAHO STATE PLANE COORDINATE SYSTEM, NAD83, CENTRAL ZONE AS DERIVED BY GPS OBSERVATIONS. ALL DISTANCES SHOWN ARE GROUND DISTANCES IN U.S. SURVEY FEET.

13. BOUNDARY LINES AND CERTAIN EASEMENTS SHOWN HEREON ARE PER PLAT. REFER TO PLAT & CC&R'S FOR CONDITIONS AND/OR RESTRICTIONS REGARDING

14. UTILITIES AND DRAIN PIPES IF SHOWN HEREON ARE PER SURFACE EVIDENCE ONLY. OTHER UNDERGROUND UTILITIES MAY EXIST. LOCATION OF UNDERGROUND UTILITIES AND SERVICES SHOULD BE CONFIRMED PRIOR TO EXCAVATION OR DESIGN.

15. BUILDING WALLS IF SHOWN HEREON ARE OUTSIDE FACE OF BUILDING UNLESS OTHERWISE NOTED.

SPRINKLER HEADS AND IRRIGATION LINES ARE NOT SHOWN HEREON. 17. TREE LOCATIONS AND DRIP LINES IF SHOWN HEREON ARE APPROXIMATE.

18. ORTHOPHOTOGRAPHY: PHOTO RECTIFIED AT GROUND LEVEL ONLY. IMAGES OF OBJECTS ABOVE GROUND LEVEL (TREES, BUILDINGS, POWER POLES, ETC.,) MAY BE DISPLACED. DATE OF PHOTOGRAPHY: MAY 2017.

19. CONTOUR INTERVAL: 1' - CONTOURS IN AREAS OF DENSE VEGETATION MAY DEVIATE FROM TRUE ELEVATION BY ONE HALF THE HEIGHT OF THE VEGETATION. DATE OF LIDAR FLIGHT FOR CONTOURS: 2017.

20. MAP SCALE: DUE TO ELECTRONIC MAP DELIVERY AND ALTERNATE PRINTING METHODS, PLEASE USE BAR SCALE TO DETERMINE ACTUAL PRINTED SCALE.

21. FEATURES OBSCURED FROM VIEW BY DEBRIS, SNOW, VEGETATION OR VEHICLES AT THE TIME OF SURVEY, DO NOT APPEAR ON THIS MAP.

WETLANDS

WETLANDS AND RIPARIAN: CERTAIN AREAS WITHIN THIS MAP MAY CONTAIN RIPARIAN, RIVERINE OR WETLANDS CONDITIONS. SAID AREAS AND THE LOCATION OF ORDINARY HIGH WATER (OHW), IF SHOWN HEREON, ARE SUBJECT TO INTERPRETATION. IT IS RECOMMENDED THAT THE LANDOWNER OR CLIENT RETAIN THE SERVICES OF AN ENVIRONMENTAL SPECIALIST IN ORDER TO ASCERTAIN IF SAID CONDITIONS EXIST, AND TO FURTHER IDENTIFY SAID AREAS IF THEY DO EXIST. PERMITS MAY BE REQUIRED FROM LOCAL, STATE OR FEDERAL AGENCIES PRIOR TO CONSTRUCTION, EXCAVATION OR FILL ACTIVITIES.


STORMWATER

STORM WATER PLAN: IF SOIL DISTURBANCE, CLEARING, GRADING AND/OR EXCAVATION OF ONE (1) ACRE OR MORE IS TO TAKE PLACE A FEDERAL GENERAL CONSTRUCTION PERMIT, INCLUDING A STORM WATER POLLUTION PREVENTION PLAN (SWPPP), MUST BE PREPARED AND SUBMITTED TO AND APPROVED BY THE U.S. ENVIRONMENTAL PROTECTION AGENCY PRIOR TO ANY SITE DISTURBANCE.

FLOOD NOTES

FLOOD PLAIN: THE 100-YR FLOOD PLAIN AREA, IF DESIGNATED ON THIS MAP IS CONSIDERED REASONABLE FOR REGULATORY PURPOSES. HOWEVER, BENCHMARK ASSOCIATES DOES NOT REPRESENT, GUARANTEE, WARRANT NOR IMPLY THAT AREAS OUTSIDE OF THE DESIGNATED FLOOD PLAIN AREA ARE SAFE AND FREE FROM FLOODS OR FLOOD DANGER. FLOOD INFORMATION IS BASED ON THE FLOOD INSURANCE STUDY FOR: BLAINE COUNTY, IDAHO, UNINCORPORATED AREAS) COMMUNITY NUMBER 16013C - PANEL NO. 0453 E - NOVEMBER 26, 2010.

FLOOD PLAIN DESIGN ELEVATIONS: CURRENT FEMA FLOOD INSURANCE REGULATIONS SPECIFY THE BOTTOM FLOOR OF STRUCTURE AS EITHER THE BOTTOM OF FOUNDATION CRAWL SPACE OR TOP OF SLAB. THE BASE FLOOD ELEVATION ON THE UPSTREAM SIDE OF THE STRUCTURE DETERMINES THE FLOOD ELEVATION FOR THE ENTIRE STRUCTURE AND SHOULD BE CONSIDERED PRIOR TO DESIGN. REFER TO LOCAL BUILDING CODES FOR ADDITIONAL CONSTRAINTS AND REGULATIONS.

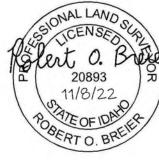

BENCHMARK ASSOCIATES P.O. BOX 733 - 100 BELL DRIVE, KETCHUM, IDAHO, 83340 PHONE (208)726-9512 FAX (208)726-9514

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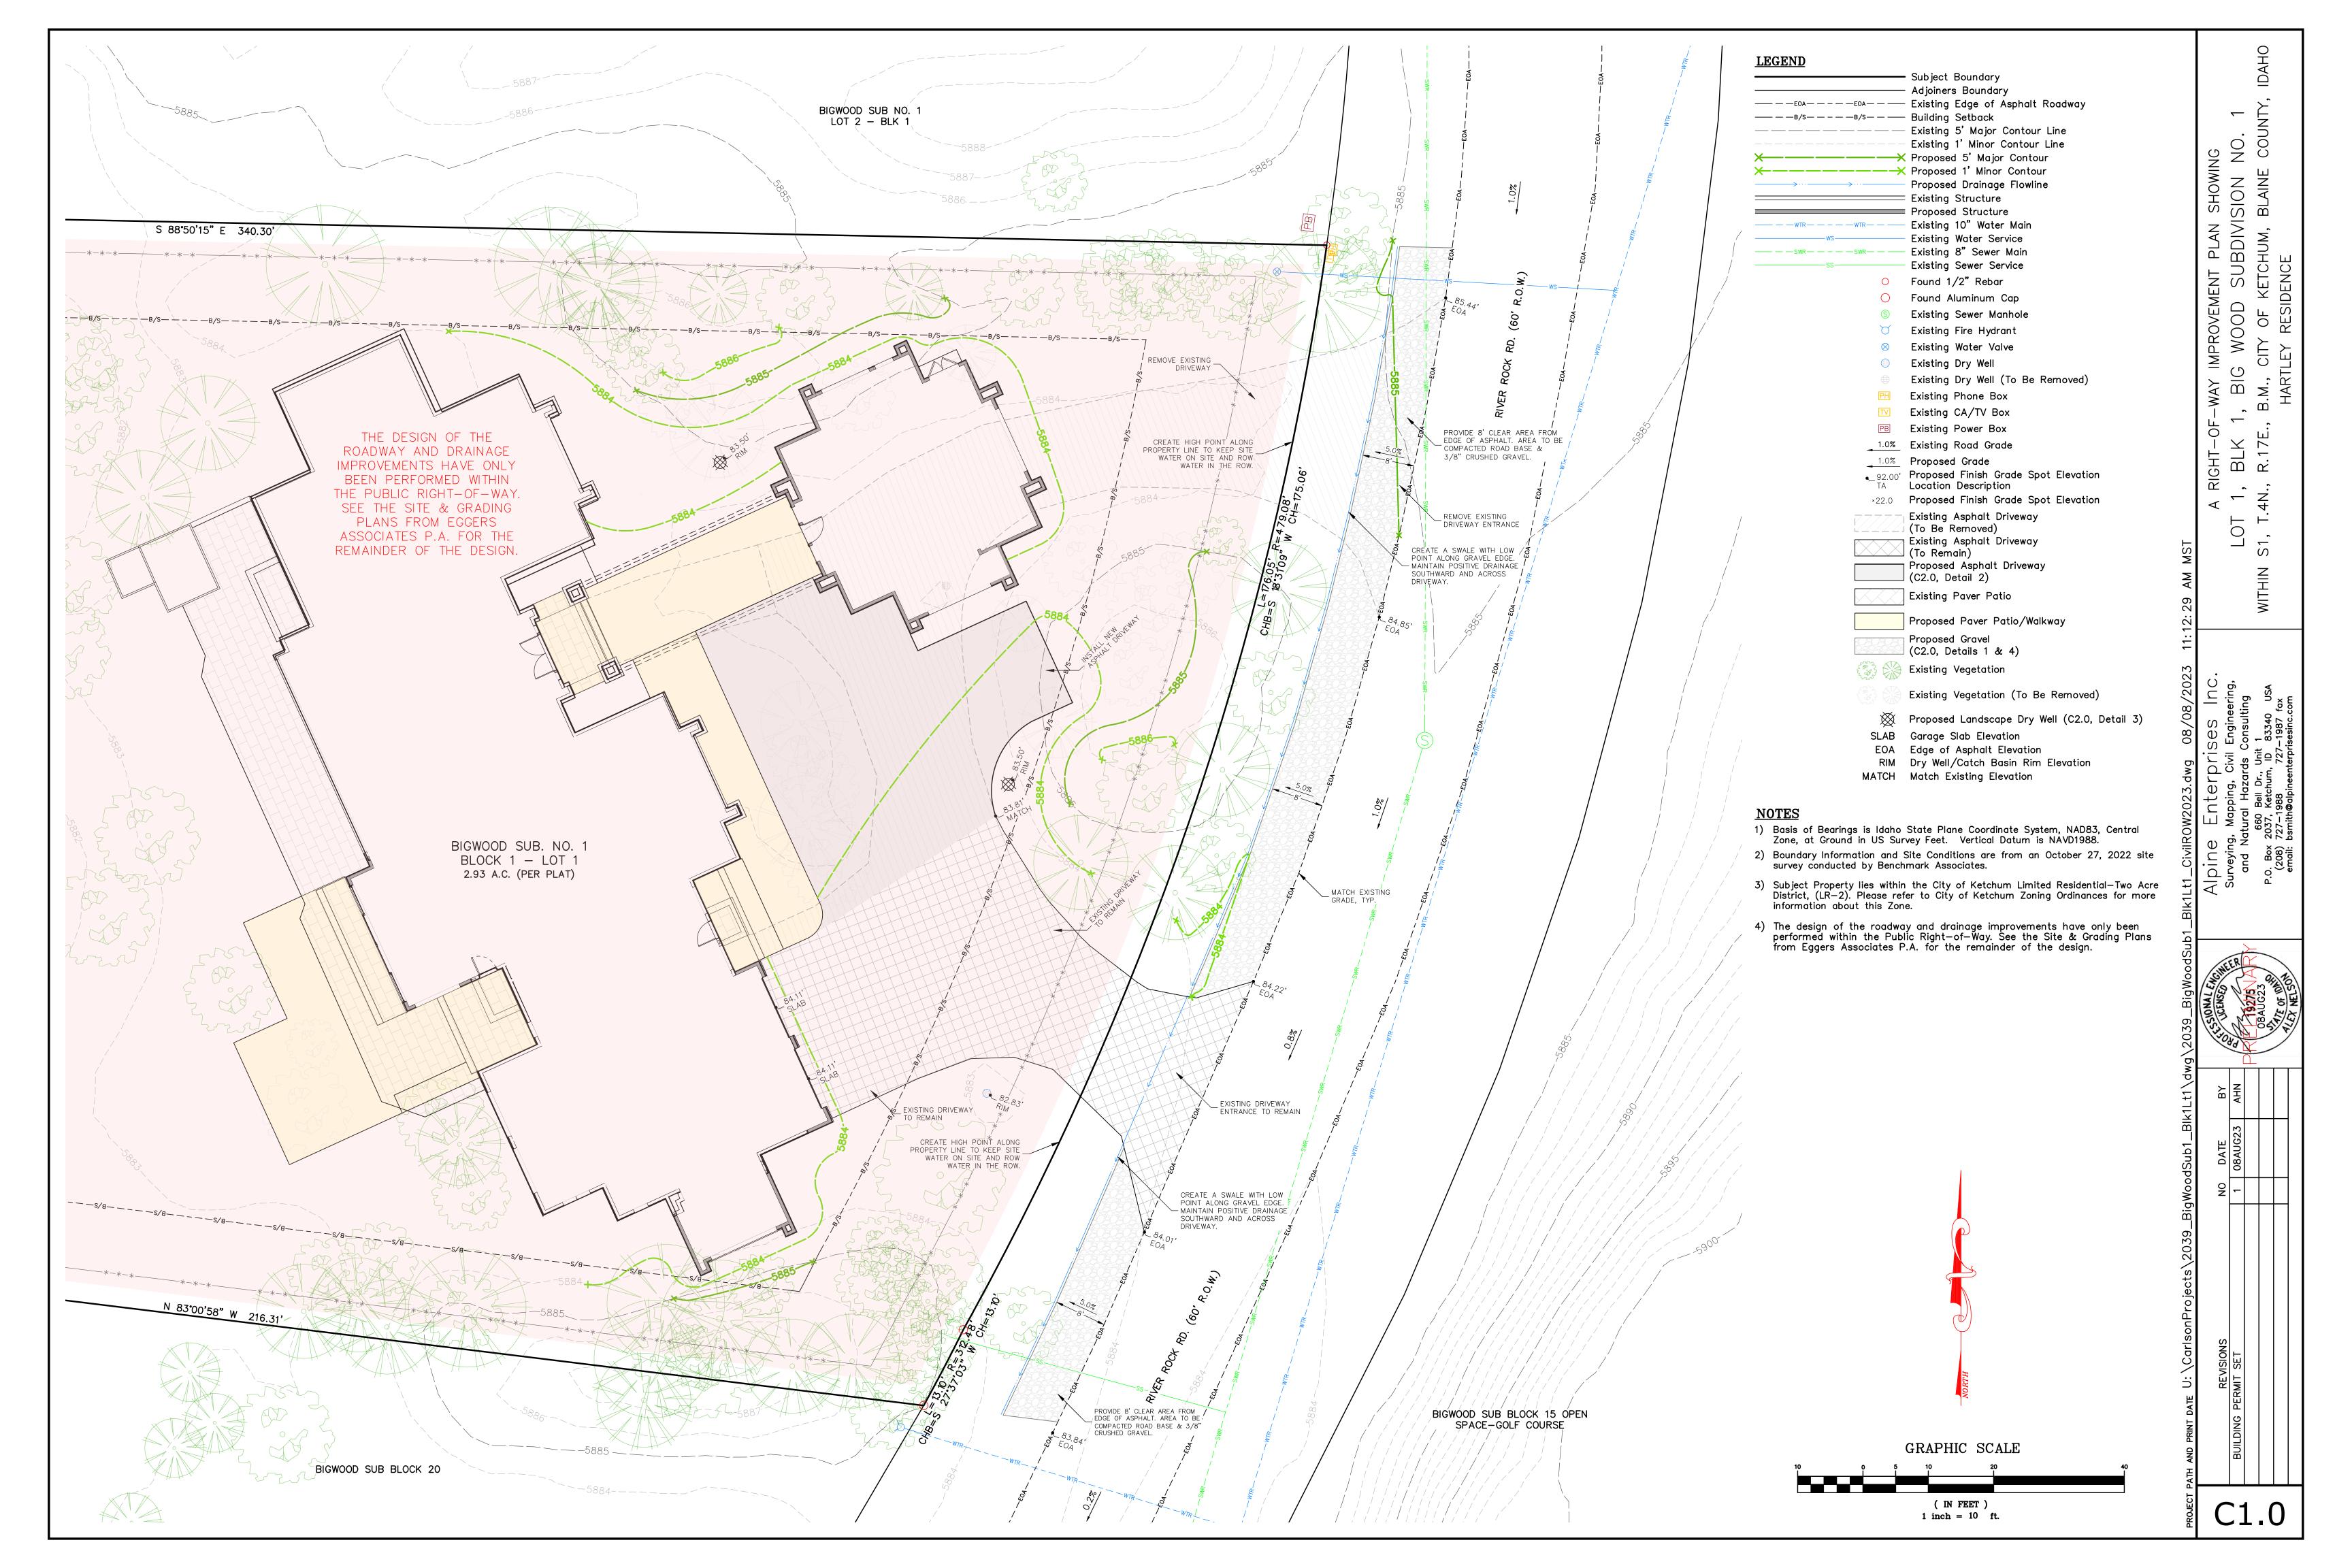
BIGWOOD SUBDIVISION NO. 1

BLOCK 1 - LOT 1 LOCATED WITHIN

SECTION 1, TOWNSHIP 4 NORTH, RANGE 17 EAST, B.M., CITY OF KETCHUM, BLAINE COUNTY, IDAHO REPARED FOR: IAN BLACKER - LOOMIS CONSTRUCTION


DWG BY: HDB | CRD: 22146.CRD | 22146_TOPO.DWG TOPOGRAPHIC MAP

DATE OF SURVEY: 10/27/2022 SHEET: 1 OF 1



GENERAL CONSTRUCTION NOTES

- 1) The location of existing underground utilities are shown on the plans in an approximate way. The contractor shall be responsible for locating existing utilities during the construction. The contractor agrees to be fully responsible for any and all damages which result from his failure to accurately locate and preserve any and all underground utilities.
- 2) The design of the roadway and drainage improvements have only been performed within the Public Right-of-Way. See the Site & Grading Plans from Eggers Associates P.A. for the remainder of the design.
- 3) Contractor shall assure positive drainage away from the building and driveway.
- 4) Contractor shall be responsible for dust control during construction of all items hereon. Dust control shall be continuous during construction, 24 hours per day 7 days per week. The contractor shall follow the requirements of the Storm Water Pollution Prevention Program at all times until permanent erosion control is established.
- 5) All construction shall be in accordance with the most current edition of the Idaho Standards for Public Works Construction, ISPWC, and the City of Ketchum, Idaho, Codes and Standards. The contractor shall be responsible for obtaining and keeping a copy of the ISPWC and the City of Ketchum Codes and Standards on site during construction.
- 6) Per Idaho Code, 55-1613, the contractor shall retain and protect all monuments, accessories to corners, benchmarks, and points set in control surveys. All monuments, accessories to corners, benchmarks, and points set in control surveys that are lost or disturbed by construction shall be reestablished and re-monumented, at the expense of the agency or person causing their loss or disturbance under the direction of a professional land surveyor.
- 7) The contractor shall clean up the site after construction so that it is in a condition equal to or better than that which existed prior to construction.
- 8) The contractor shall be required to obtain all the necessary permits prior to construction and shall check with the City of Ketchum for permits the owner may have already obtained.
- 9) All clearing and grubbing shall conform to ISPWC Section 201 and City of Ketchum standards of excavation and backfill.
- 10) All excavation and embankment shall conform to ISPWC Section 202 and City of Ketchum standards for excavation and backfill. Excavated subgrade shall be compacted and all unsuitable Sections removed and replaced with structural fill as determined by the engineer per ISPWC Section 204. Minimum compaction of placed material shall be 95% of maximum laboratory density as determined by AASHTO T-99 or IDT T-91.
- 11) All 2" minus aggregate shall be placed in conformance with ISPWC Section 802. It shall be compacted per ISPWC Section 202 and the City of Ketchum standards. 2" minus crushed aggregate material shall conform to ISPWC Section 802 Type II and to the City of Ketchum specifications. Minimum compaction of placed material shall be 95% of maximum laboratory density as determined by AASHTO T-99 or IDT T-91.
- 12) All 3/4" minus aggregate shall be placed in conformance with ISPWC Section 802. It shall be compacted per ISPWC Section 202 and the City of Ketchum standards. 3/4" minus crushed aggregate for leveling course shall conform to ISPWC Table 802 Type I and to the City of Ketchum specifications. Minimum compaction of placed material shall be 95% of maximum laboratory density as determined by AASHTO T-99 or IDT T-91.
- 13) All asphaltic concrete pavement work shall conform to ISPWC Section(s) 805, 810, and 811 for Class II pavement and to the City of Ketchum standards. Asphalt aggregate shall be 1/2" nominal size conforming to Table 803b in ISPWC Section 803. Asphalt binder shall be pg 58-28 conforming to Table A-1 in ISPWC Section 805.
- 14) All concrete work shall conform to ISPWC Sections 701 and 703. All concrete shall be 3.000 psi minimum. 28 day, as defined in ISPWC Section 703, Table 1.C.
- 15) All edges of existing asphalt paving shall be saw cut a minimum of 24" to provide a clean pavement edge for matching. No wheel cutting shall be allowed. Pavement shall be cut prior to paving to prevent damage to the cut edge.
- 16) The contractor shall be responsible for providing traffic control per the current edition of the US Department of Transportation Manual of Uniform Traffic Control Devices (MUTCD).
- 17) All drainage is to be retained on—site. Grade open areas to drain to Dry Wells as shown hereon.
- 18) Grade away from foundation at 2% minimum.
- 19) Alpine Enterprises Inc. is not responsible for any deviation from these plans, unless such changes have been authorized in writing.
- 20) All right-of-way improvements per sheet C1.0 must be completed prior to issuance of a temporary or final Certificate of Occupancy unless otherwise agreed upon in writing by the City.

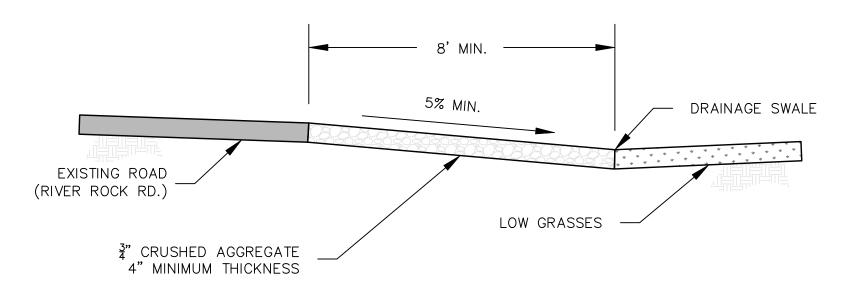

CROSS-SECTION: ROADSIDE SWALE R.O.W. RIVER ROCK ROAD NOT TO SCALE

NOTES

- A) Material shall be pervious/permeable to allow drainage.
- B) Surface must allow for vehicle parking and be consistent along the entire property frontage.
- C) Material within the first eight (8) feet from edge of asphalt (Street) shall be distinct from driveway and rest of property in order to visually appear available for parking.
- D) Grading and drainage improvements as required by City Engineer – Minimum 5% slope.
- E) No obstructions, such as boulders or berms.
- F) No buried irrigation systems within the first eight (8) feet the edge of asphalt (Street). Surface irrigation lines are permitted beyond the first eight (8) feet, however pop-up heads are not permitted anywhere in the ROW.
- G) No live plant material within the first eight (8) feet from edge of asphalt (Street). Low ground cover plant material, such as turf grass, is permitted beyond the first eight (8) feet. Drought-tolerant species are preferred.
- H) No snow-melt systems permitted within public right-of-way.

SLOPE VARIES 3" OF ASPHALT C4" OF 3/4" TYPE I AGGREGATE BASE 6" OF 2" TYPE II SUBBASE COMPACTED SUBGRADE


TYPICAL STREET ASPHALT SECTION


SLOPE VARIES 3" OF ASPHALT 4" OF 3/4" TYPE I AGGREGATE BASE 6" OF 2" TYPE II SUBBASE COMPACTED SUBGRADE

TYPICAL ALLEY ASPHALT SECTION

- 1. SUBBASE CAN BE 2" TYPE II OR 3/4" TYPE I CRUSHED AGGREGATE BASE COURSE.
- 2. MATERIALS SHALL CONFORM WITH CURRENT ISPWC STANDARDS, DIVISION 800 AGGREGATES AND ASPHALT.
- 3. PAVEMENT SECTION MAY BE MODIFIED IF A PROJECT SPECIFIC GEOTECHNICAL REPORT, STAMPED BY A
- TYPICAL ROAD SECTIONS CITY OF KETCHUM - SD-3 NOT TO SCALE

LICENSED ENGINEER, IS PROVIDED.

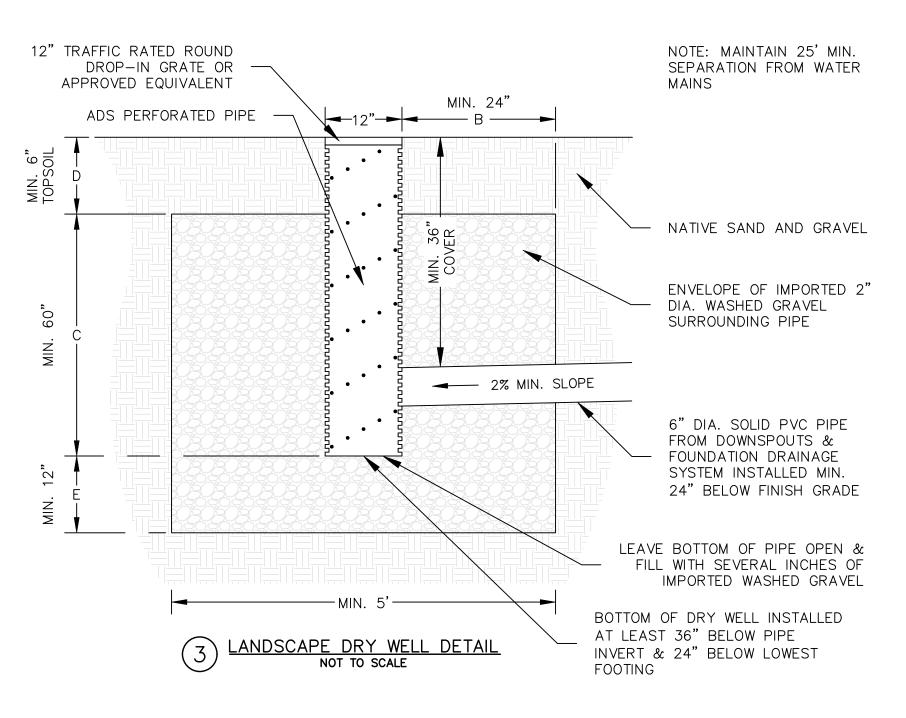

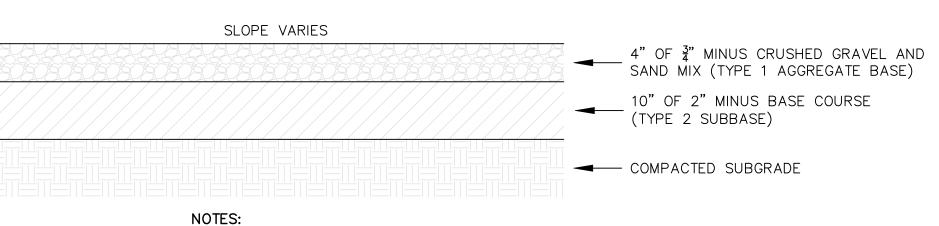


- 1. SUBBASE CAN BE 2" TYPE II OR 3/4" TYPE I CRUSHED AGGREGATE BASE COURSE.
- 2. MATERIALS SHALL CONFORM WITH CURRENT ISPWC STANDARDS, DIVISION 800 AGGREGATES AND ASPHALT.
 - TYPICAL GRAVEL SECTION NOT TO SCALE

SHOWING ISION NO. BLAINE COL AINE PLAN BDIVIS IMPROVEMENT F
G WOOD SUE
CITY OF KETCH
TLEY RESIDENCE WAY IN BIG

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12023.dwg 08/08 - Interprises lapping, Civil Engine ral Hazards Consult so Bell Dr., Unit 1 to Retchum, ID 83340 - 1988



Hartley Residence

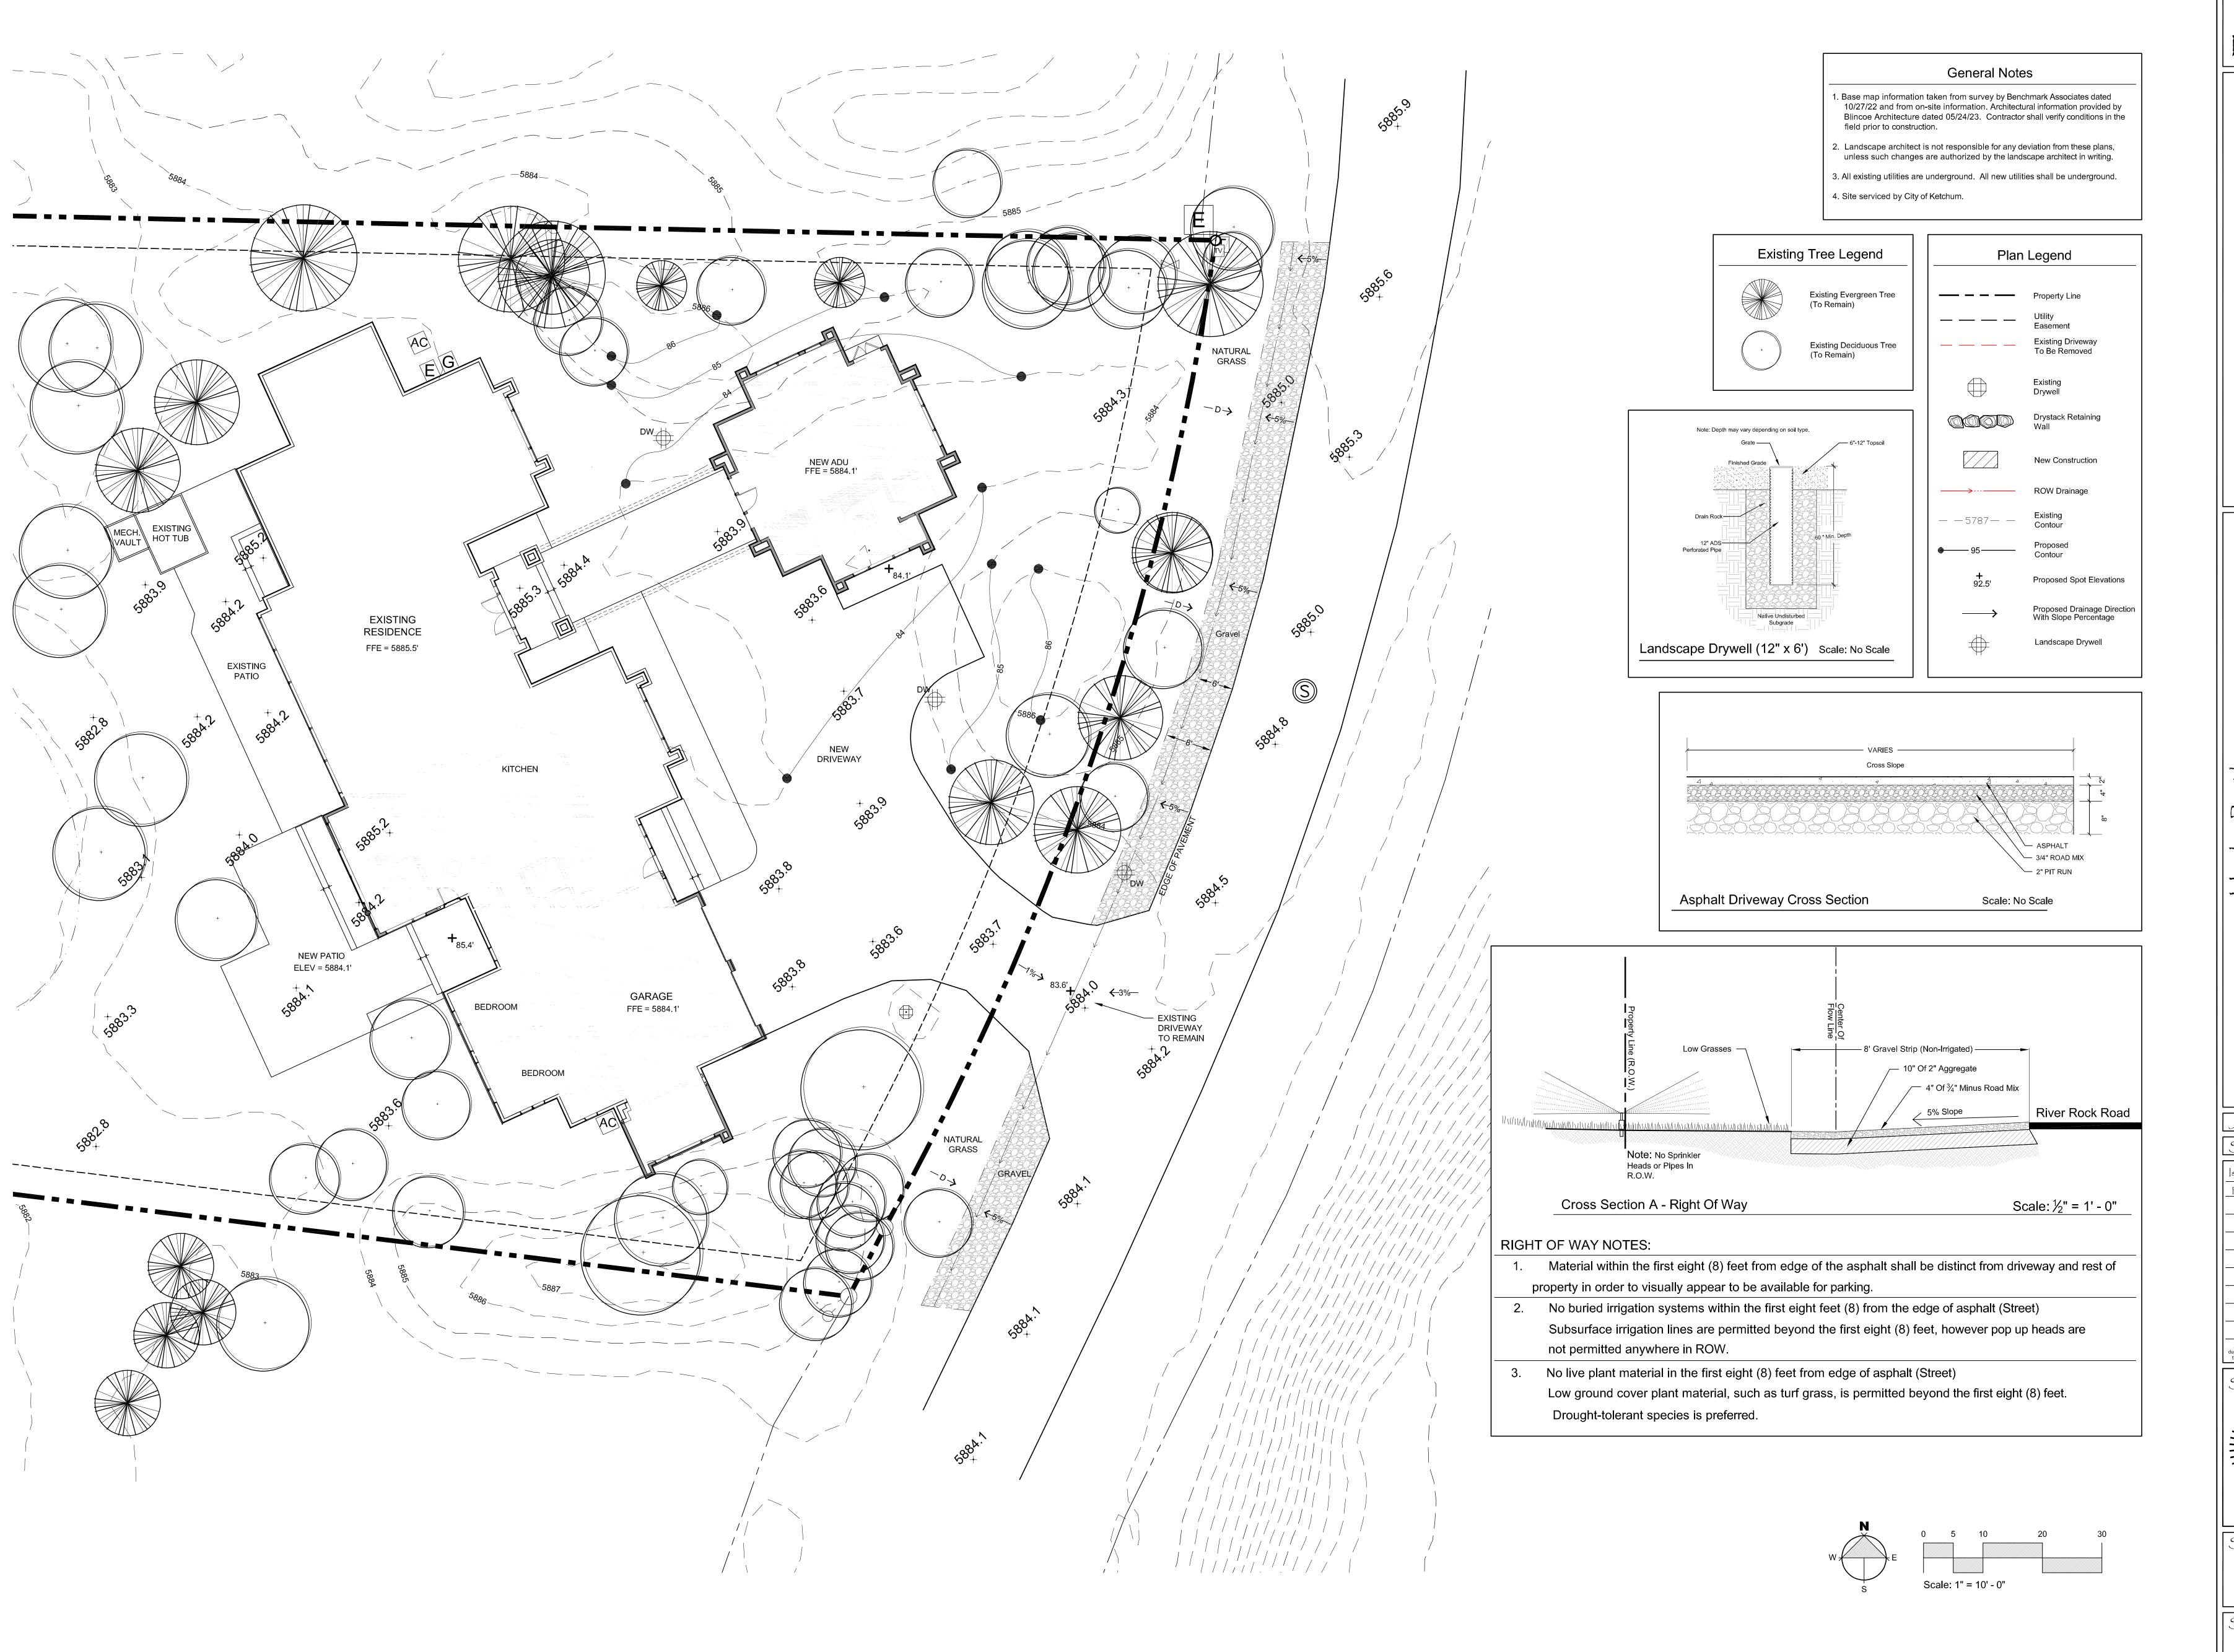GGERS ASSOCIATES, P.A.

[landscape architecture]

Box 953

T(208) 725

130 River Rock Road Bigwood Sub 1 - Block 1 Lot 1 Ketchum, Idaho

Job No: 23.03

Scale: 1"=10'-0"

Issue/Revisions: Date:
Permit Set 08/03/2

All information appearing herein shall not be duplicated, discharged or otherwise used with the written consent of Eggers Associates P

Sheet Title:

Plan
Sheet No:






Permit Set - 08/03/23

Residence


Job No: 23.03 Scale: 1"=10'-0" Issue/Revisions: Date:

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Sheet Title: Demo Plan

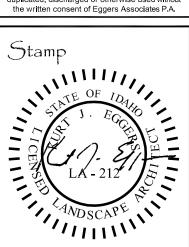Sheet No:



Permit Set - 08/03/23

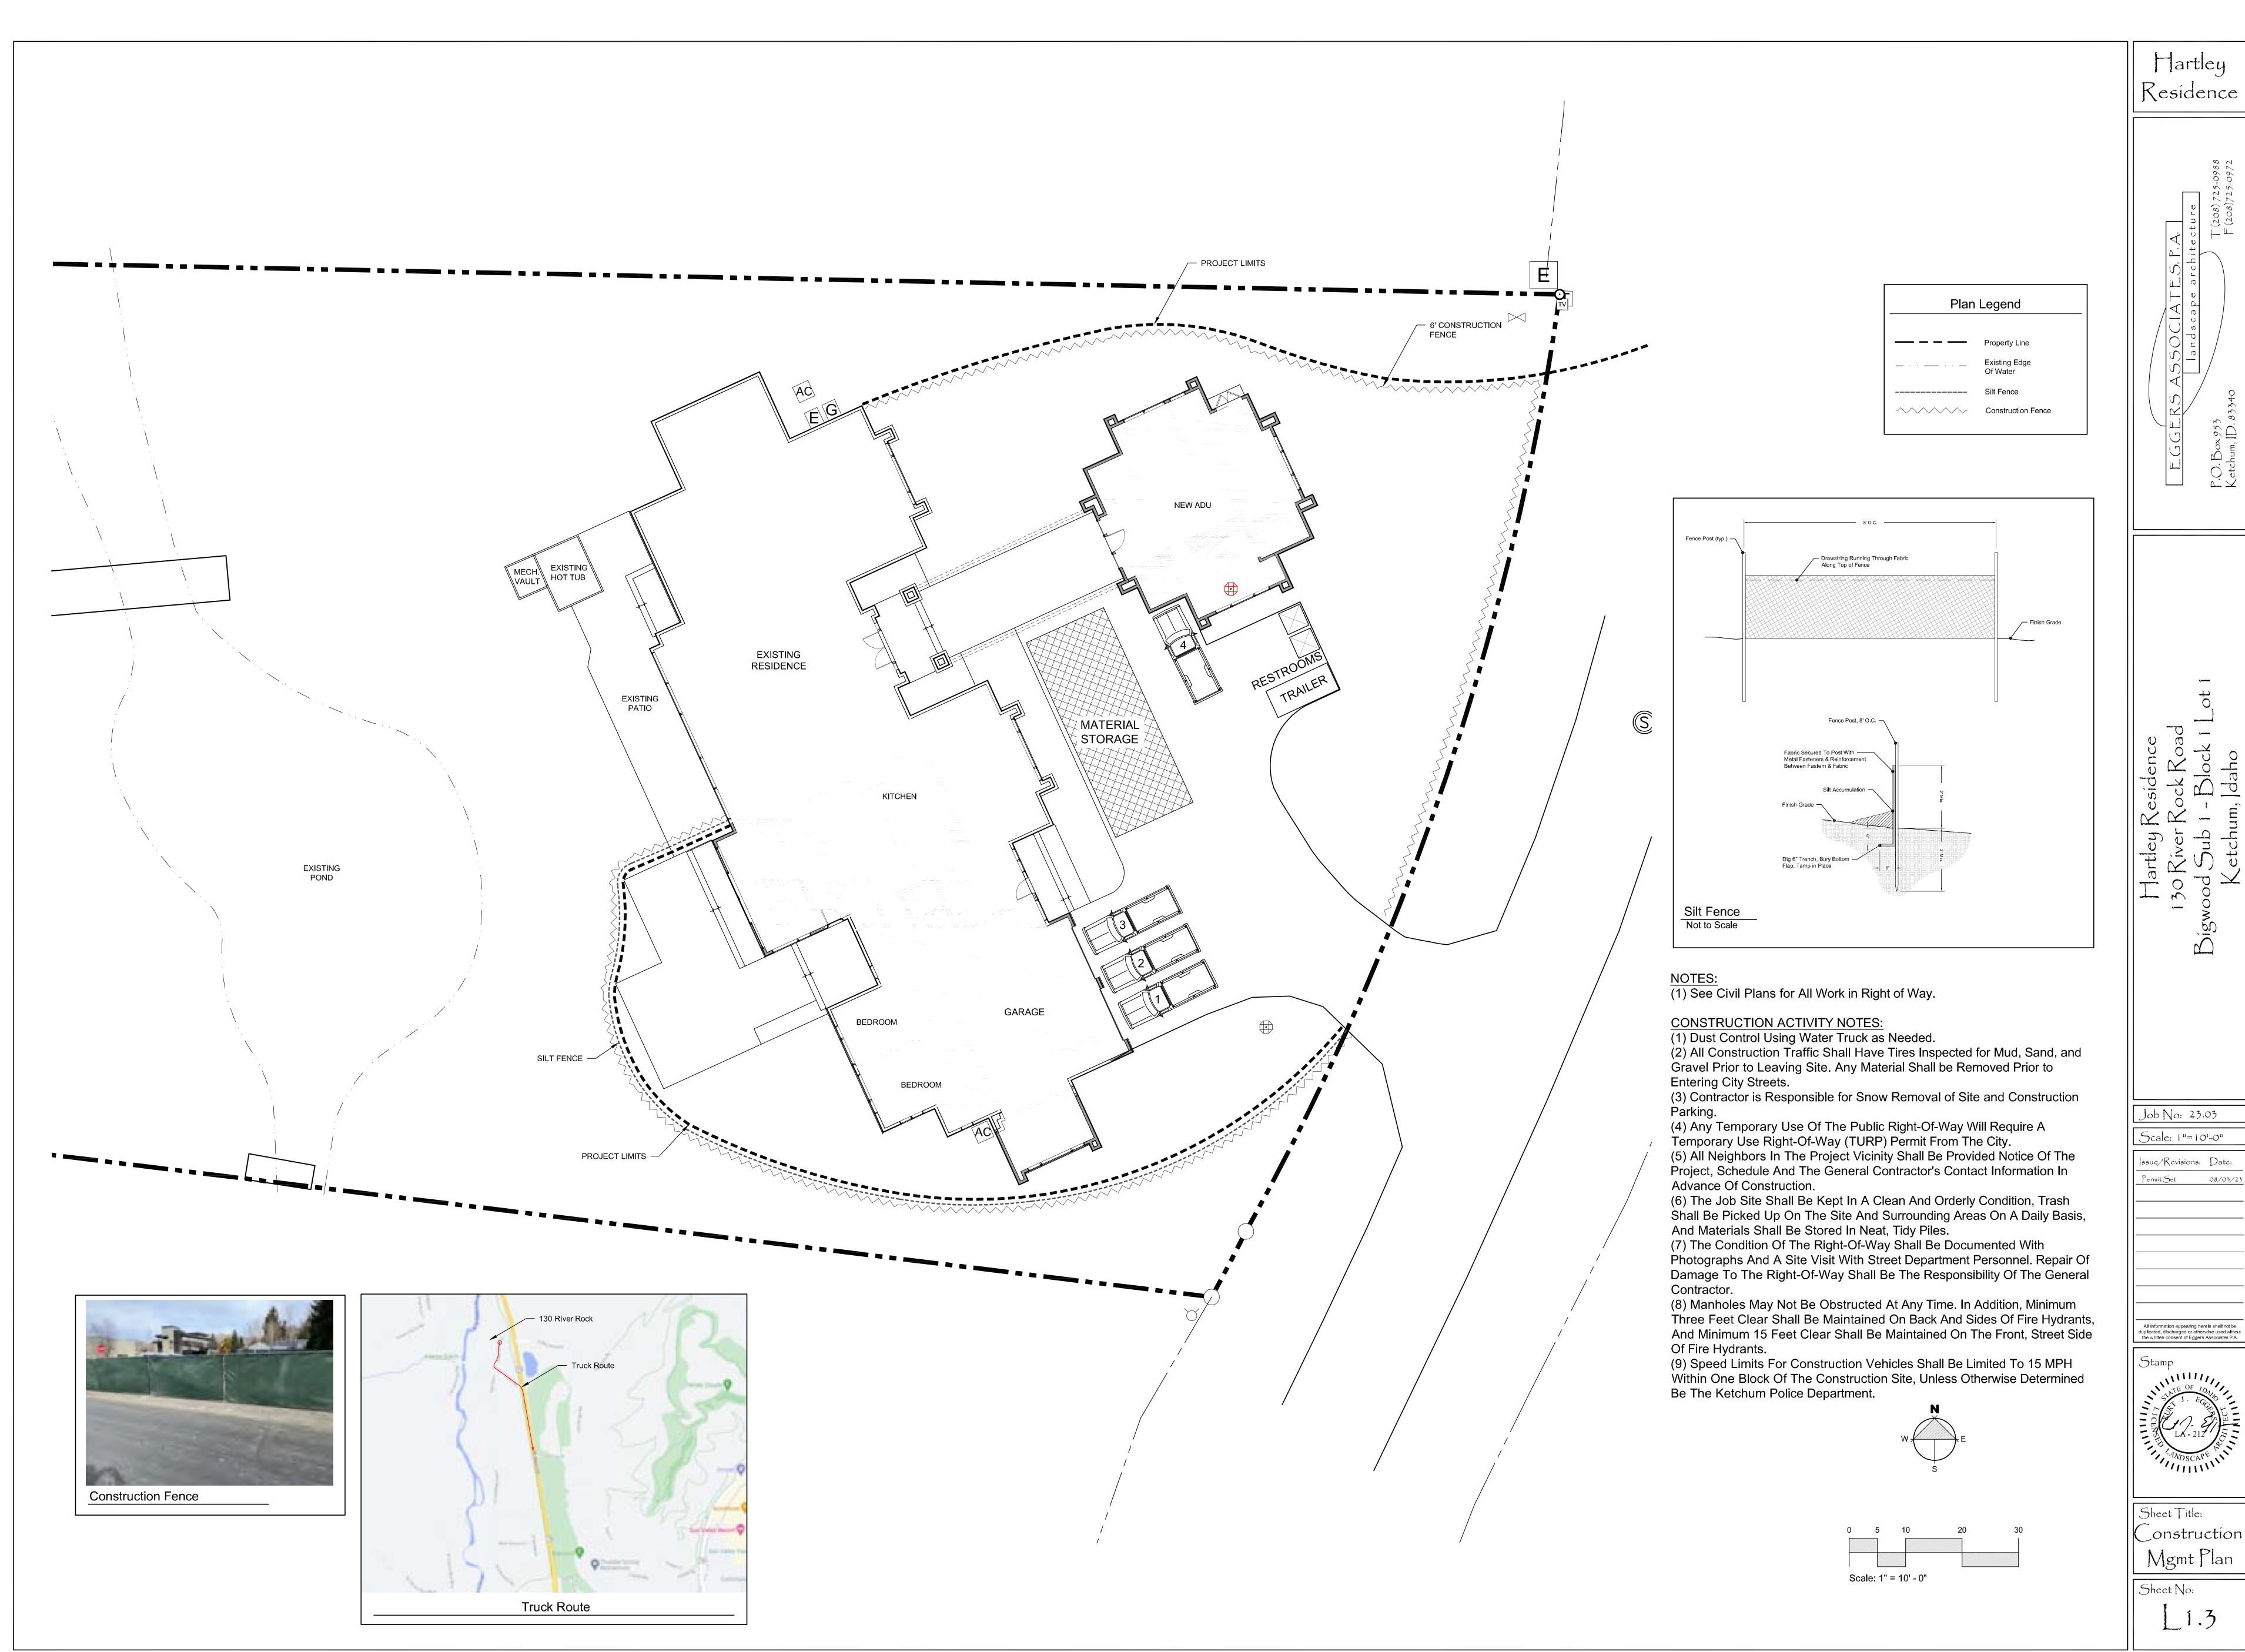

Plan Legend

Property Line

Building
Envelope

Existing
Contour

Existing
Easements


Floodway
Per FEMA 2010

FP 100 Year Floodplain
Per FEMA 2010


Irrigation
Canal
25' Water
Setback

Zoning: CITY
Max. Lot Coverage: 35%
Setbacks:
Front: 25 Feet
Side: 15 Feet
Rear: 15 Feet
Total Parcel
Area: 127,631 ft²

Building
Footprints: 6,567 ft²
(5% of Site)

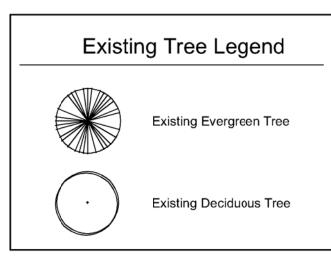

Aerial Imagery: Blaine County GIS 2022

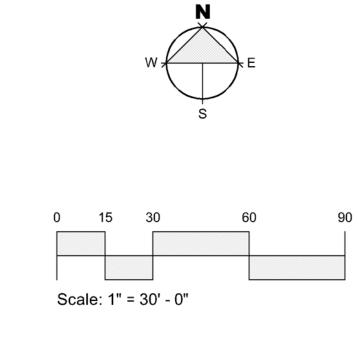

Hartley Residence

130 River Rock Road Bigwood Sub 1 - Block 1 Lot 1 Ketchum, Idaho

Job No: 23.03

Scale: 1"=30'-0"

| Issue/Revisions: Date: | Permit Set | 08/03/23

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Stamp

LA-212

LA-212


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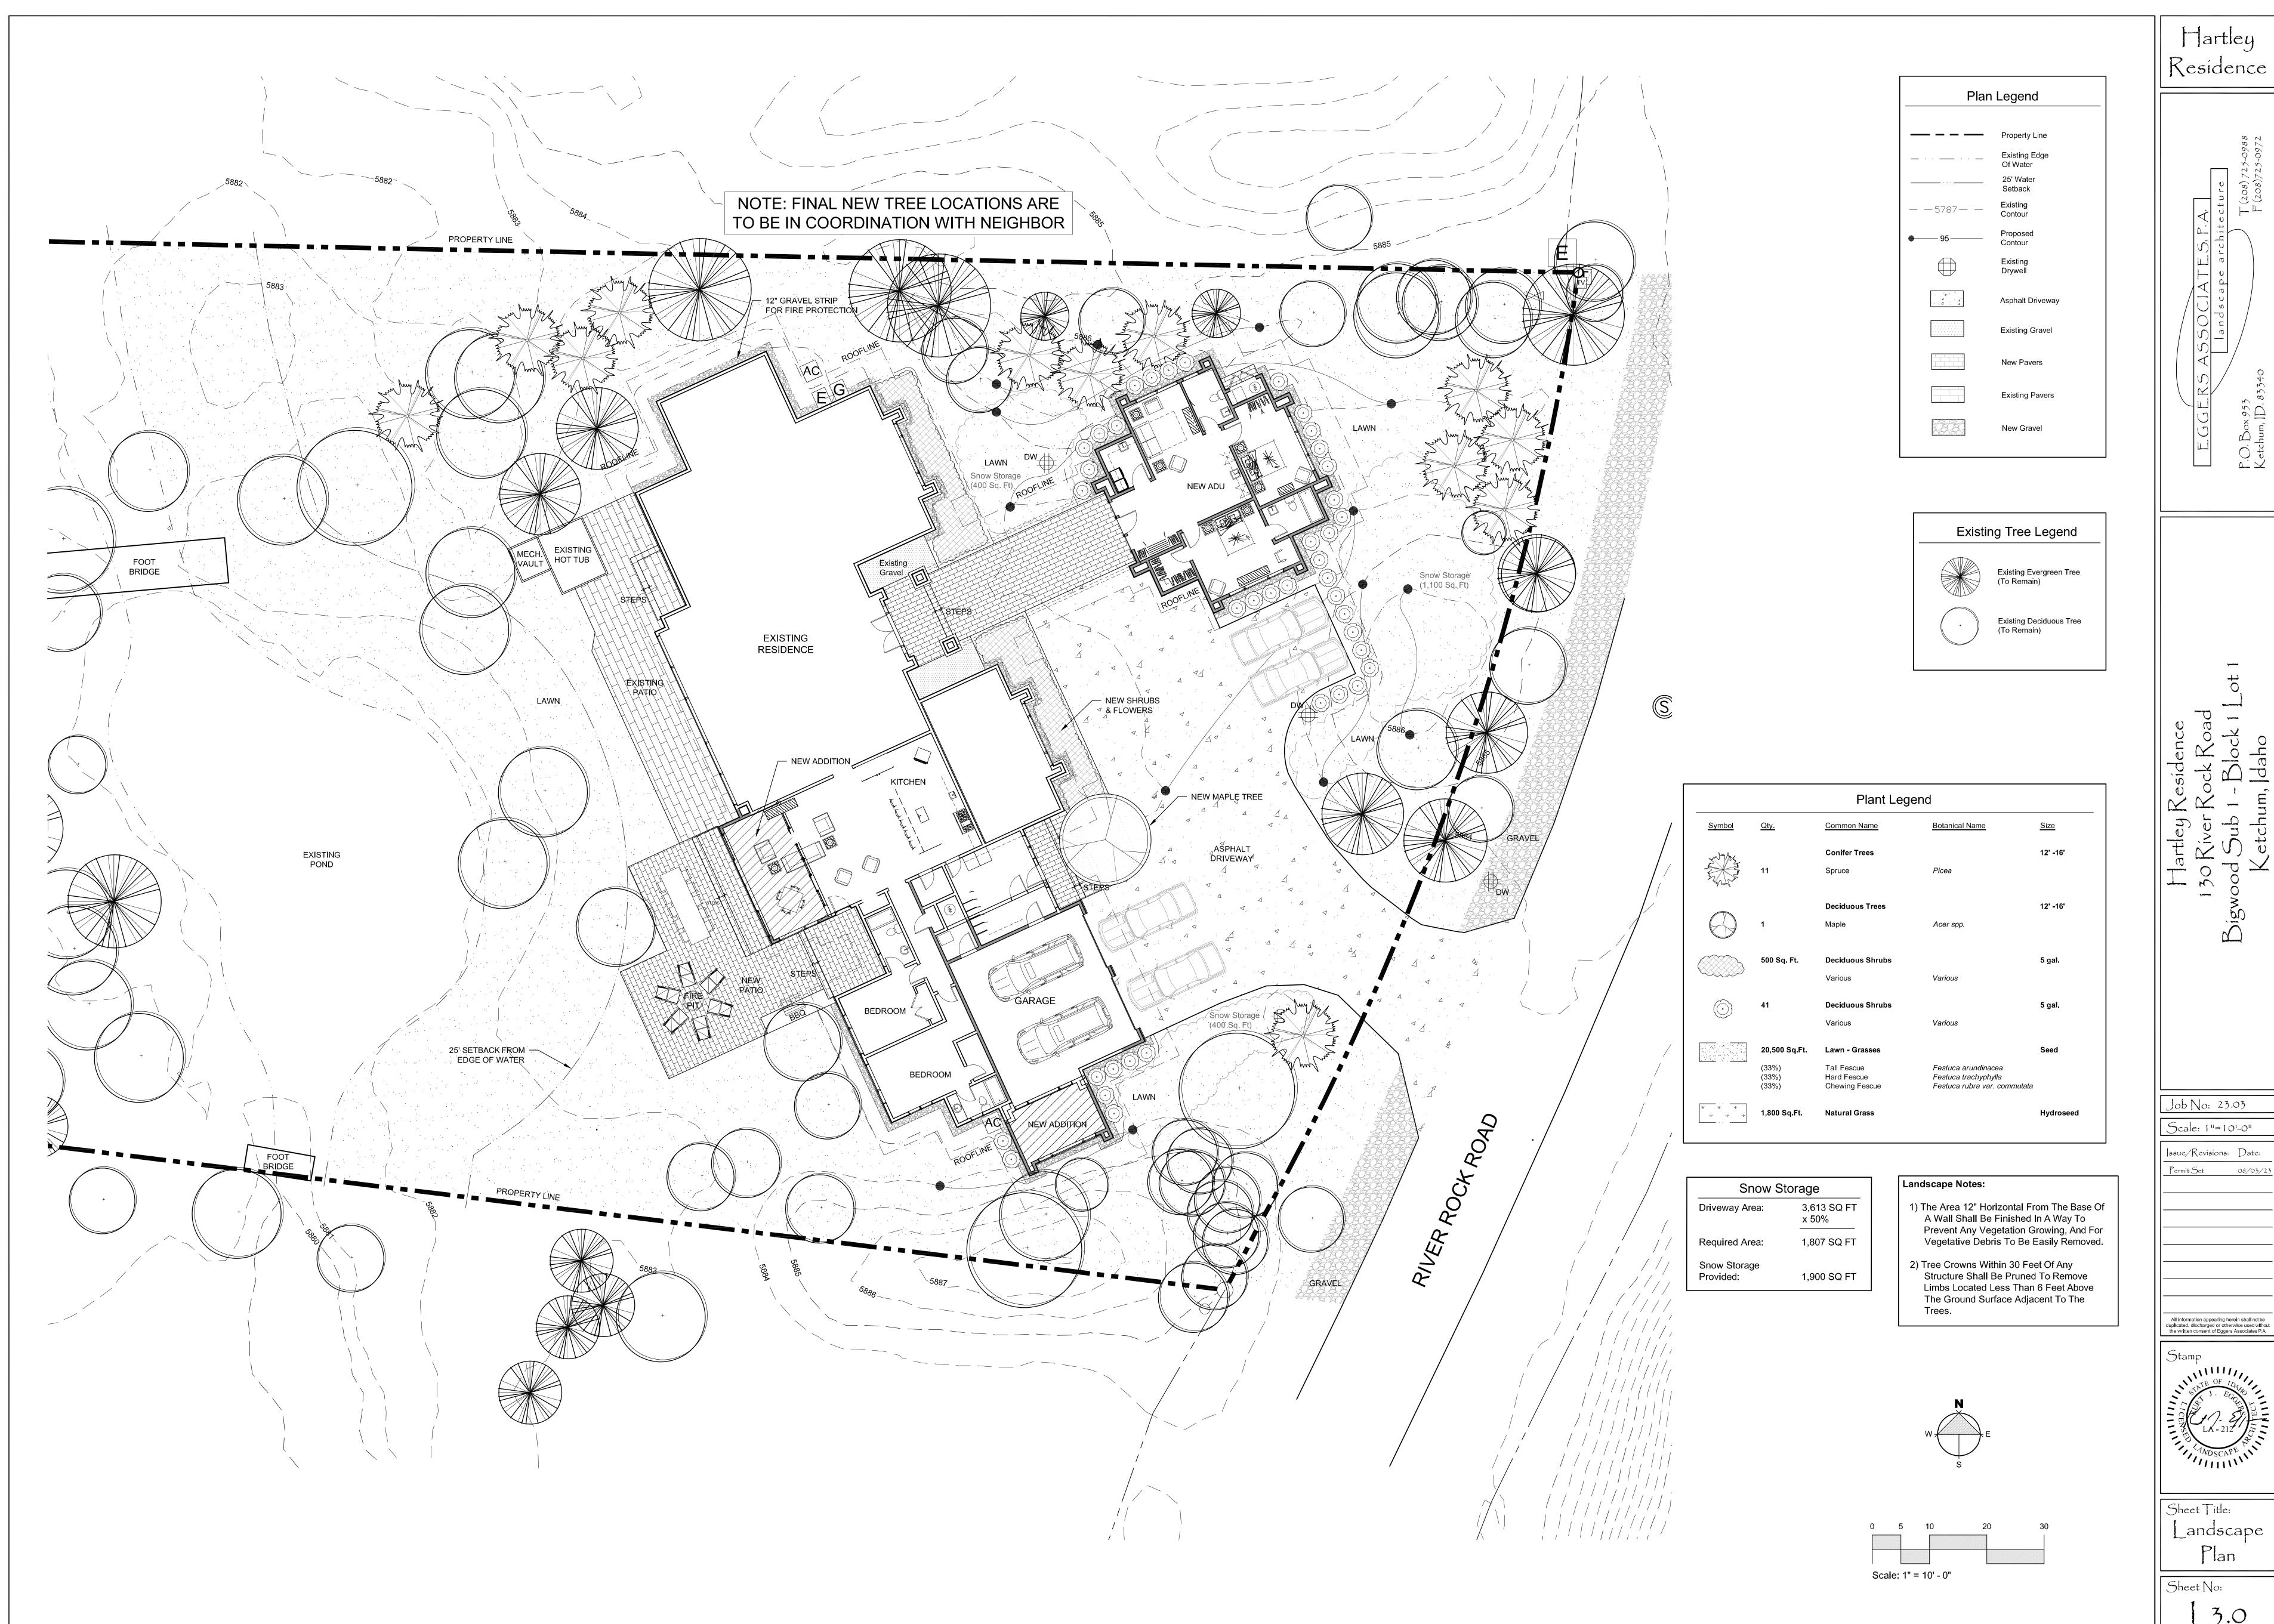
Sheet Title:

Existing

Conditions

Sheet No:



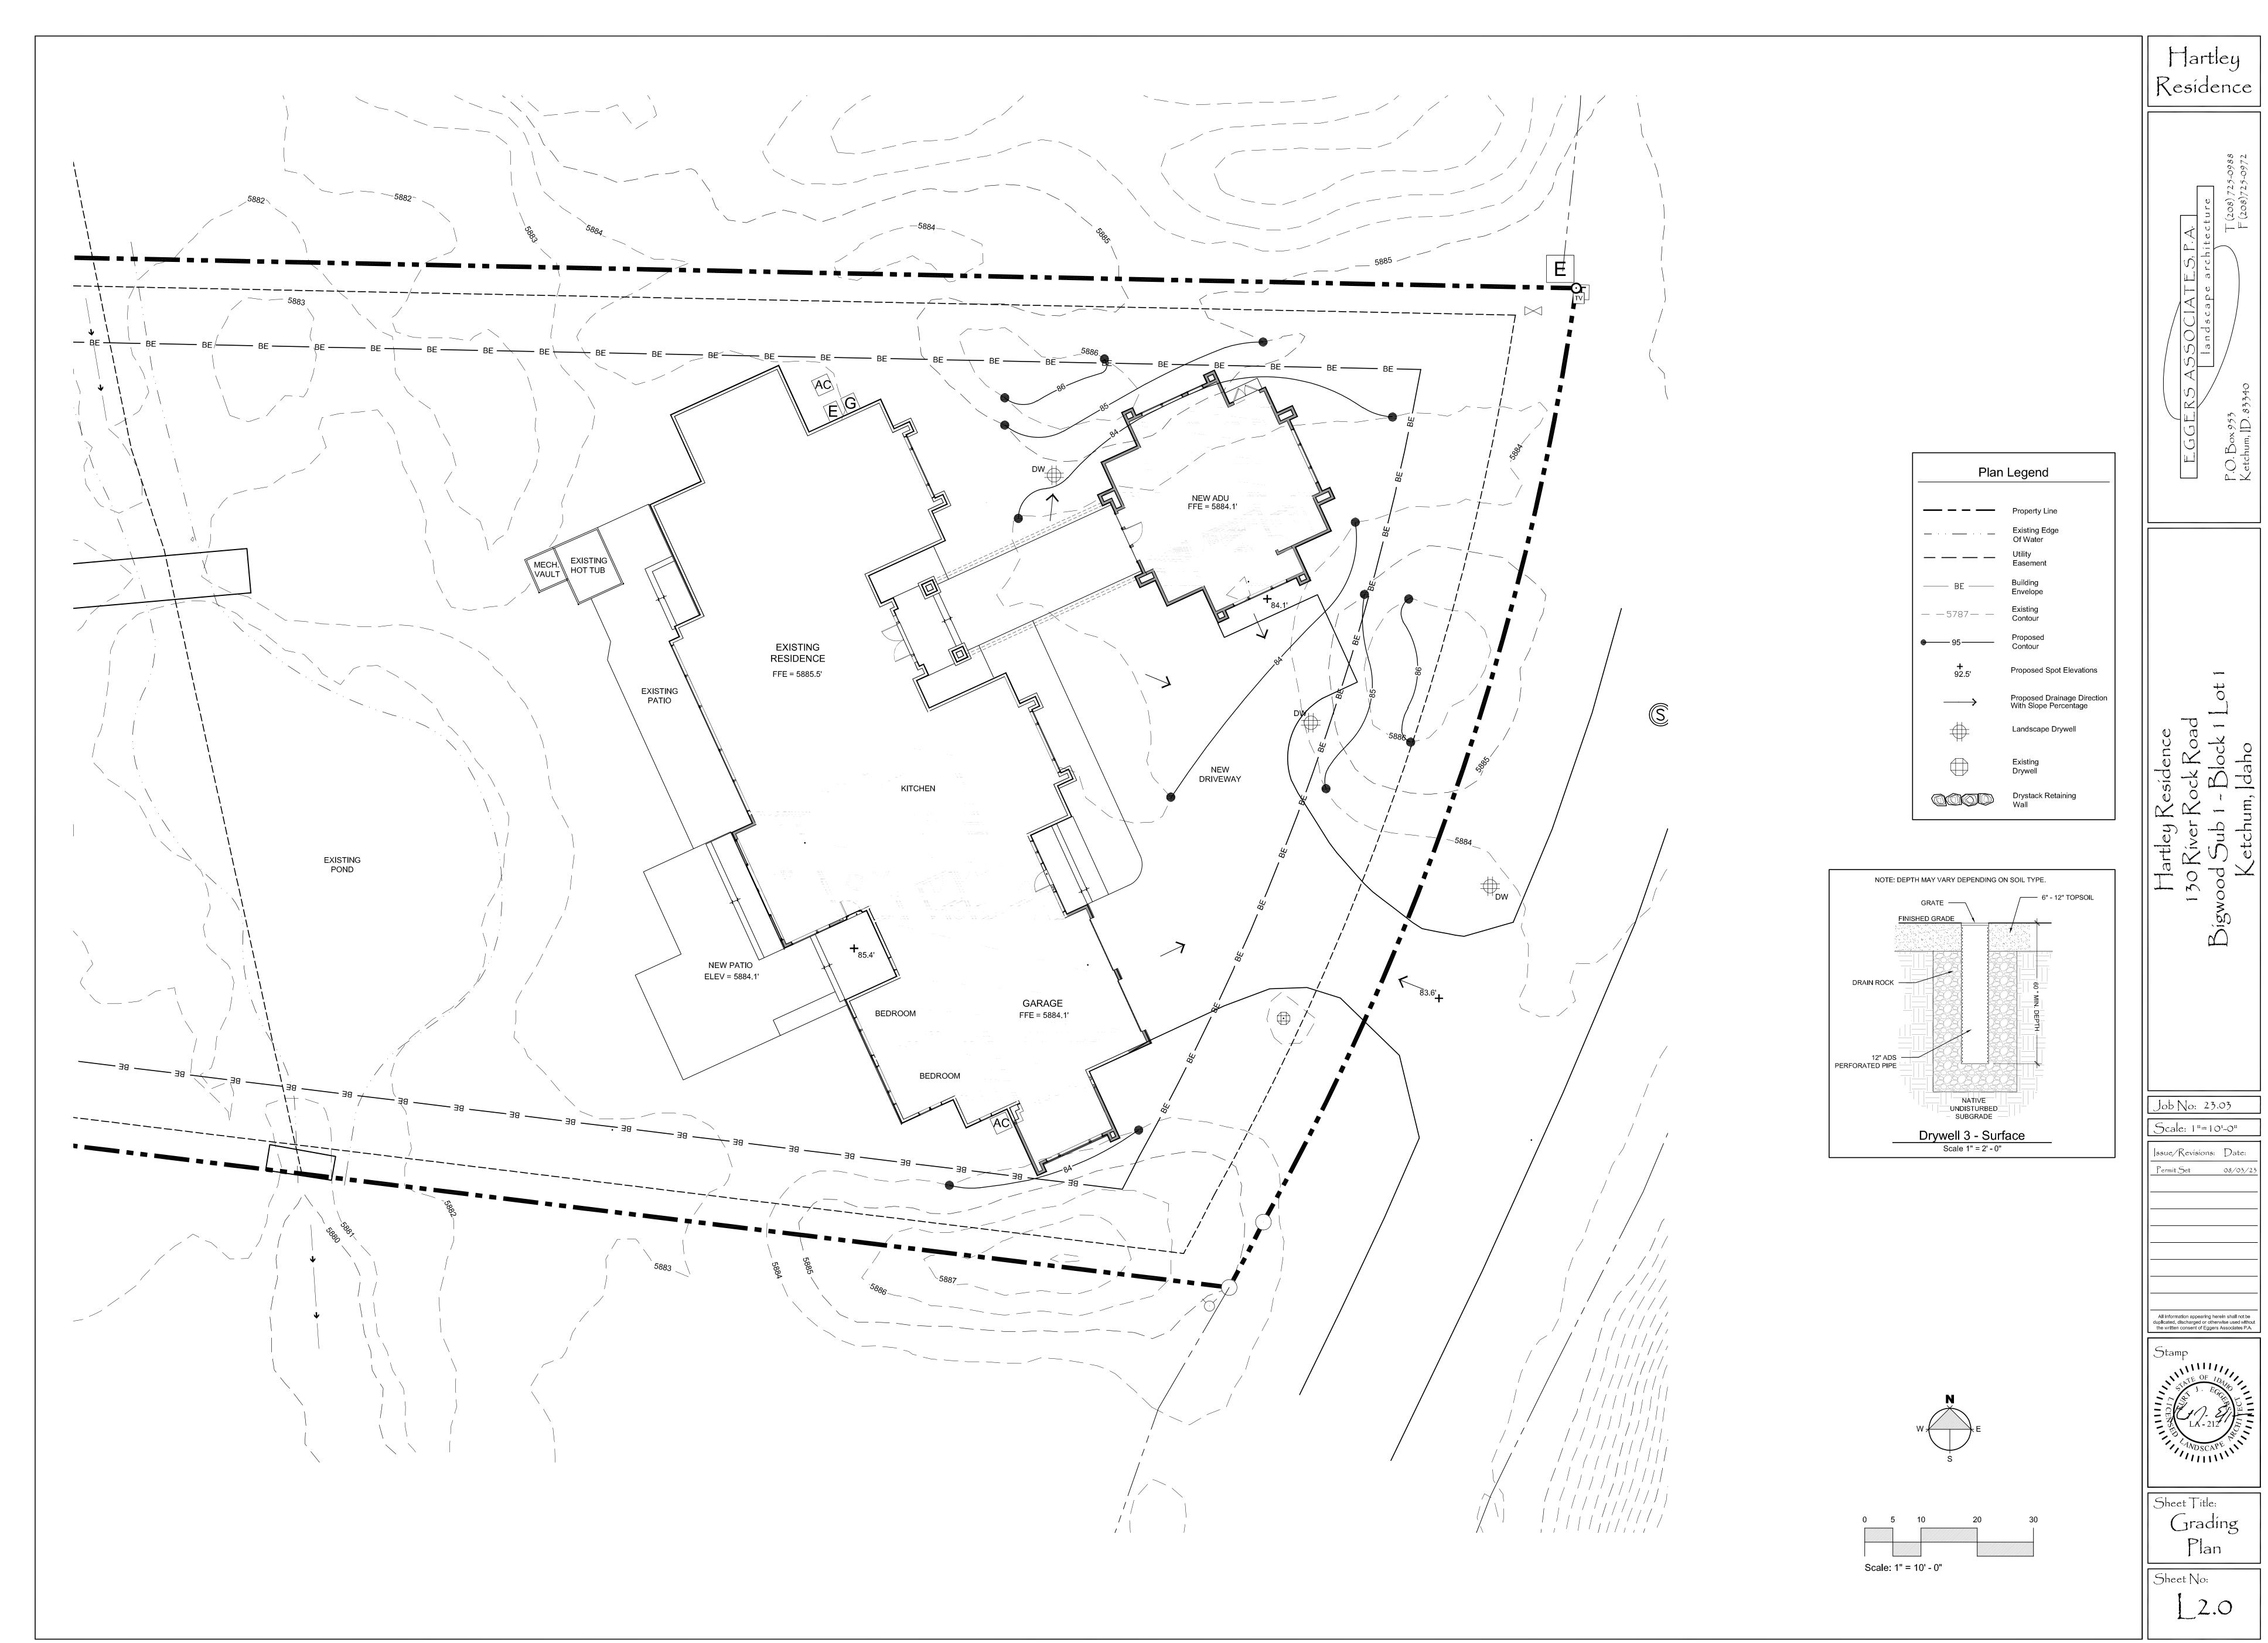

Permit Set - 08/03/23

Hartley


Job No: 23.03


Scale: 1"=10'-0" Issue/Revisions: Date: Permit Set

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Sheet Title: Landscape Plan

Sheet No: L3.0



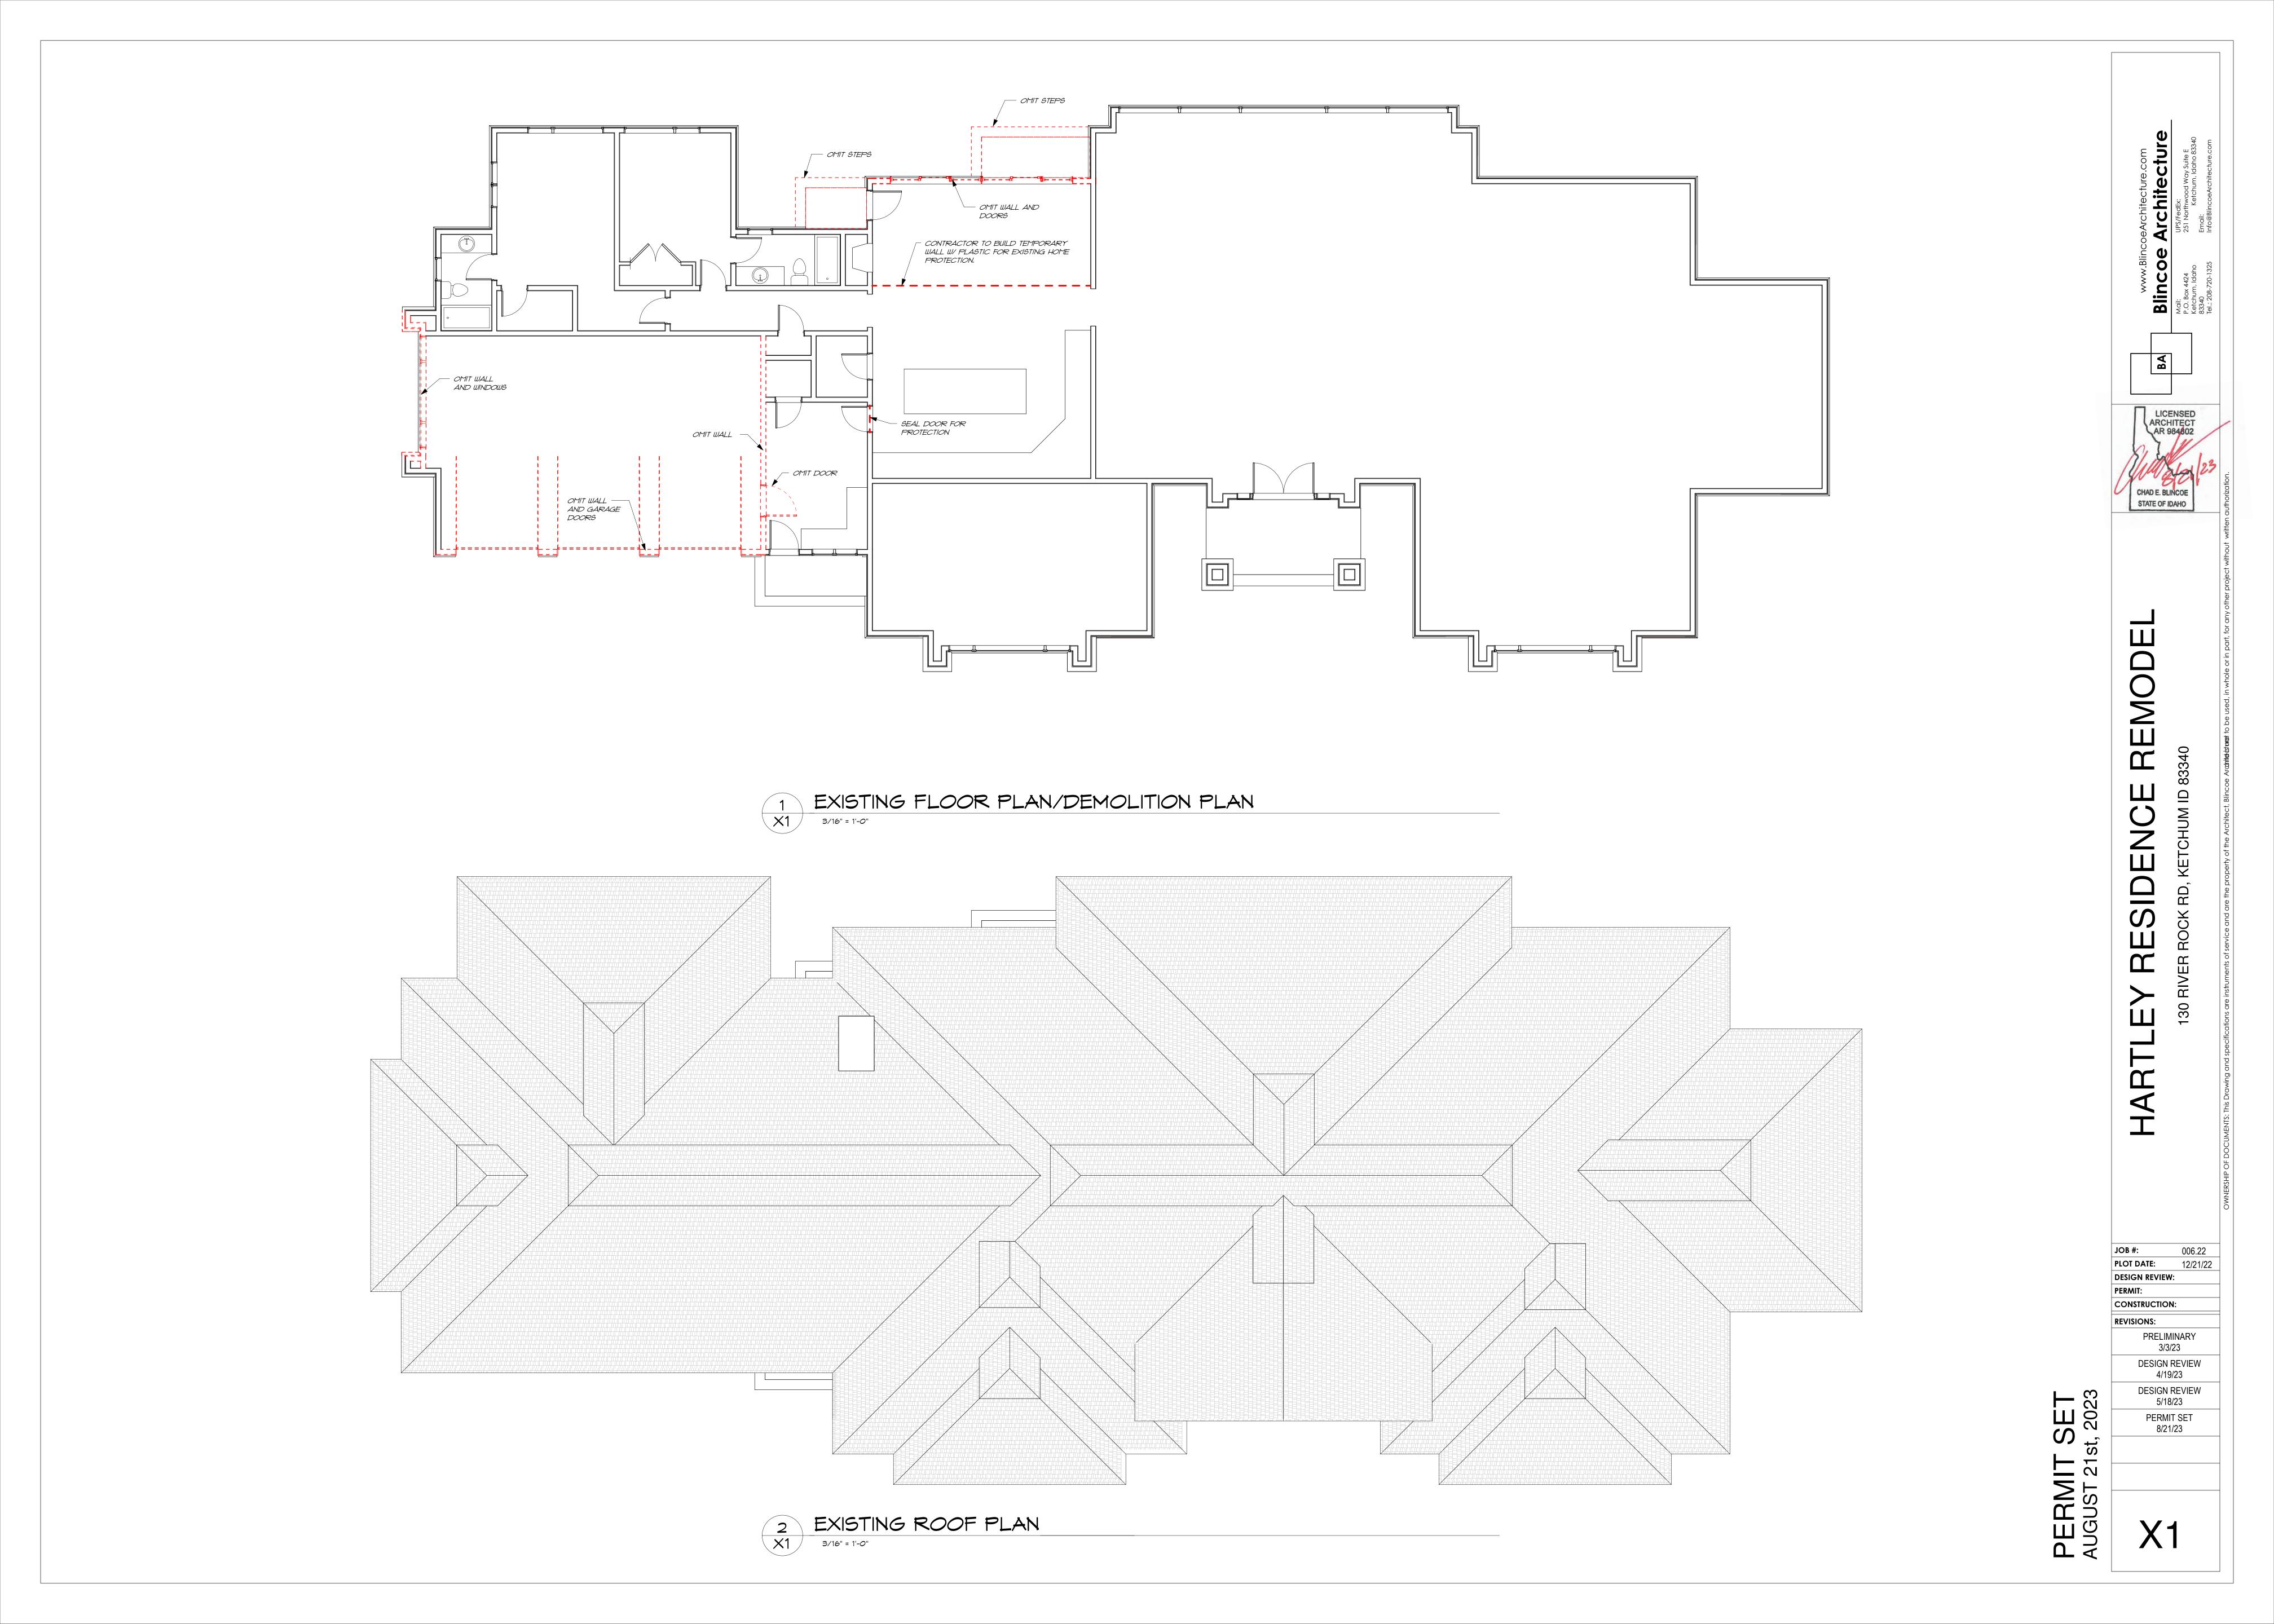

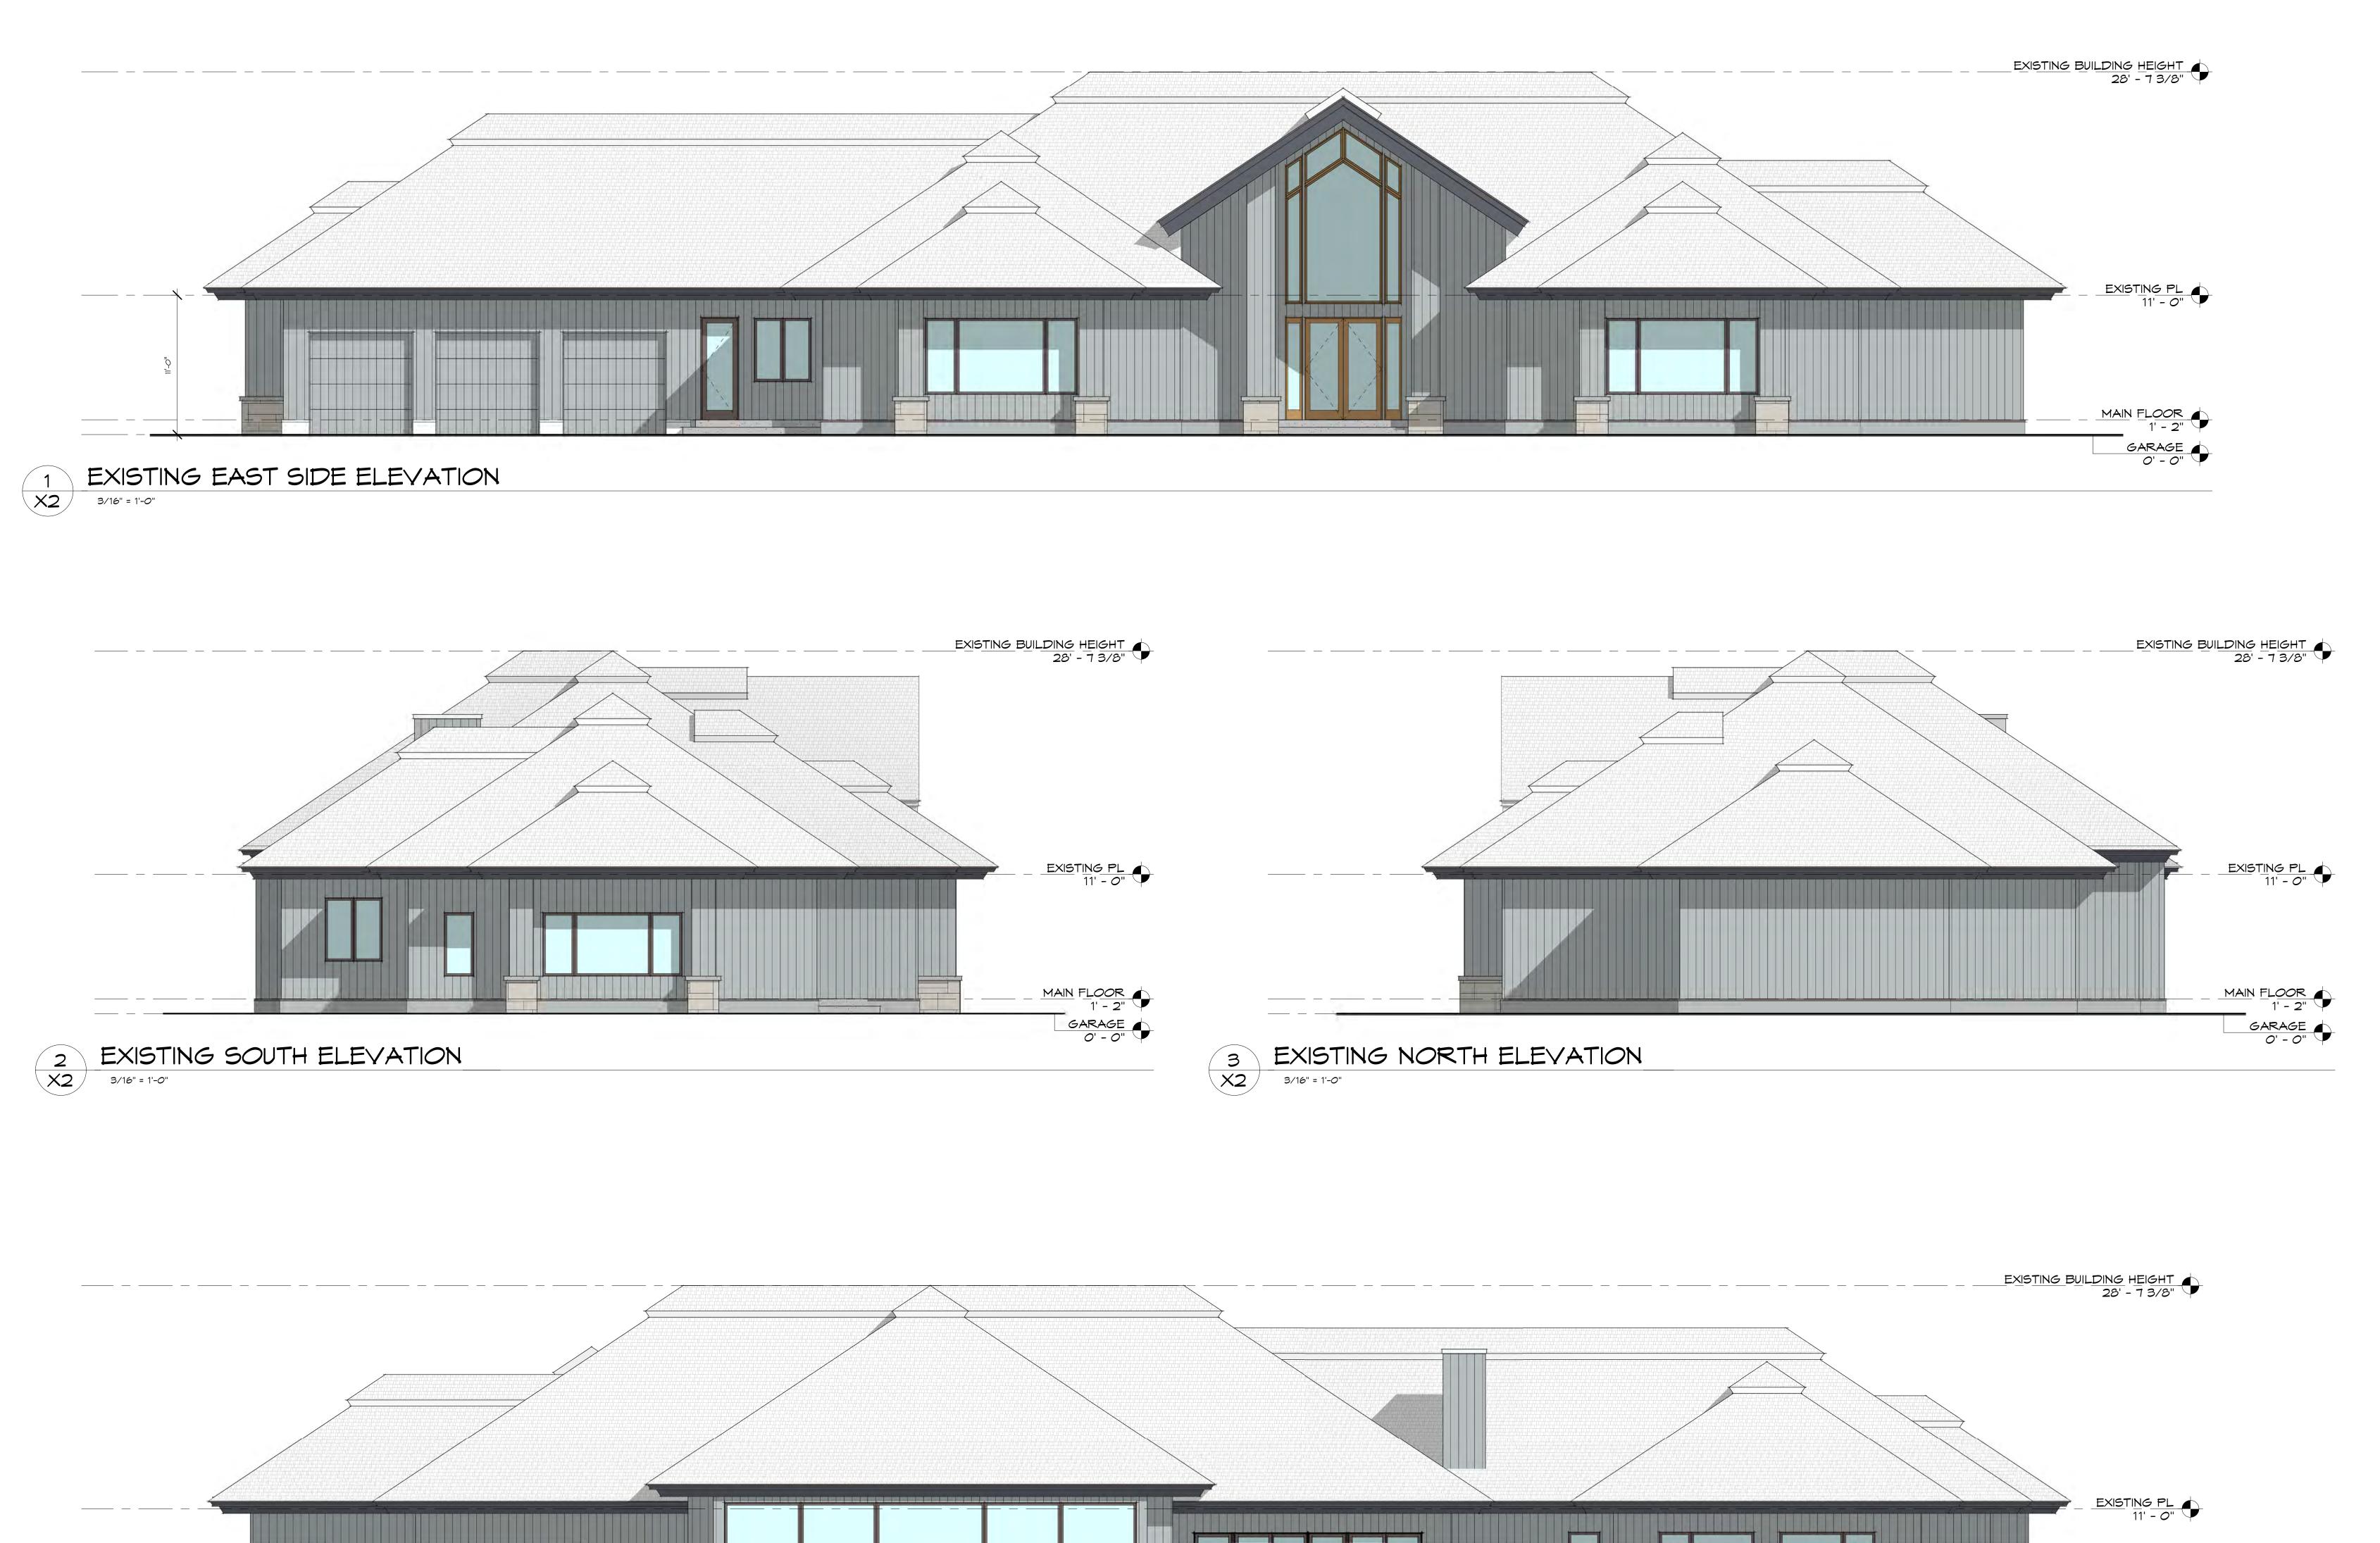4 EXISTING WEST ELEVATION
X2 3/16" = 1'-0"

PERMIT SET AUGUST 21st, 2023

MAIN FLOOR 1' - 2"

GARAGE 0' - 0"

X2

PLOT DATE:

REVISIONS:

DESIGN REVIEW:

CONSTRUCTION:


PRELIMINARY 3/3/23


DESIGN REVIEW 4/19/23


DESIGN REVIEW 5/18/23

PERMIT SET 8/21/23

006.22 12/21/22

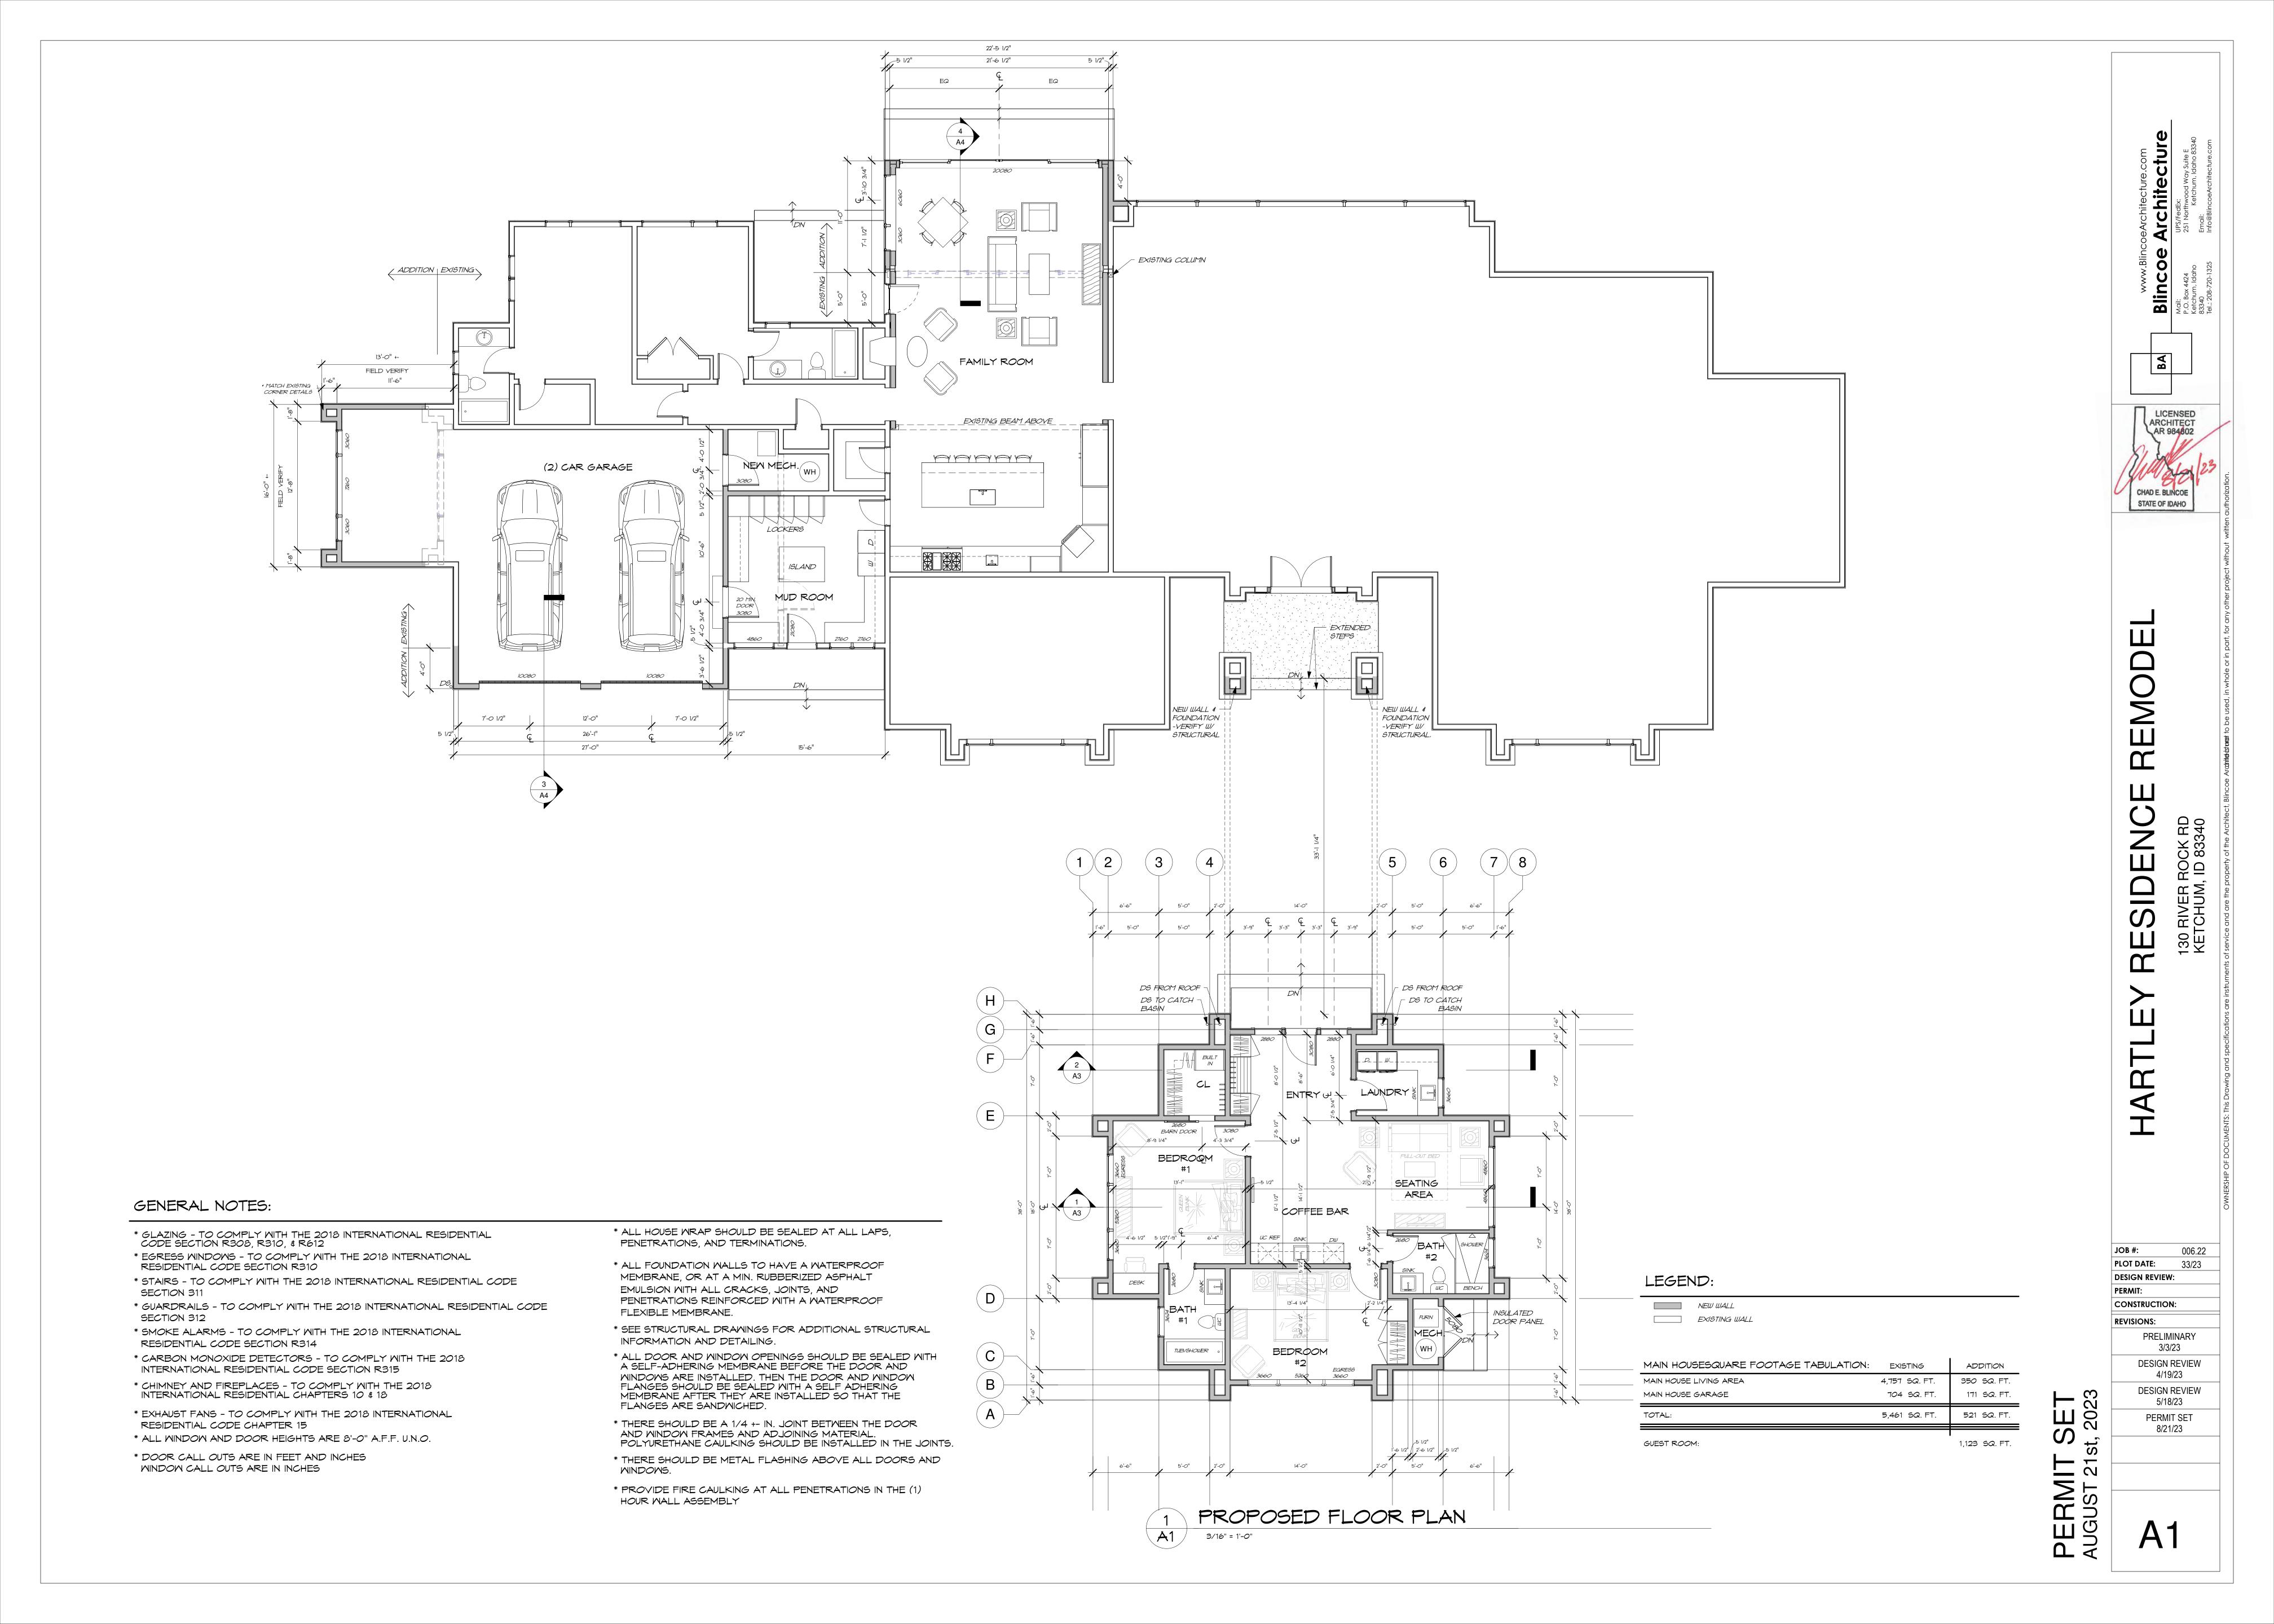

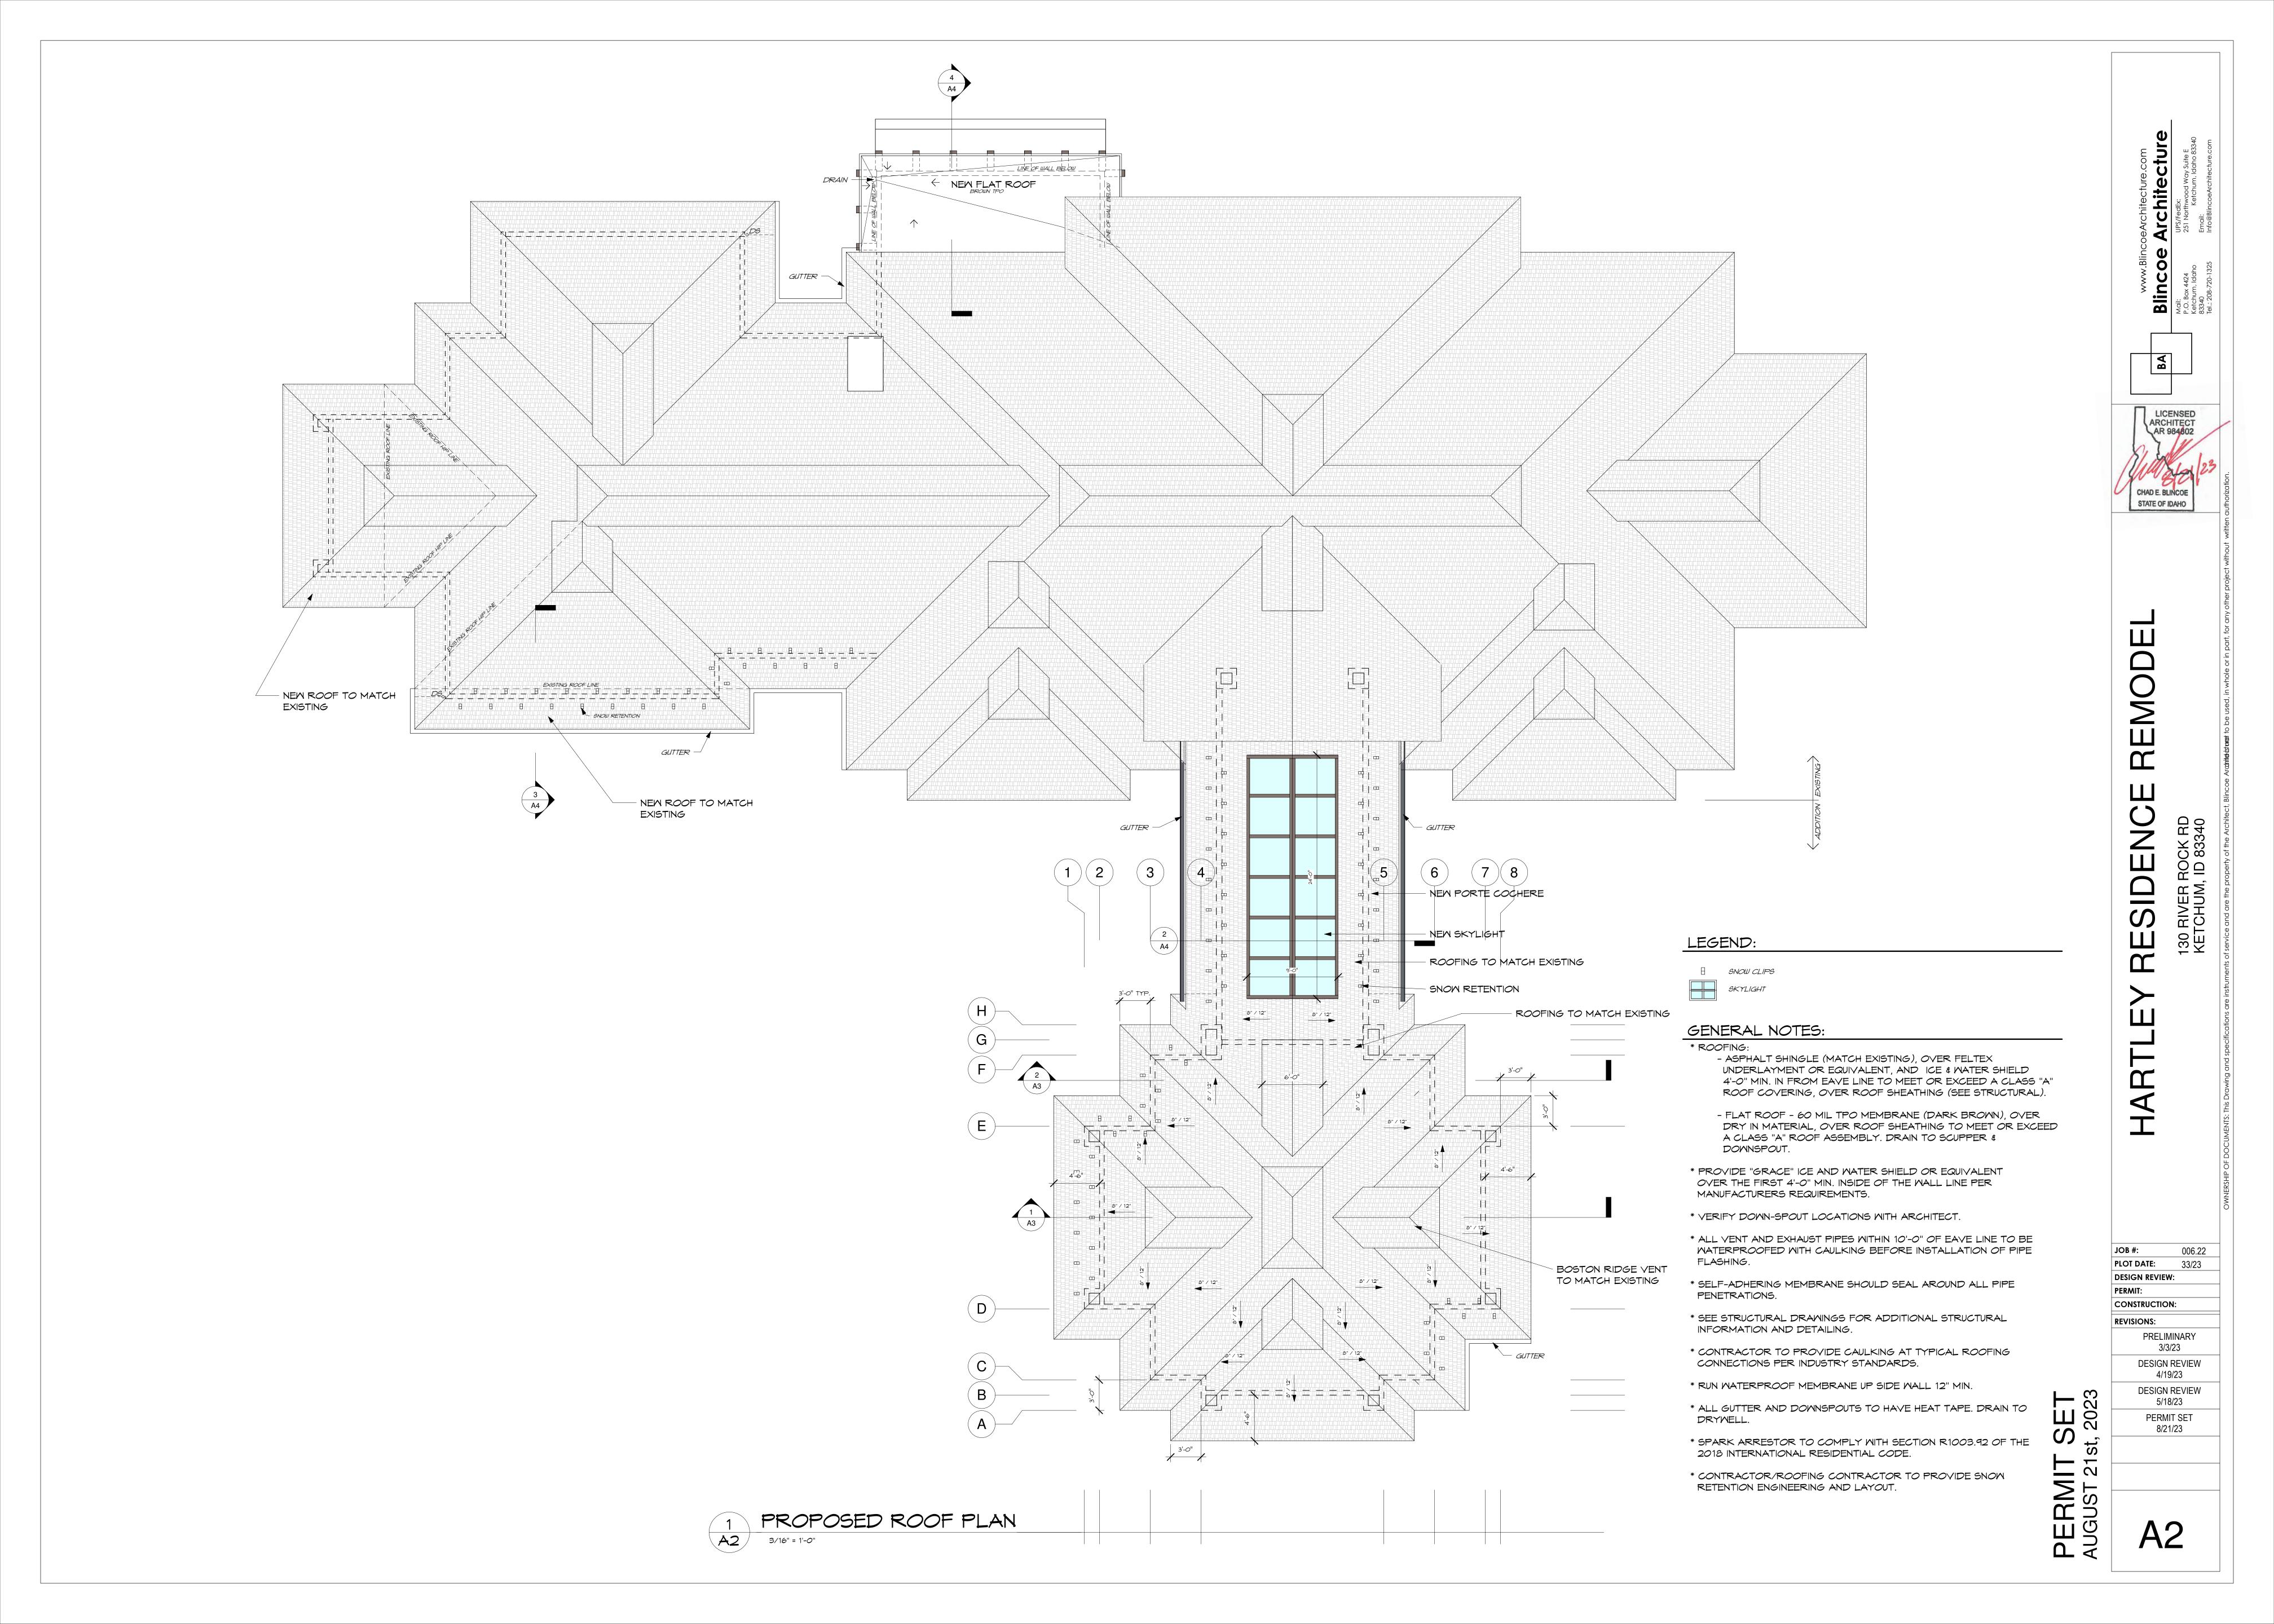

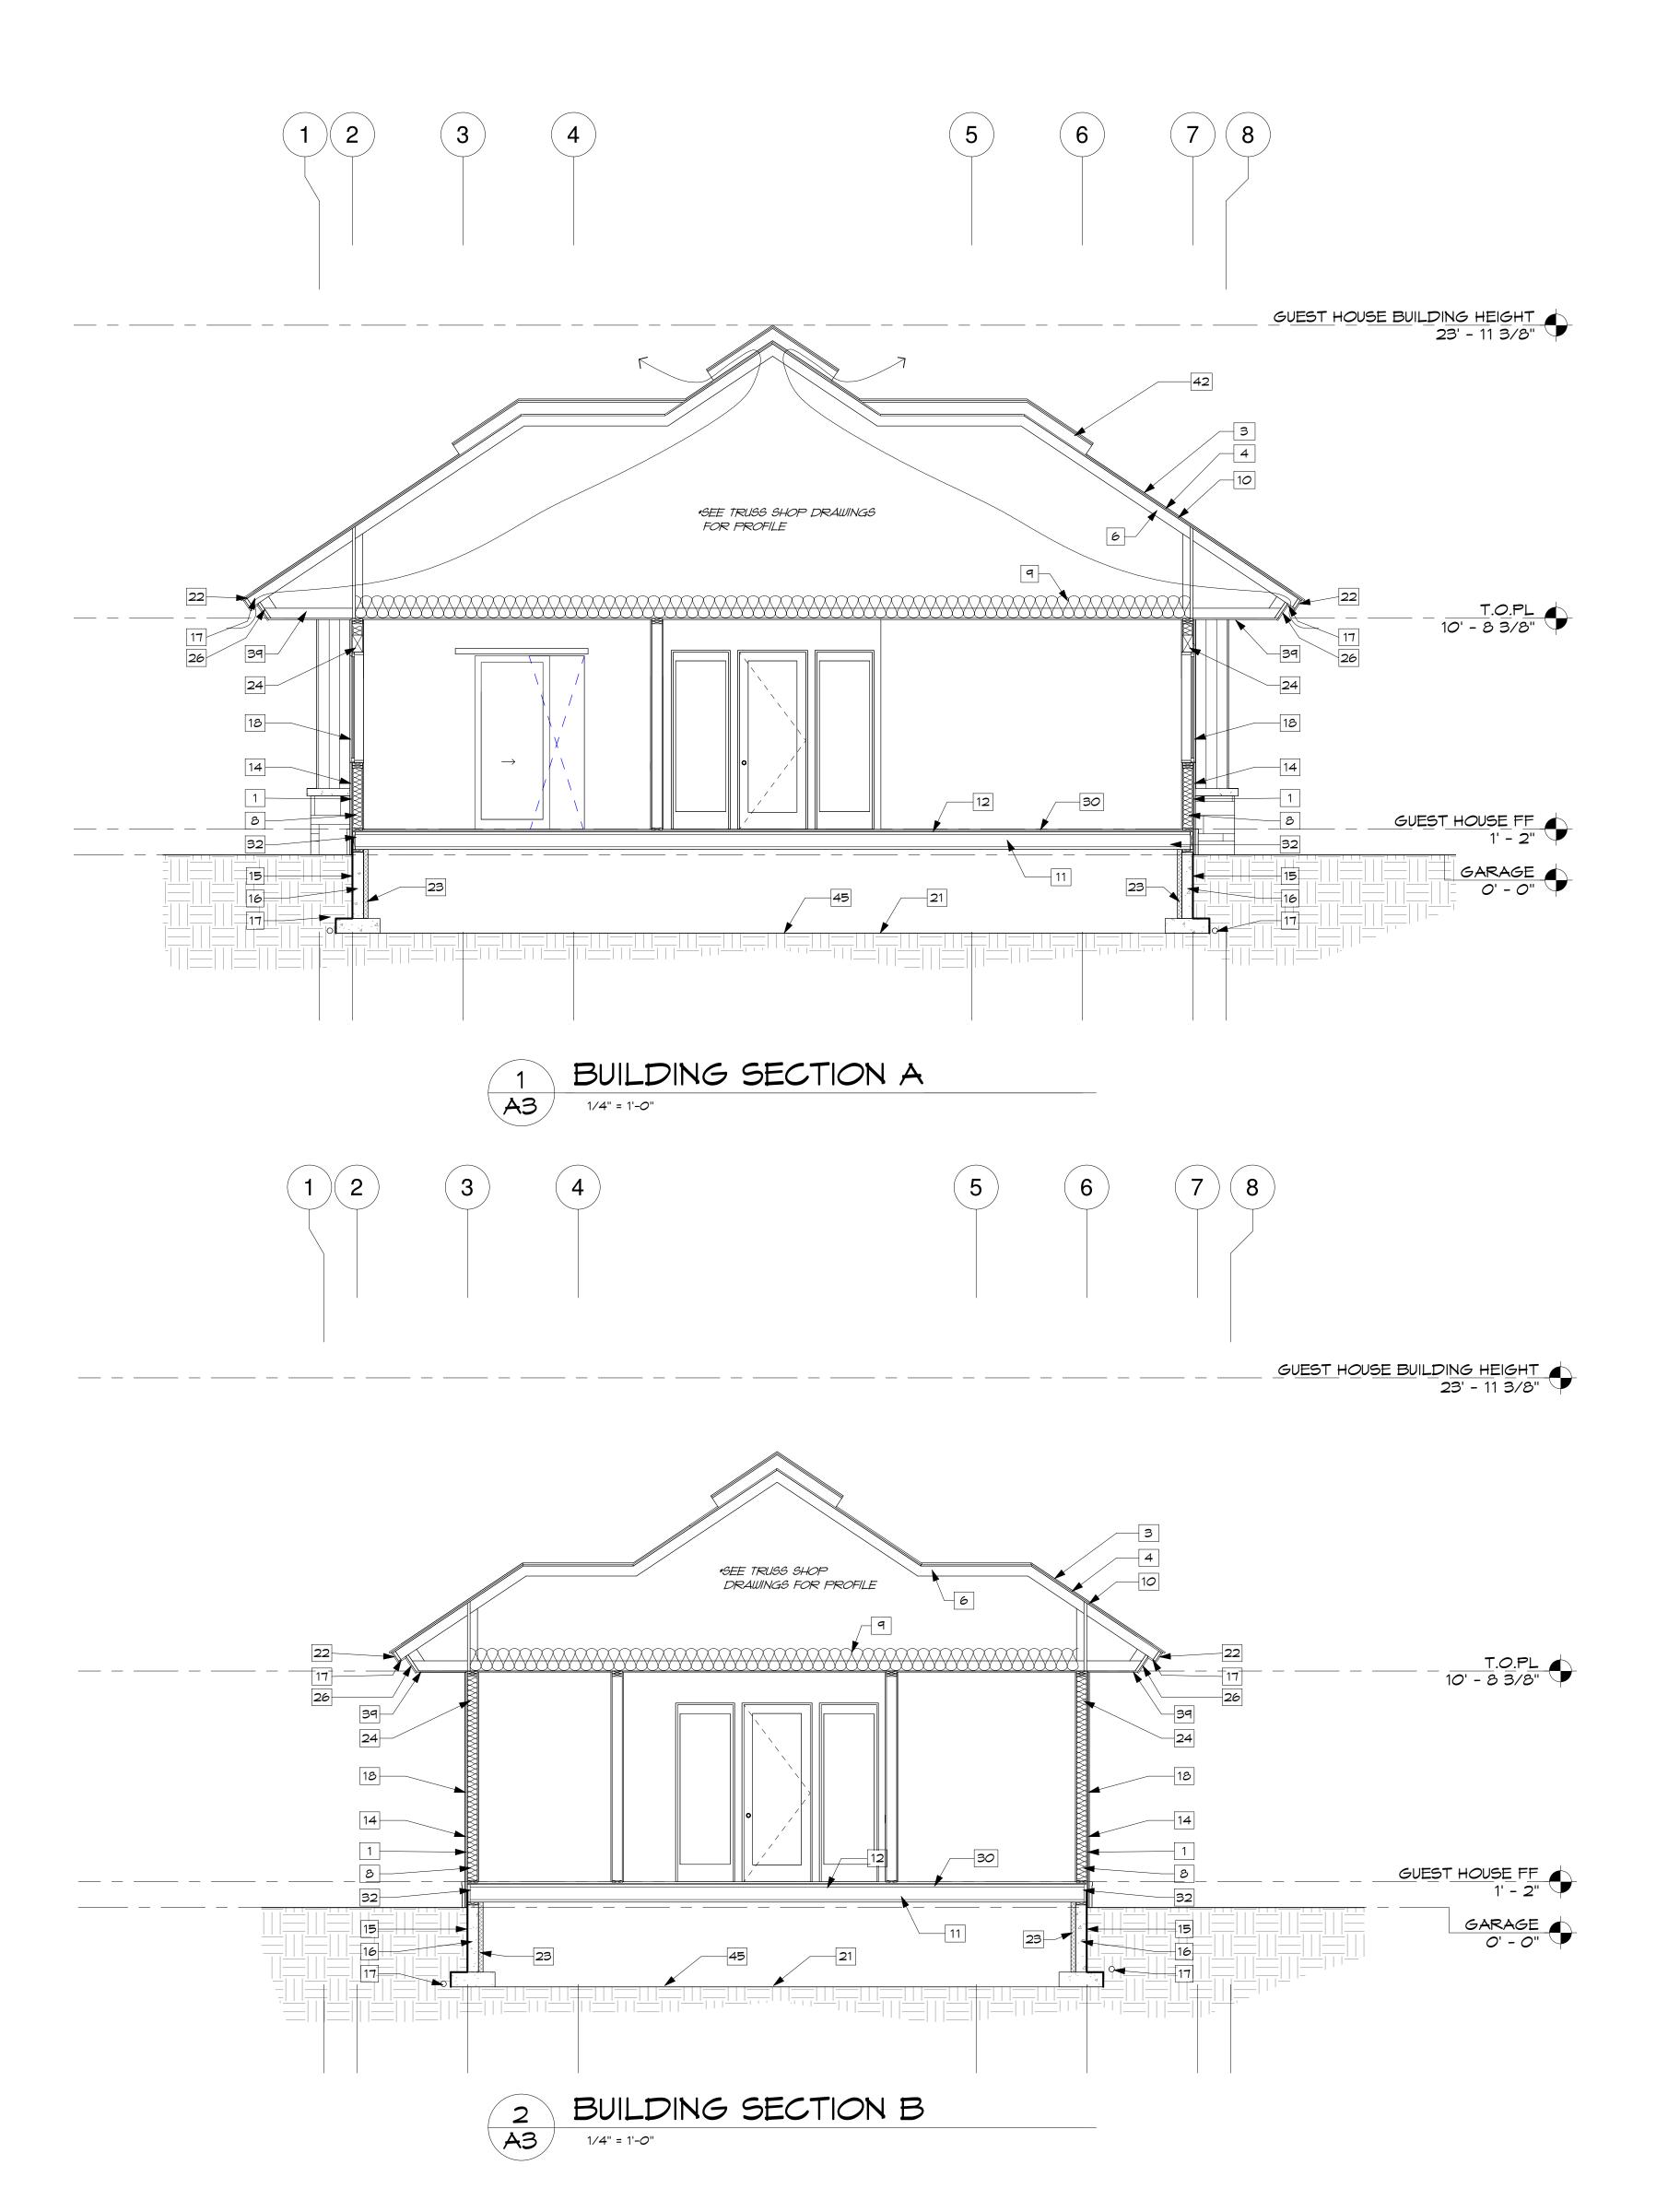

SECTION KEYNOTE:

- PLYMOOD WALL SHEATHING SEE STRUCTURAL
- 2 2X PONY WALL SEE STRUCTURAL
- ASPHALT SHINGLE ROOFING -MATCH EXISTING
- 4 FELTEX UNDERLAYMENT
- 5 VERSASHIELD SLIP SHEET
- 6 MANUFACTURED ROOF TRUSS
- 7 4-MIL. VISQUEEN VAPOR BARRIER
- 8 R-22 INSULATION
- R-49 POLYURETHANE/BLOWN INSULATION
- 10 ROOF SHEATHING SEE STRUCTURAL
- B.C.I. TYPE FLOOR JOISTS
- 12 PLYWOOD FLOOR SHEATHING
- SEE STRUCTURAL METAL FLASHING- 24 GA.

SEE STRUCTURAL

- 14 BUILDING WRAP- TYVEK OR EQ.
- WATERPROOF MEMBRANE OR RUBBERIZED ASPHALTIC EMULSION

SEE GENERAL NOTES

- 16 CONCRETE FOUNDATION
- PERFORATED METAL VENT
- M/ INSECT SCREEN 18 MINDOM UNIT U-.30, SHGC 0.30 MIN.
- DOOR UNIT U-.30 MIN.
- PERIMETER FRENCH DRAIN W/
- FILTER FABRIC RADON EVACUATION SYSTEM
- 1 X 6 FASCIA OR MATCH EXISTING
- R-15, 2.5"CLOSED CELL POLYURETHANE INSULATION
- 24 HEADER/BM. SEE STRUCTURAL
- 'BITUTHENE' MEMBRANE-"GRACE" ICE & MATERSHIELD
- 26 1 X 12 FASCIA OR MATCH EXISTING
- 27 STRUCTURAL BEAM
- 28 CRAWL SPACE MECHANICALLY VENTED
- 29 CONCRETE FOOTING SEE STRUCTURAL
- 30 FINISH FLOOR
- 31 1 1/2" GYPCRETE
- 32 TREATED SILL PLATE
- 33 2X OVER FRAMING
- 34 5/8" GYPSUM BOARD
- 35 FINISH SIDING
- 36 R-30 INSULATION
- 60 MIL TPO MEMBRANE
- 38 2X OVER FRAMING
- 39 1X6 SOFFIT
- 40 2X6 WALL FRAMING
- 41 GUTTER 42 BOSTON RIDGE VENT
- 43 STONE CAP
- 44 STONE VENEER
- 45 VAPOR BARRIER

GENERAL NOTES:

- * GLAZING TO COMPLY WITH THE 2018 INTERNATIONAL RESIDENTIAL CODE SECTION R308, R310, & R612
- * EGRESS WINDOWS TO COMPLY WITH THE 2018 INTERNATIONAL RESIDENTIAL CODE SECTION R310
- * STAIRS TO COMPLY WITH THE 2018 INTERNATIONAL RESIDENTIAL CODE SECTION 311
- * SMOKE ALARMS TO COMPLY WITH THE 2018 INTERNATIONAL RESIDENTIAL CODE SECTION R314
- * CARBON MONOXIDE DETECTORS TO COMPLY WITH THE 2018
- INTERNATIONAL RESIDENTIAL CODE SECTION R315
- INTERNATIONAL RESIDENTIAL CHAPTERS 10 & 18 * ALL WINDOW AND DOOR HEIGHTS ARE 8'-0" A.F.F. U.N.O.

* CHIMNEY AND FIREPLACES - TO COMPLY WITH THE 2018

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- CRAWL SPACE VENTING TO CONFORM WITH 2018 IRC SECTION

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ARCHITECT

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CHAD E. BLINCOE


STATE OF IDAHO


JOB #: 006.22 PLOT DATE: 33/23 **DESIGN REVIEW: CONSTRUCTION:**

REVISIONS: PRELIMINARY 3/3/23 DESIGN REVIEW 4/19/23

DESIGN REVIEW 5/18/23 PERMIT SET 8/21/23

PERMIT AUGUST 218

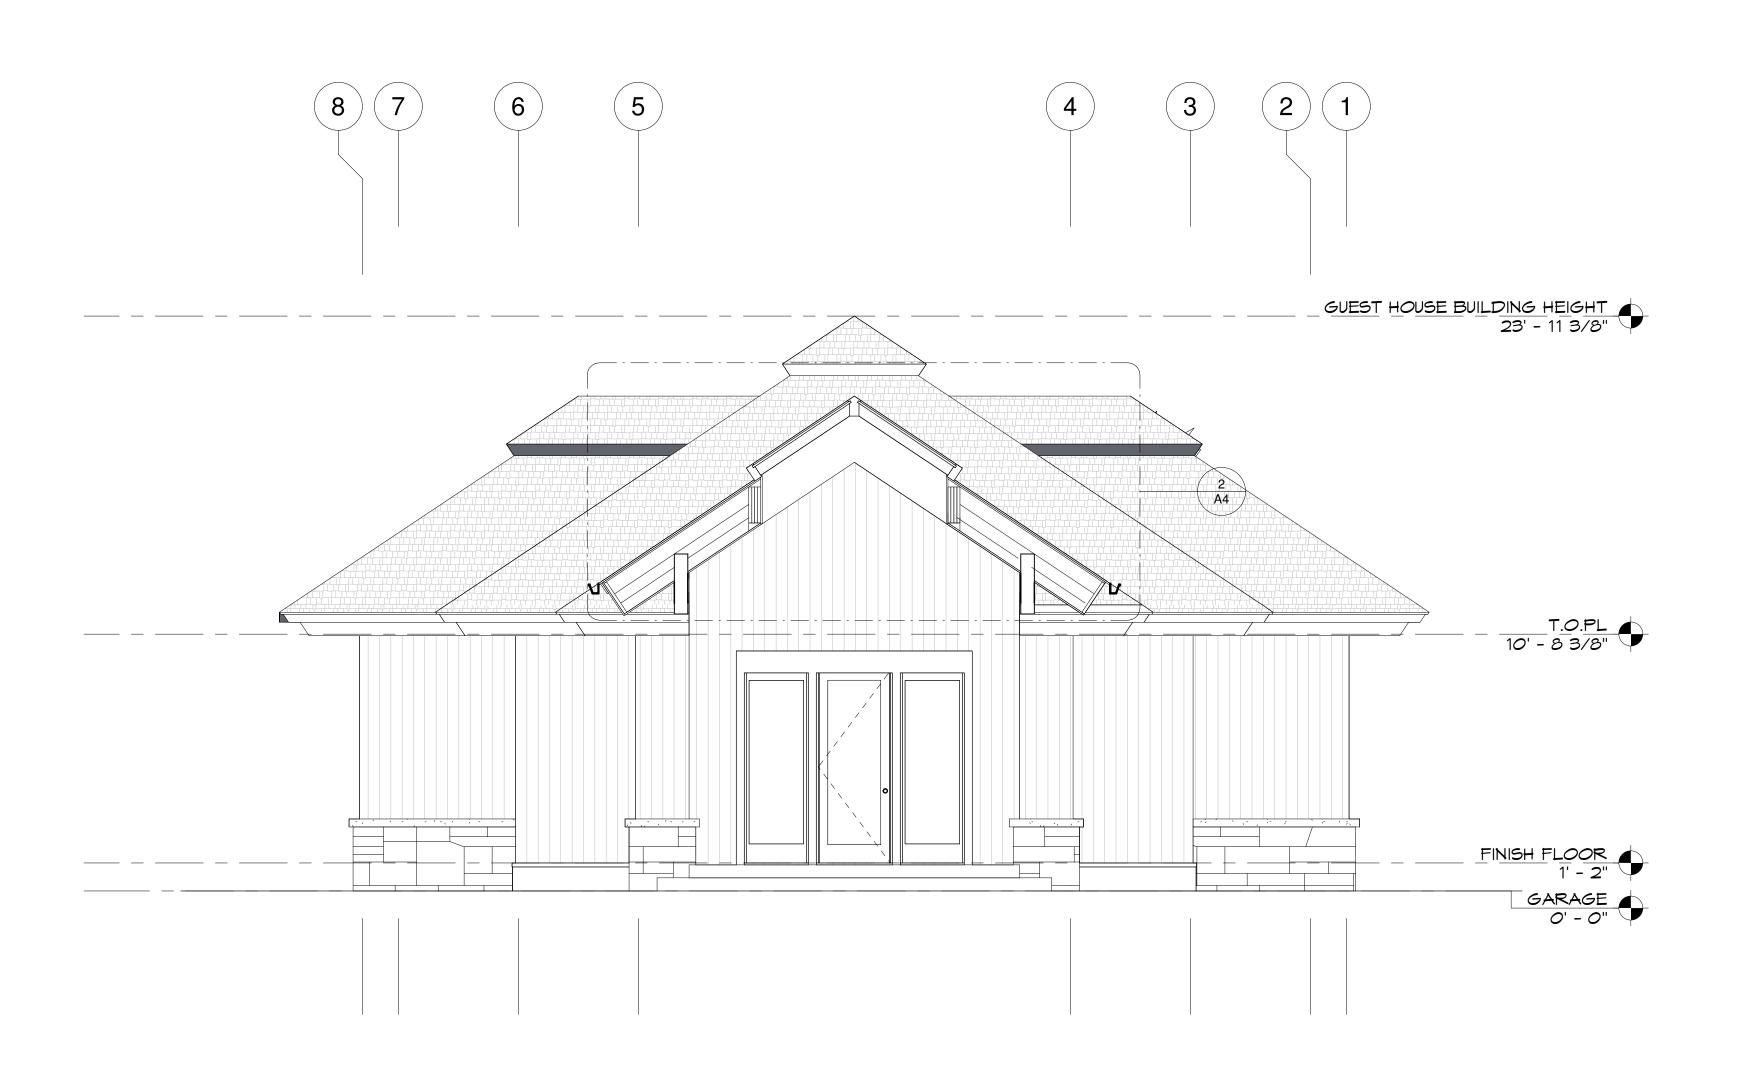

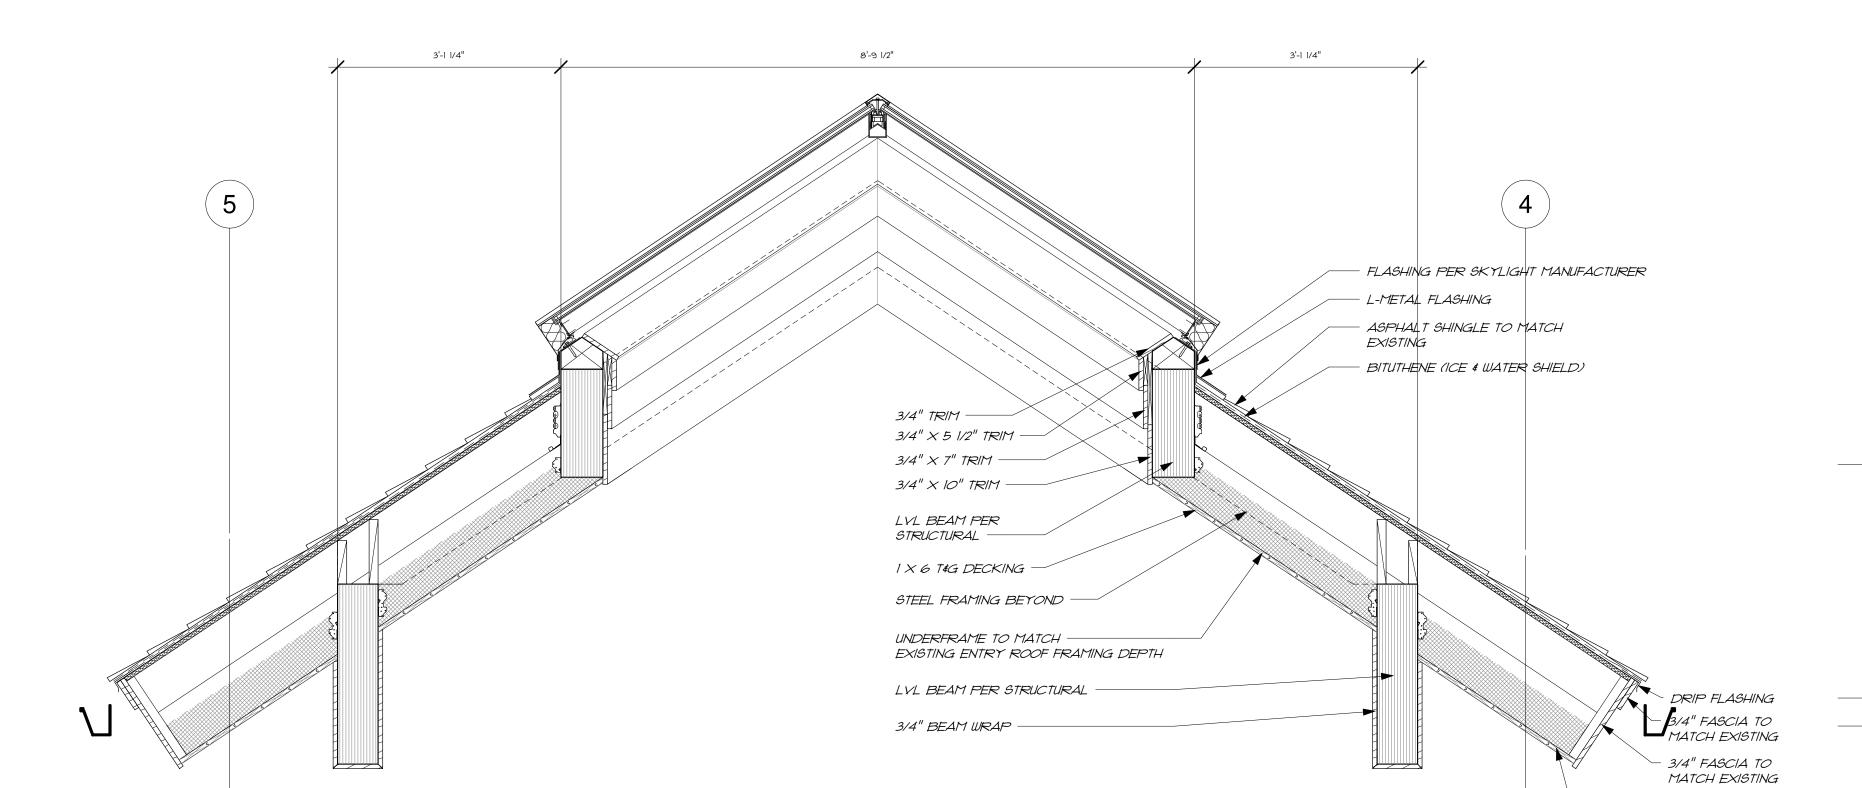


SKYLIGHT DETAIL

3/4" = 1'-0"

PROPOSED WEST ELEVATION (ADU)/PORTE COCHERE SECTION



- 1 × 6 T&G DECKING

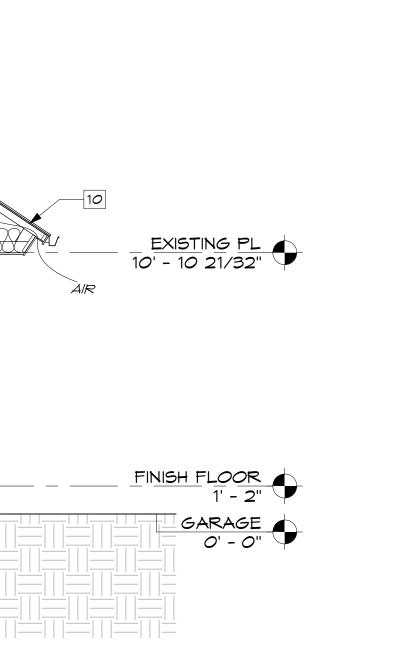

SECTION KEYNOTE:

- PLYMOOD WALL SHEATHING SEE STRUCTURAL
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- -MATCH EXISTING

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- 5 VERSASHIELD SLIP SHEET
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- 39 1X6 SOFFIT
- 40 2X6 WALL FRAMING
- 41 GUTTER
- 42 BOSTON RIDGE VENT
- 43 STONE CAP
- 44 STONE VENEER
- 45 VAPOR BARRIER
- 46 3" CURB
- 47 8X6 DECORATIVE RAFTERS

GENERAL NOTES:

- * GLAZING TO COMPLY WITH THE 2018 INTERNATIONAL
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- * CHIMNEY AND FIREPLACES TO COMPLY WITH THE 2018
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INTERNATIONAL RESIDENTIAL CHAPTERS 10 & 18

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WATERPROOF FLEXIBLE MEMBRANE.


- MANUFACTURES REQUIREMENTS.

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- OF PIPE FLASHING.

 * SELF-ADHERING MEMBRANE SHOULD SEAL AROUND ALL PIPE PENETRATIONS.
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- PROVIDE EAVE AND RIDGE VENTING AS REQUIRED, INCLUDING PROVISIONS FOR VENTING, SNOW CONDITIONS, & INSECT
- BARRIER.

 CRAWL SPACE VENTING TO CONFORM WITH 2018 IRC SECTION

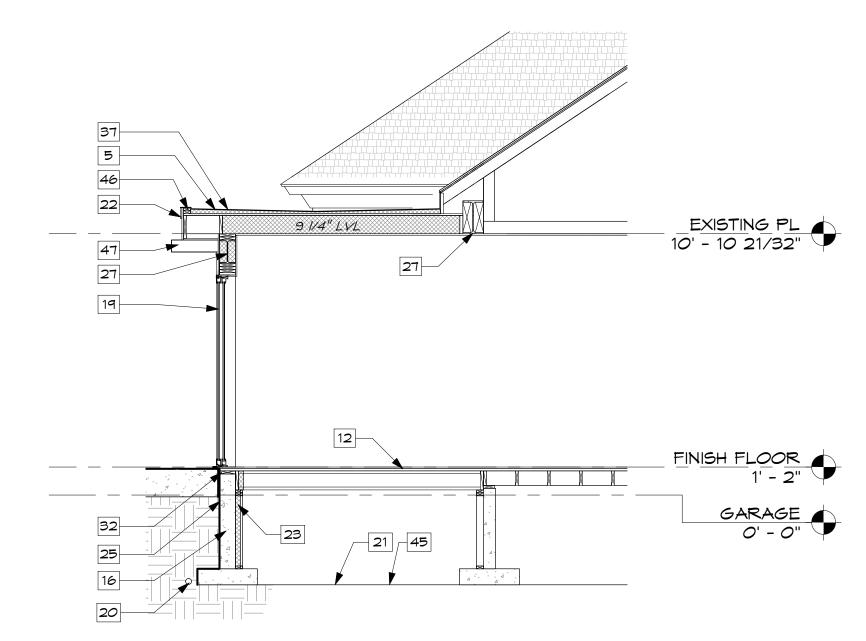

BUILDING SECTION E

1/4" = 1'-0"

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PERMIT SET AUGUST 21st, 2023

A

JOB #:

PLOT DATE:

DESIGN REVIEW:

CONSTRUCTION:

PRELIMINARY

3/3/23

DESIGN REVIEW

4/19/23

DESIGN REVIEW 5/18/23

PERMIT SET

8/21/23

006.22

33/23

A4

Ar

LICENSED

ARCHITECT

AR 984802

CHAD E. BLINCOE

STATE OF IDAHO





GENERAL NOTES:

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RESIDENTIAL CODE SECTION R314

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PROVIDE EAVE AND RIDGE VENTING AS REQUIRED, INCLUDING

PROVISIONS FOR VENTING, SNOW CONDITIONS, & INSECT BARRIER. CRAWL SPACE VENTING TO CONFORM WITH 2018 IRC SECTION

LEGEND:

EXISTING WINDOWS

NEW WINDOWS

ET 2023 RMIT SUST 21 PE! Augi

RESIDENC

JOB #:

PLOT DATE:

REVISIONS:

DESIGN REVIEW:

CONSTRUCTION:

PRELIMINARY 3/3/23

DESIGN REVIEW

4/19/23

DESIGN REVIEW

5/18/23

PERMIT SET

8/21/23

006.22 33/23

130 RIVER ROCK RD KETCHUM, ID 83340





PROPOSED WEST ELEVATION 2 A6

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BARRIER. CRAWL SPACE VENTING TO CONFORM WITH 2018 IRC SECTION

NOTE:

EXISTING WINDOWS

NEW WINDOWS

REVISIONS: ET 2023 RMIT SUST 21

JOB #:

PLOT DATE:

DESIGN REVIEW:

CONSTRUCTION:

PRELIMINARY 3/3/23

DESIGN REVIEW

4/19/23

DESIGN REVIEW

5/18/23

PERMIT SET


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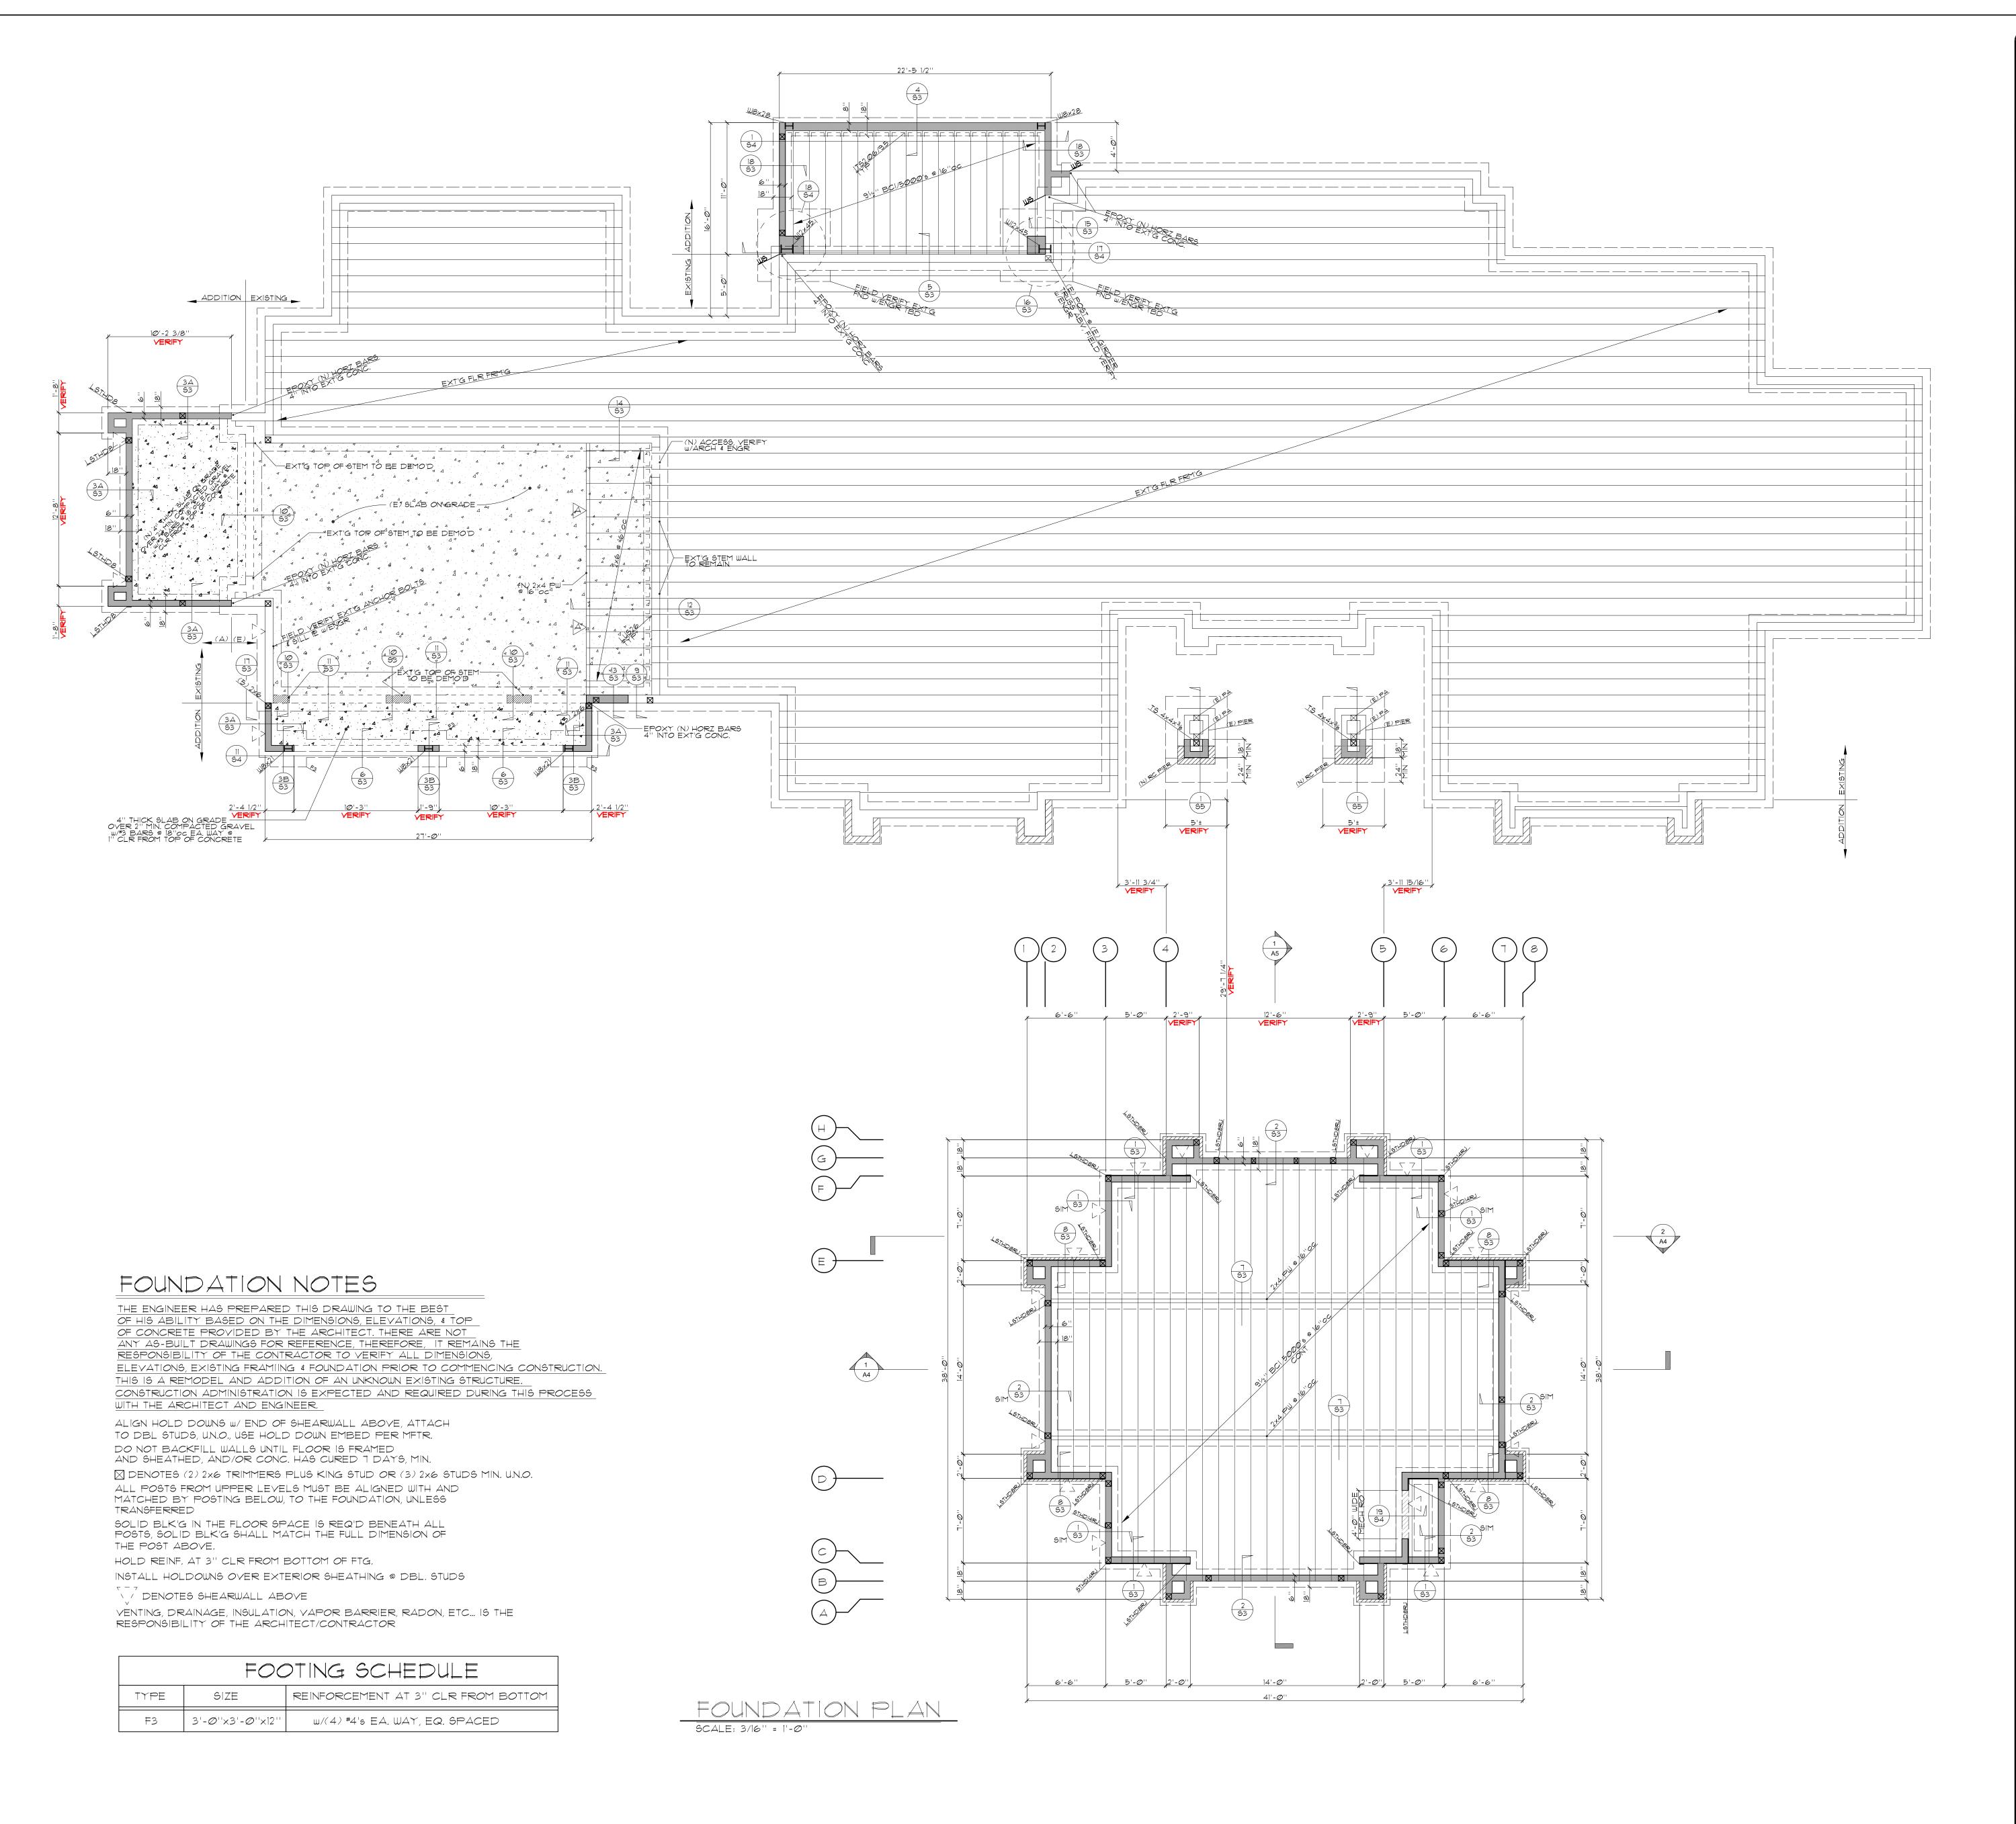
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33/23

RESIDENC

130 RIVER ROCK RD KETCHUM, ID 83340



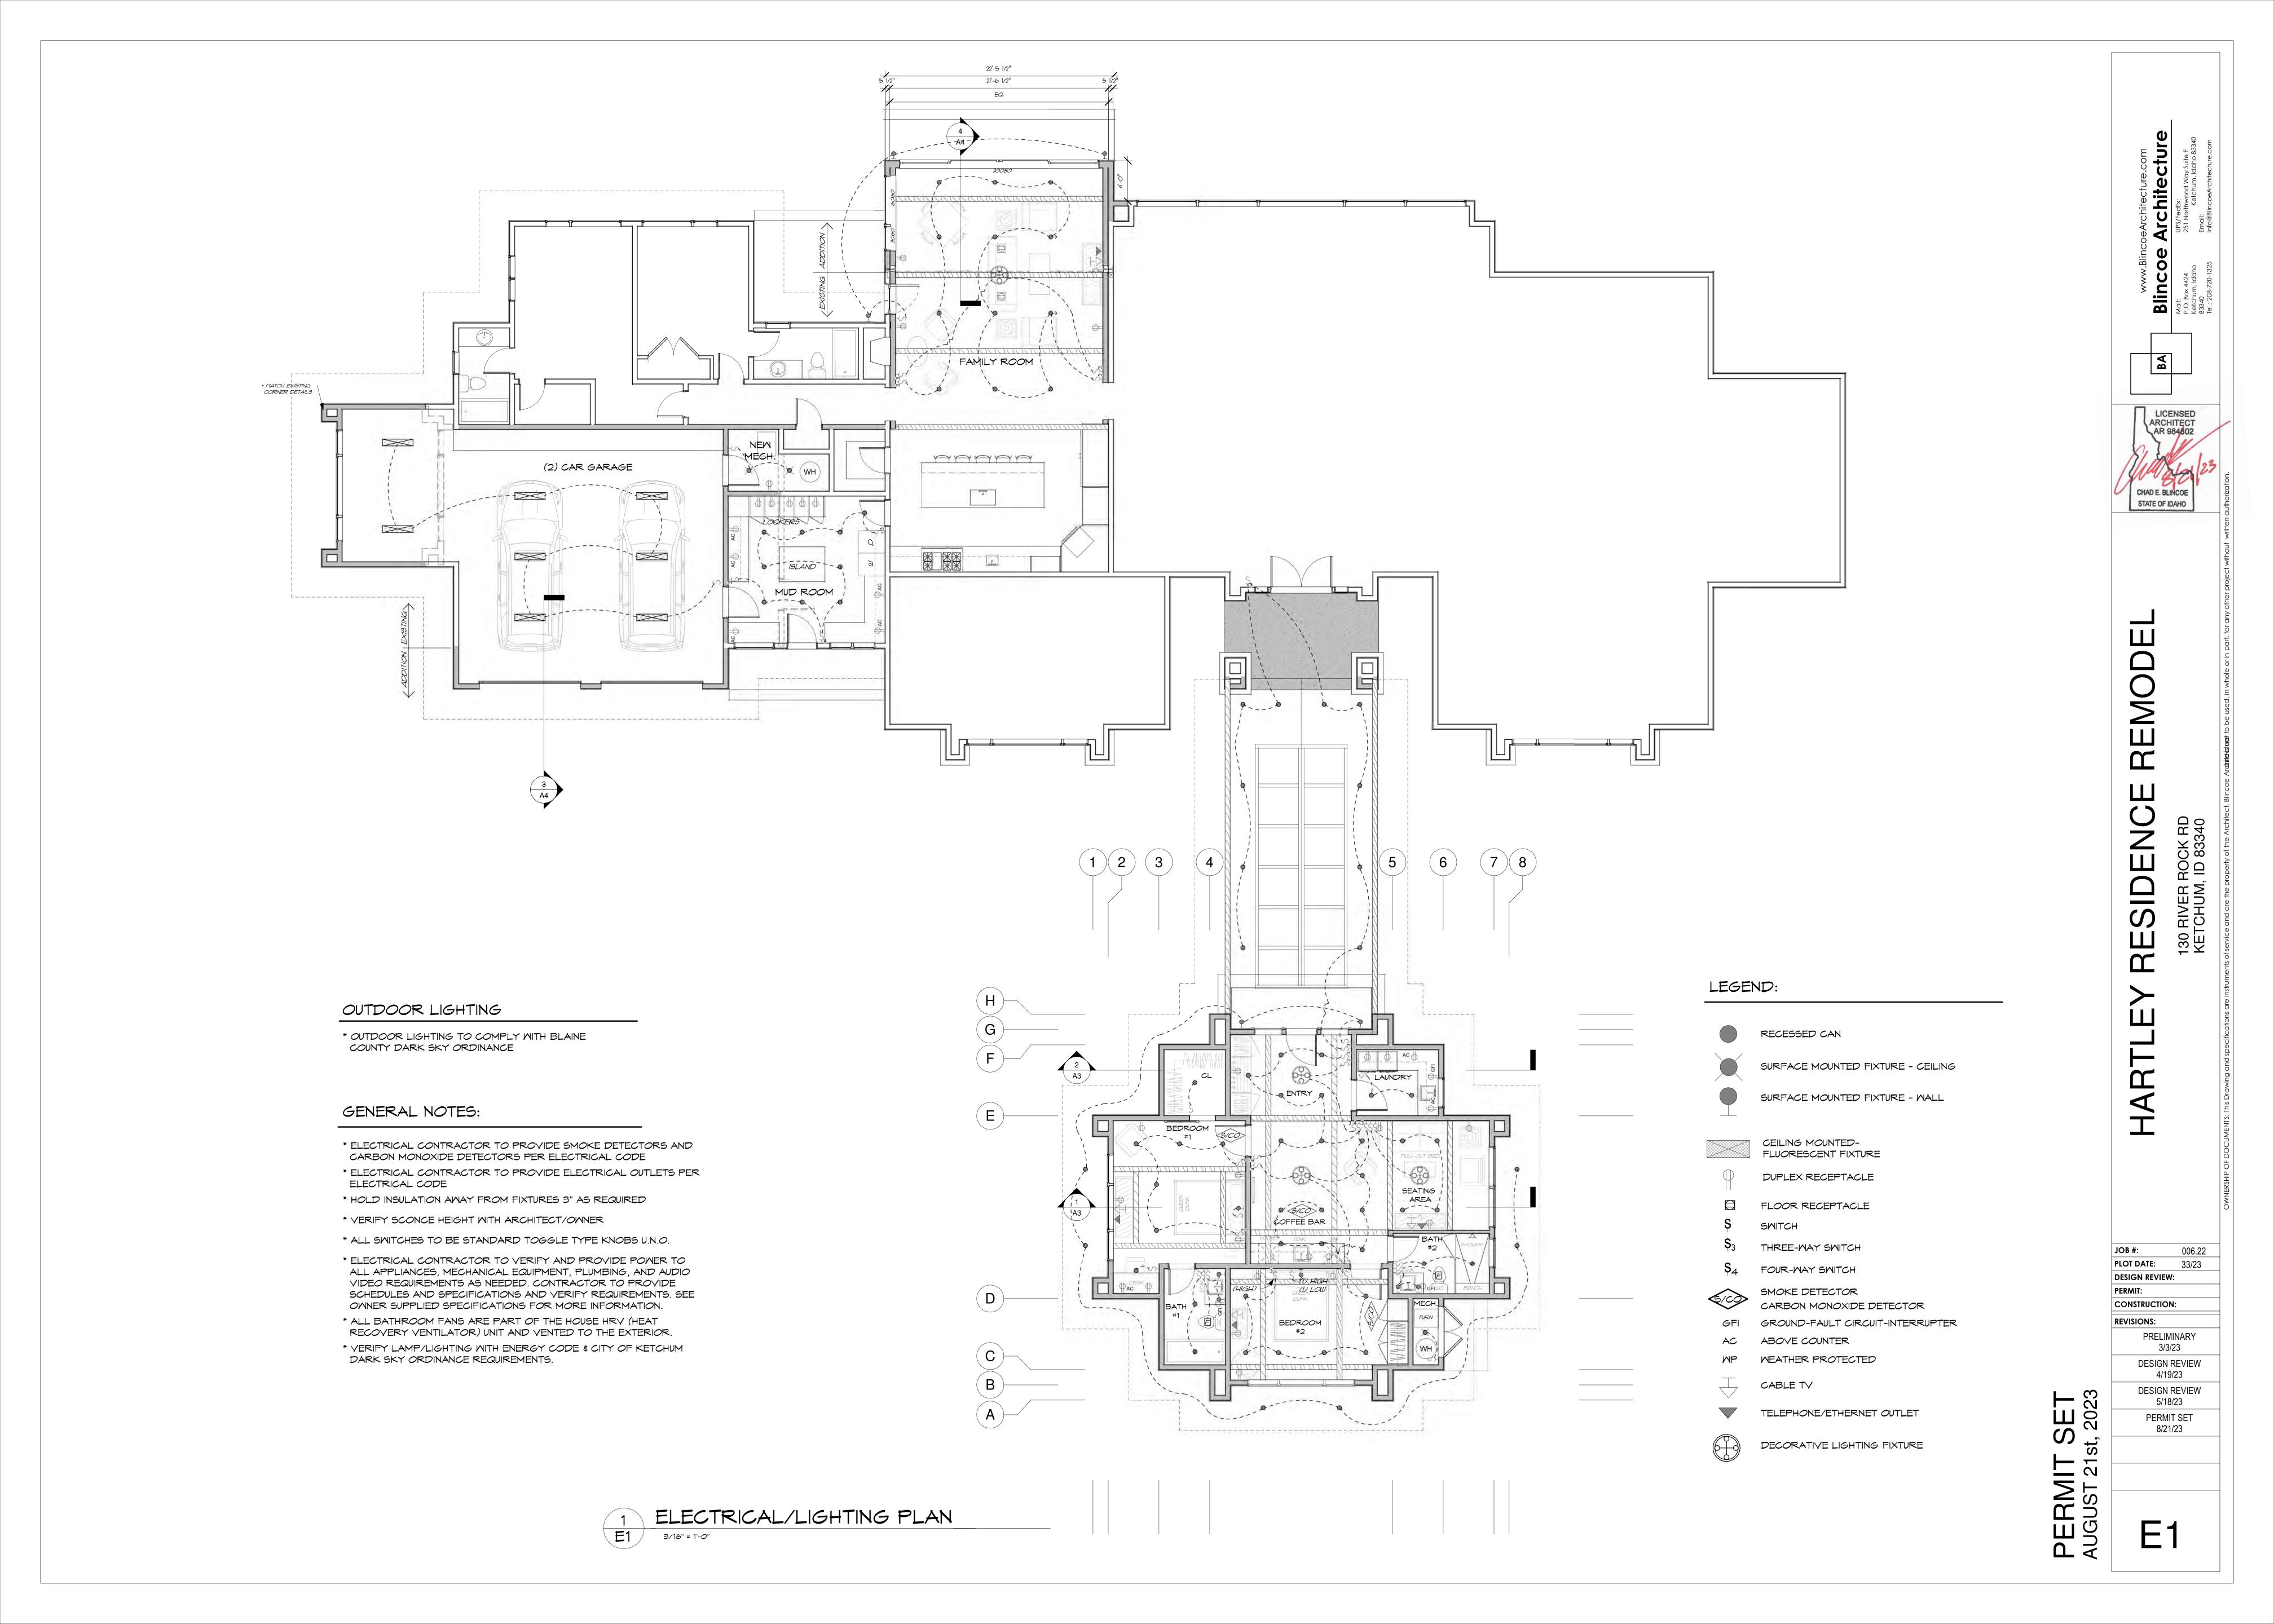

86.18

EX RESIDENCE REMODEL

FR. ROCK ROAD KETCHIM, ID 83340

Structural Engineering, LLC
T: 928-7810 F: 928-7811 kse@ksengr.net
614 S. Main, Bellevue Idaho, 83313

 $\mathbf{K}_{\mathrm{onrad}}$ St. St. $\mathbf{S}_{\mathrm{robler}}$

PROJECT #
2314

DATE/SET

AUGUST 25 2023 PERMIT SET

FOUNDATION PLAN
SHEET:

S1


—LSU26 @ SKEWS, TYP

TYP. OVERFRAMING-

- INVERTED HGUS26-2, TYP @ DBL's TO STR'L FACIA

ROOF FRAMING PLAN SHEET:

S2

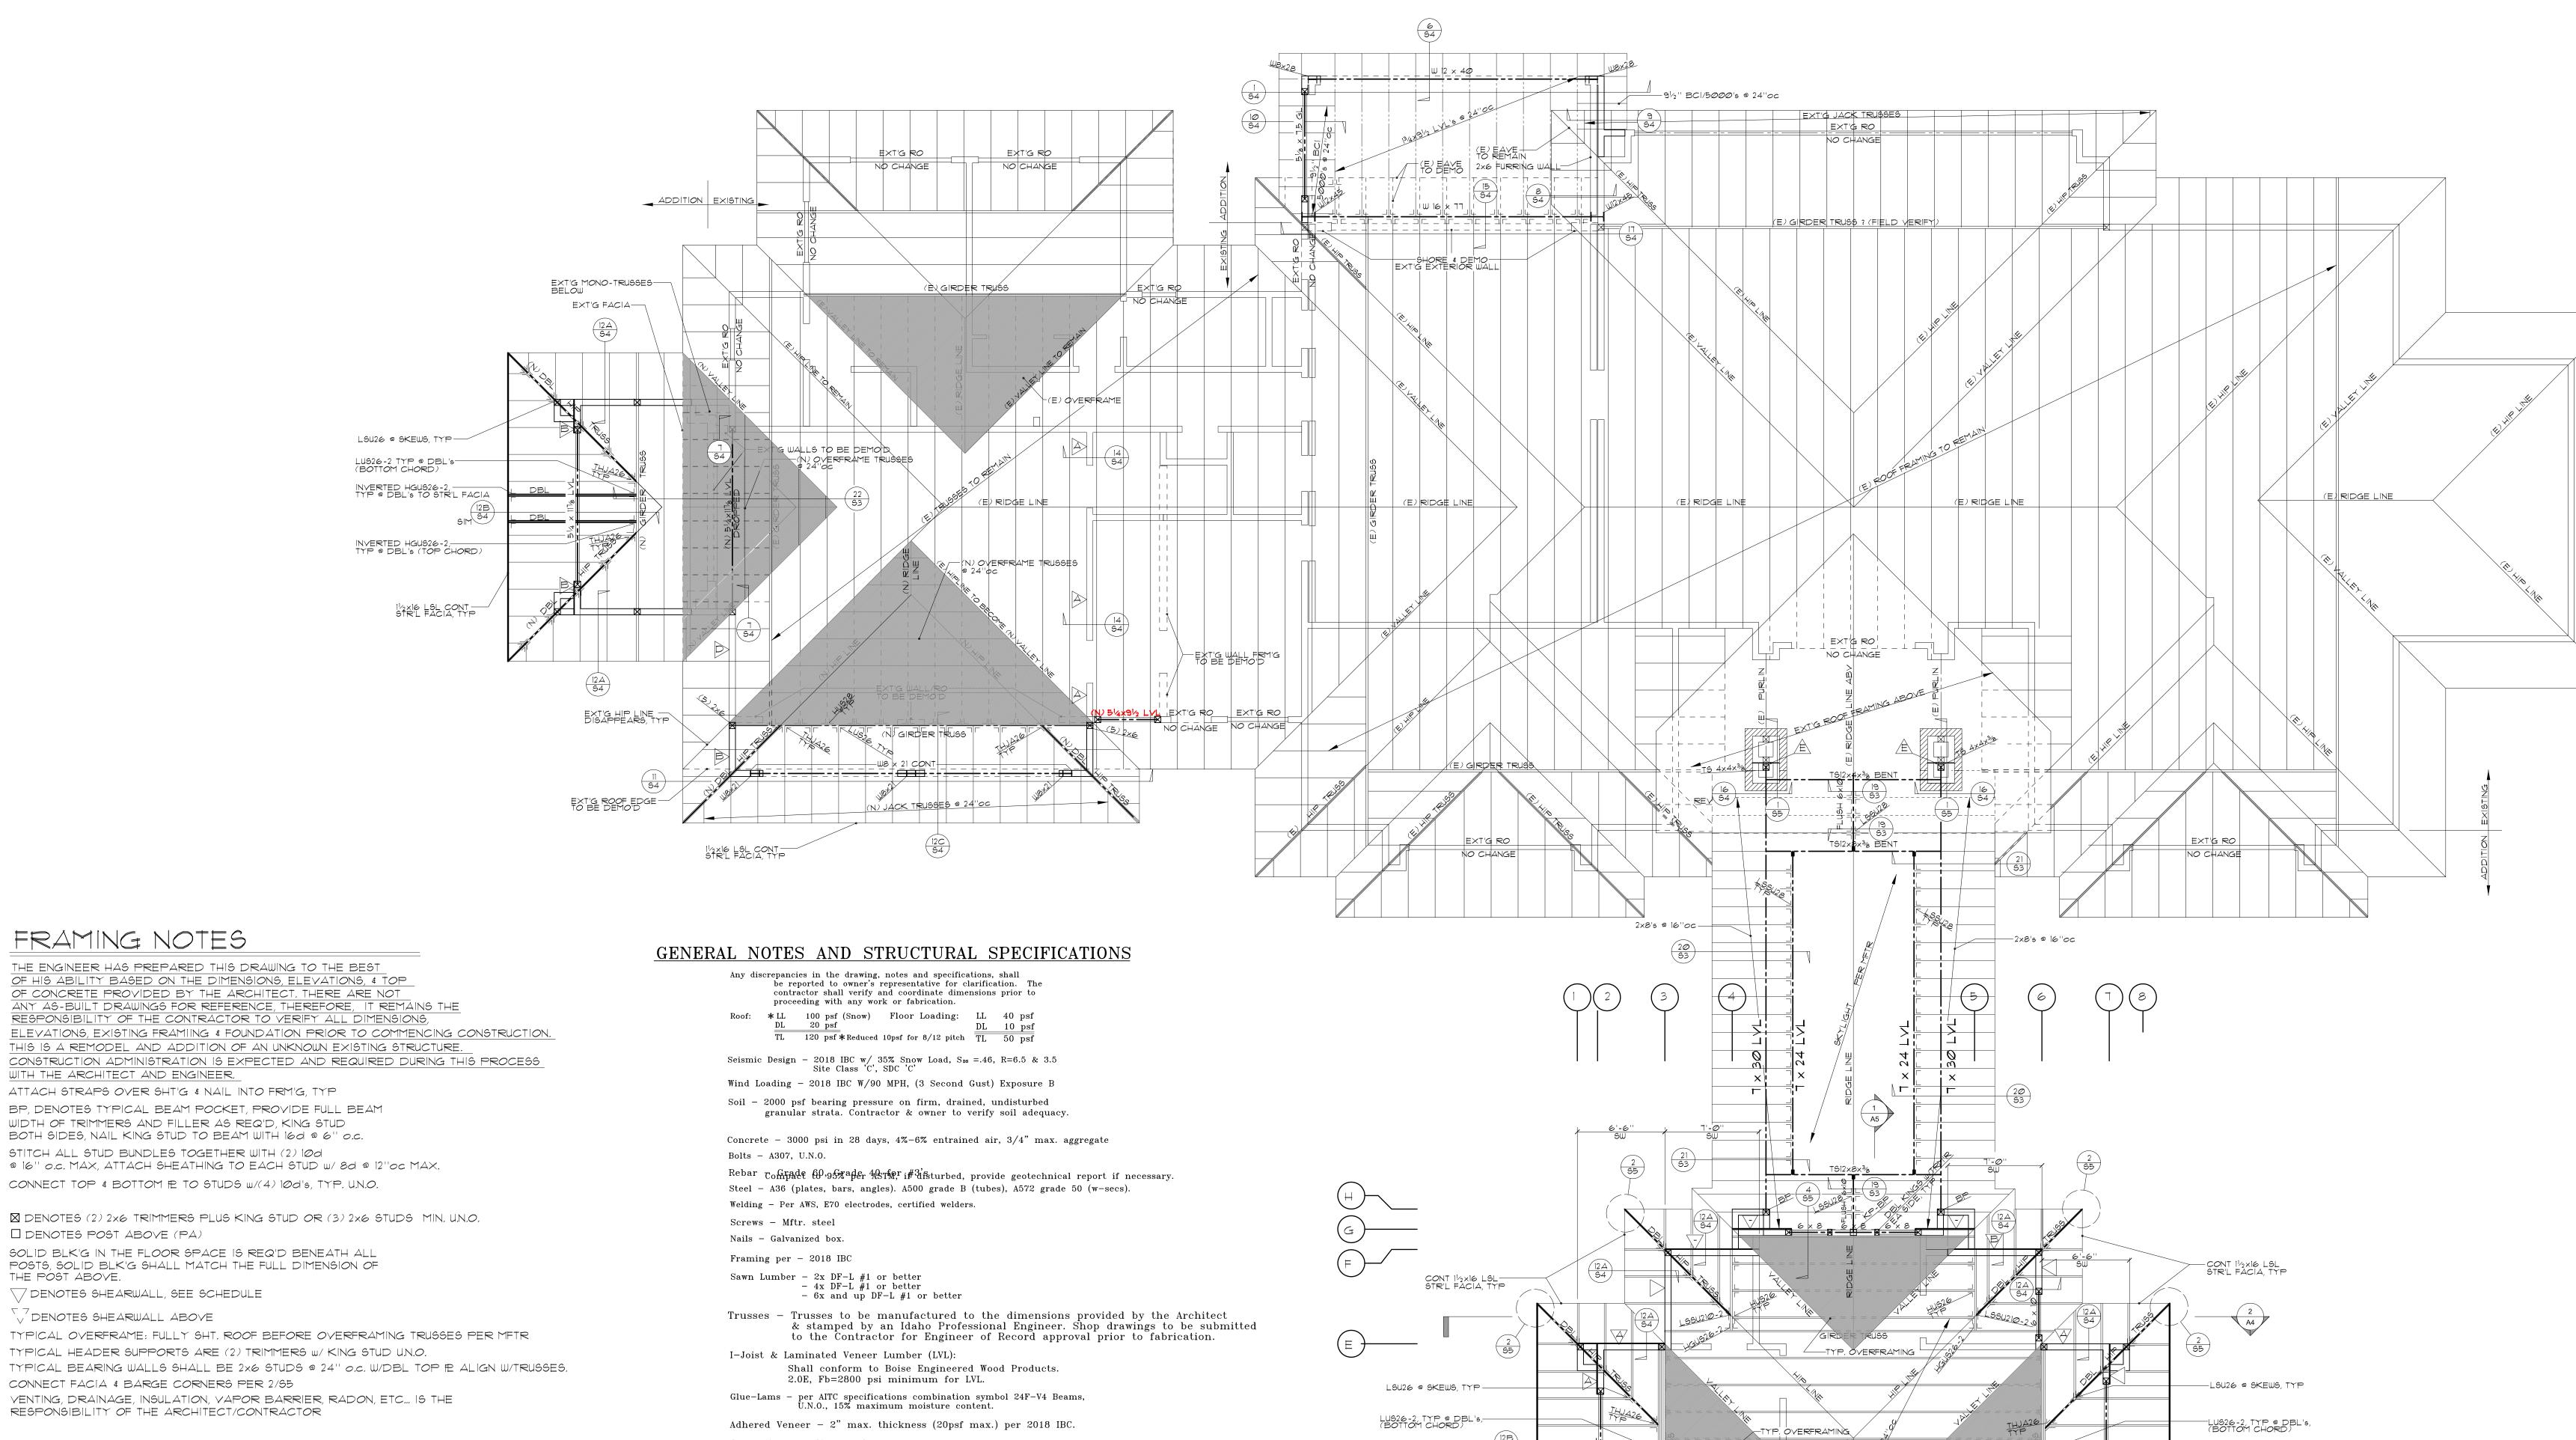

SHEARWALL SCHEDULE		
SYMBOL	DESCRIPTION	
	7/16" CDX/09B, BLK ALL EDGE9, 8d's @ 6"oc, 12" FIELD	
B	7/16" CDX/09B, BLK ALL EDGE9, 8d's @ 4"oc, 12" FIELD	
C	SAME AS @ BOTH SIDES	
	EXT'G EXTERIOR FRM'G, VERIFY (E) SHT'G, NAILING/BLK'G W/ENGR, PROVIDE \$\ightarrow\$ S/W AS RETRO	
E	£ 3/16 SHEARWALL RETRO PER 1/65	

FRAMING NOTES

WITH THE ARCHITECT AND ENGINEER.

 \square denotes post above (PA)

DENOTES SHEARWALL ABOVE

TOENOTES SHEARWALL, SEE SCHEDULE

CONNECT FACIA & BARGE CORNERS PER 2/85


THE POST ABOVE.

Connections per Simpson Co. Plywood or OSB:

Roof 5/8" CDX/OSB with 40/20 span rating Wall 7/16" CDX/OSB with 24/0 span rating Floor 3/4" CDX/OSB with 40/20 span rating

Special Inspection (welding) - NDT per certified testing agency @ all full pen groove field welds & all fillet field welds over 5/16", provide special inspection reports to engineer by direct e-mail immediately following inspection.

Safety - The engineer has not been retained nor compensated to provide design and/or construction review services related to the contractor's safety precautions or to means, methods, techniques, sequences or procedures for the contractor to perform his work. The undertaking of periodic site visits by the engineer shall not be construed as supervision of actual construction, nor make him responsible for providing a safe place for the performance of work by the contractor, subcontractors, suppliers or their employees.

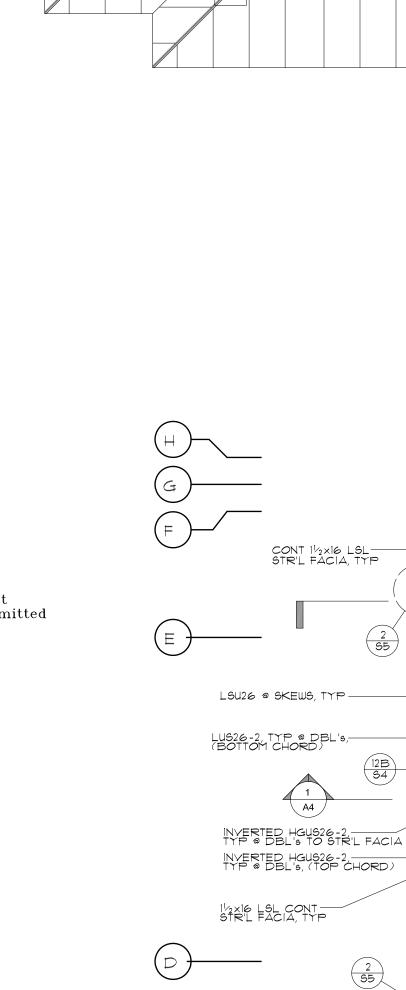



ROOF FRAMING PLAN


SCALE: 3/16" = 1'-Ø"

LSU26 @ SKEWS,—/

INVERTED HGU\$26-2, TYP @ DBL's (TOP CHORD) LU\$26-2, TYP @ DBL's, (BOTTOM CHORD)

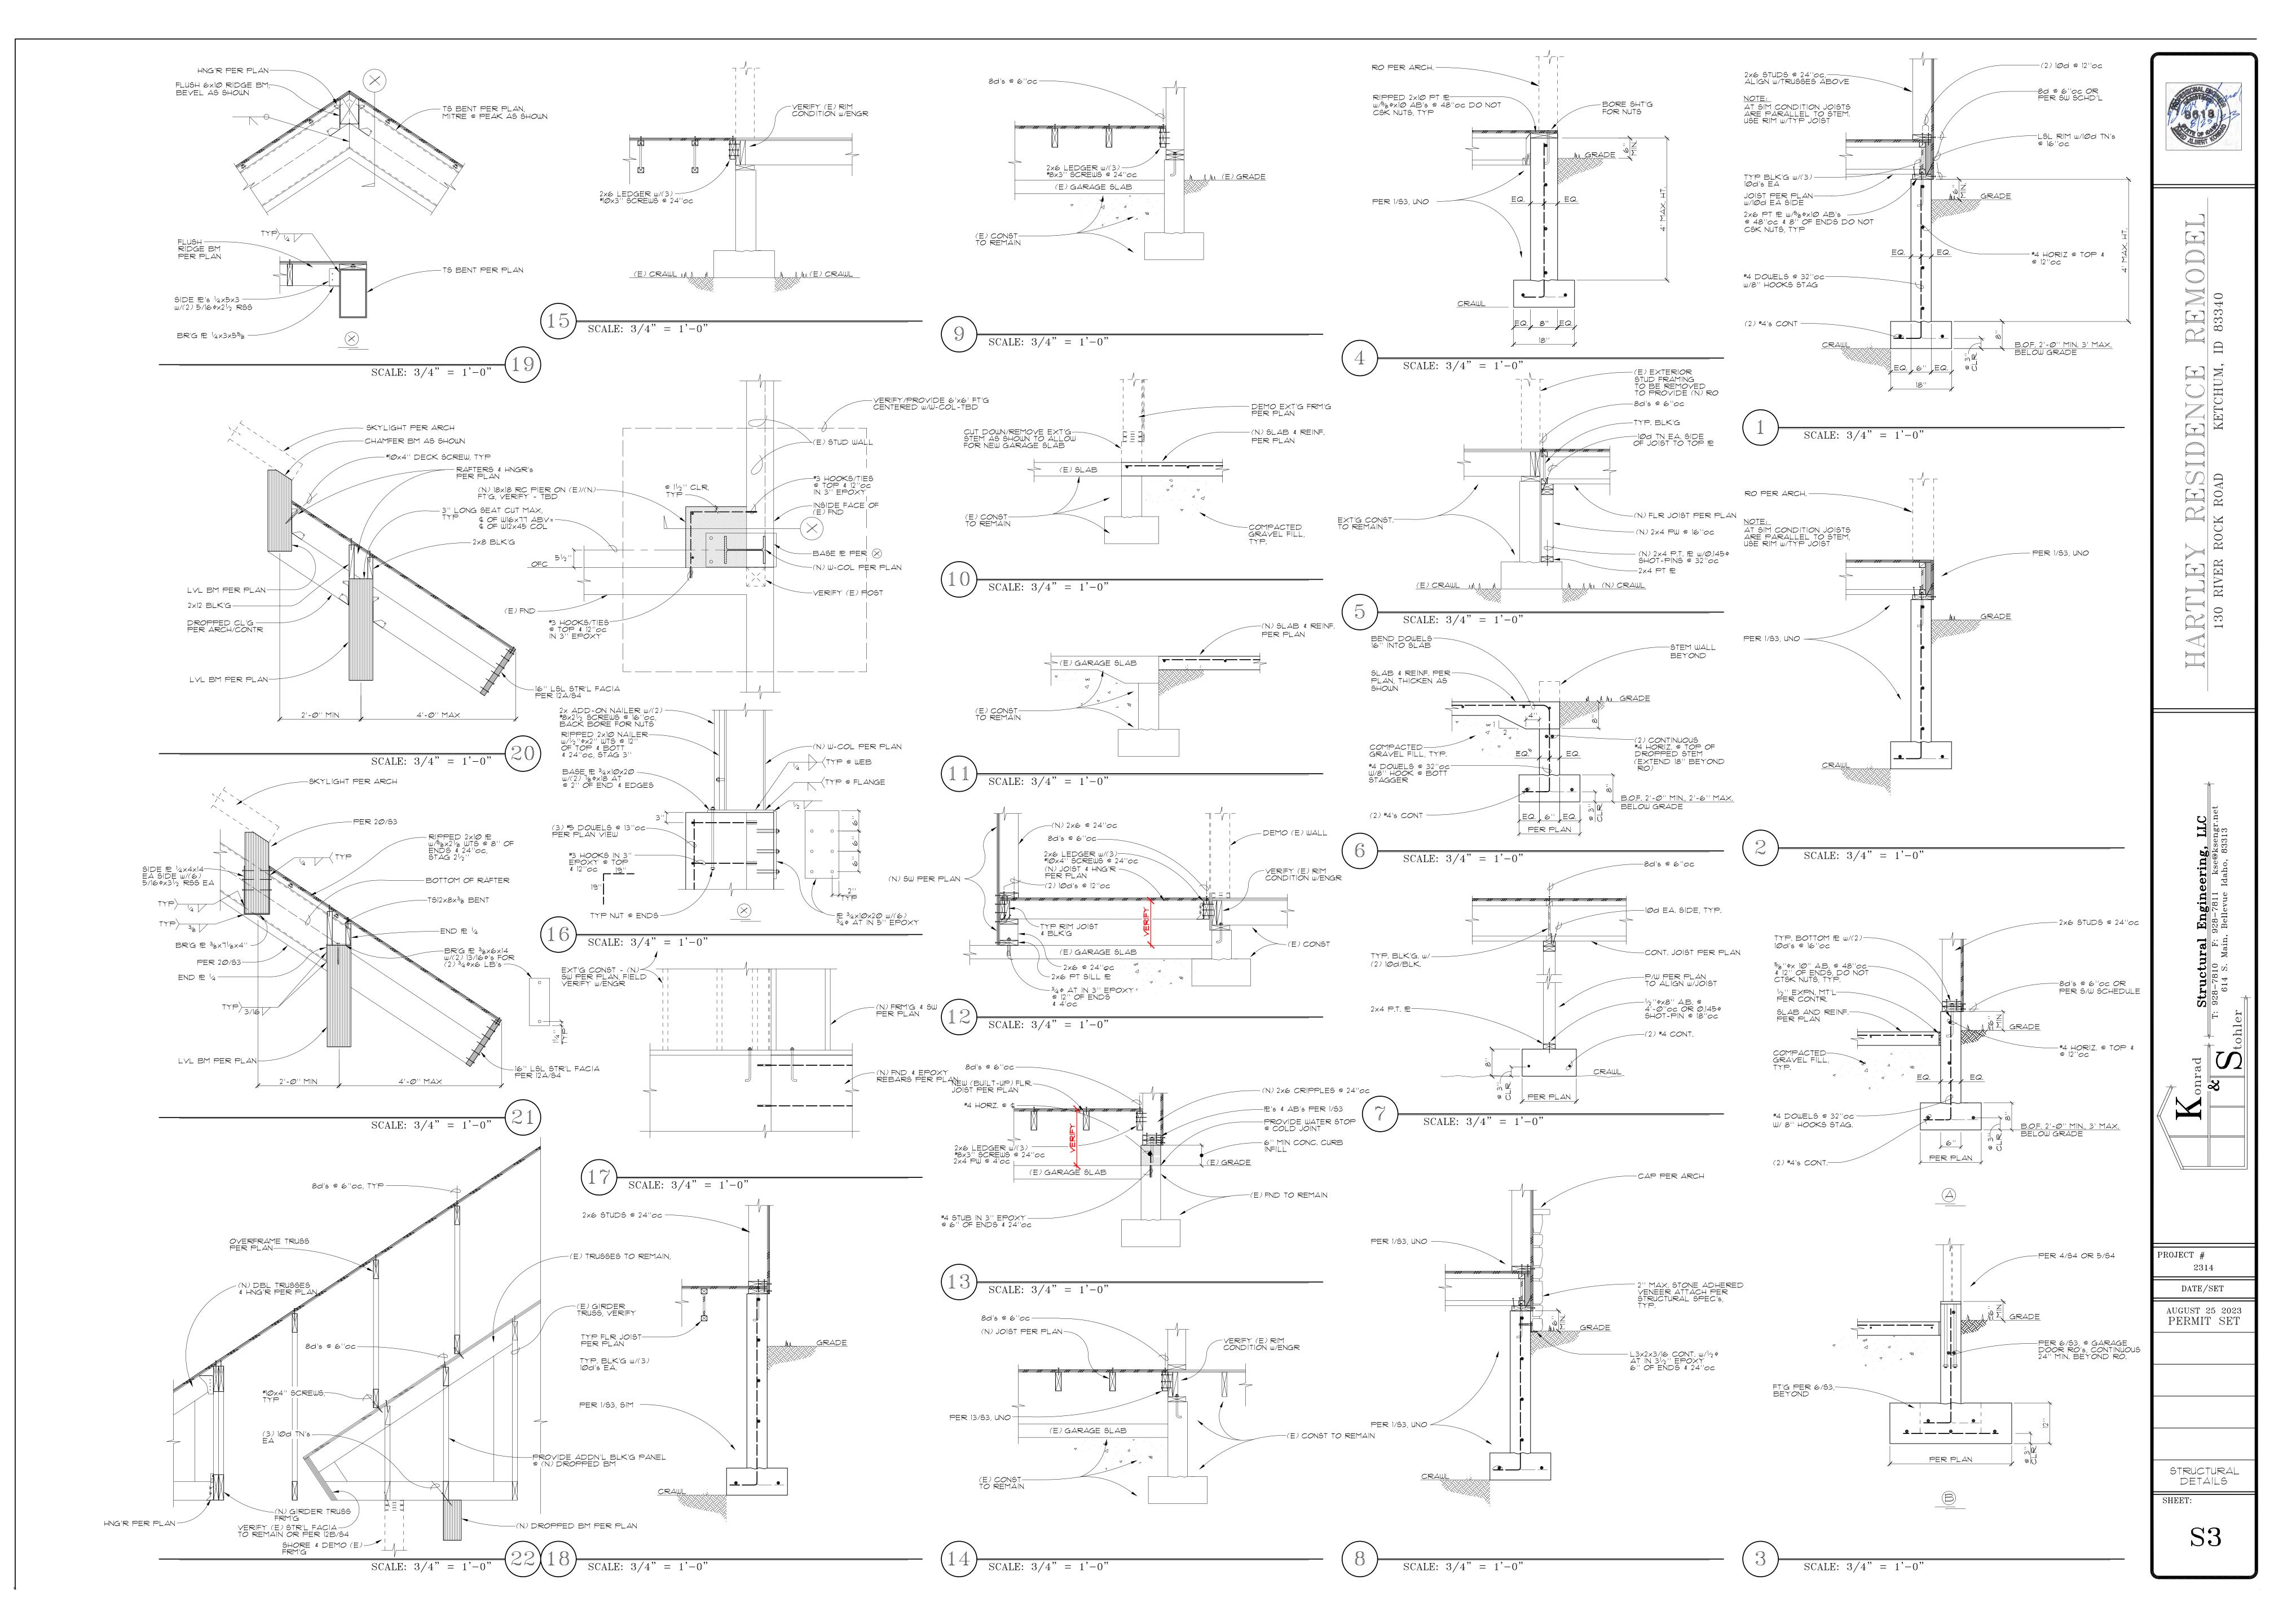

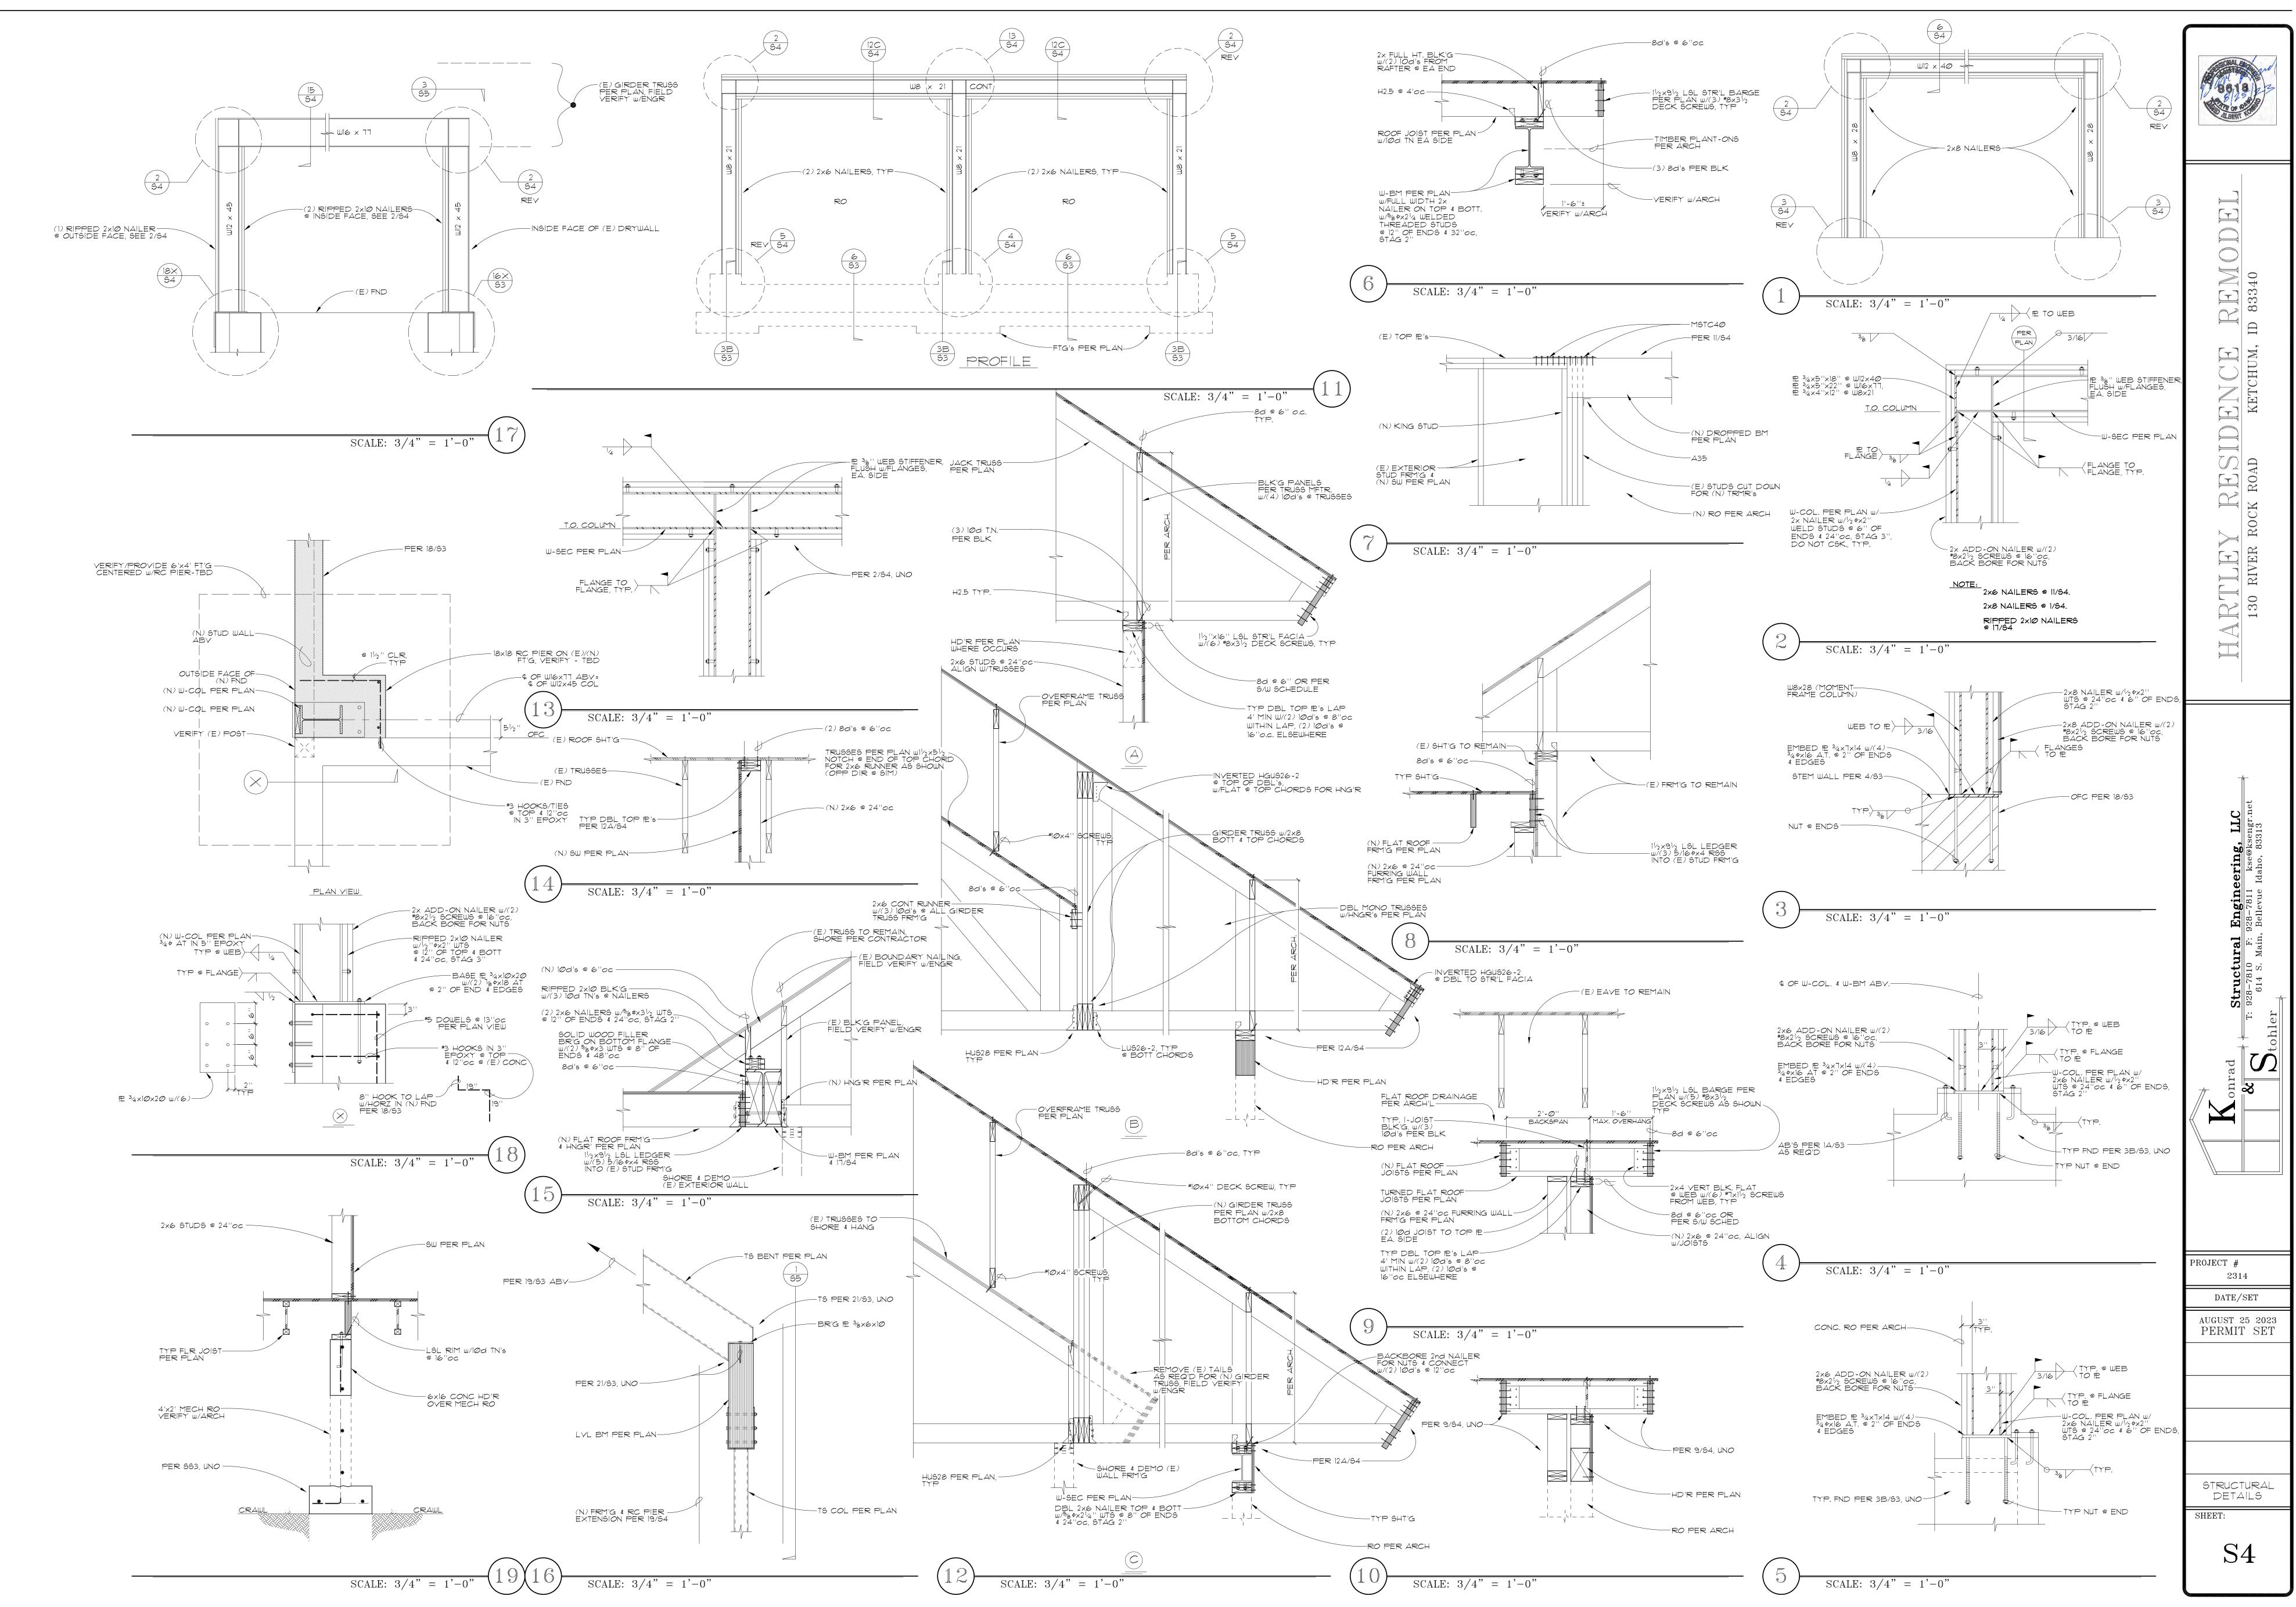

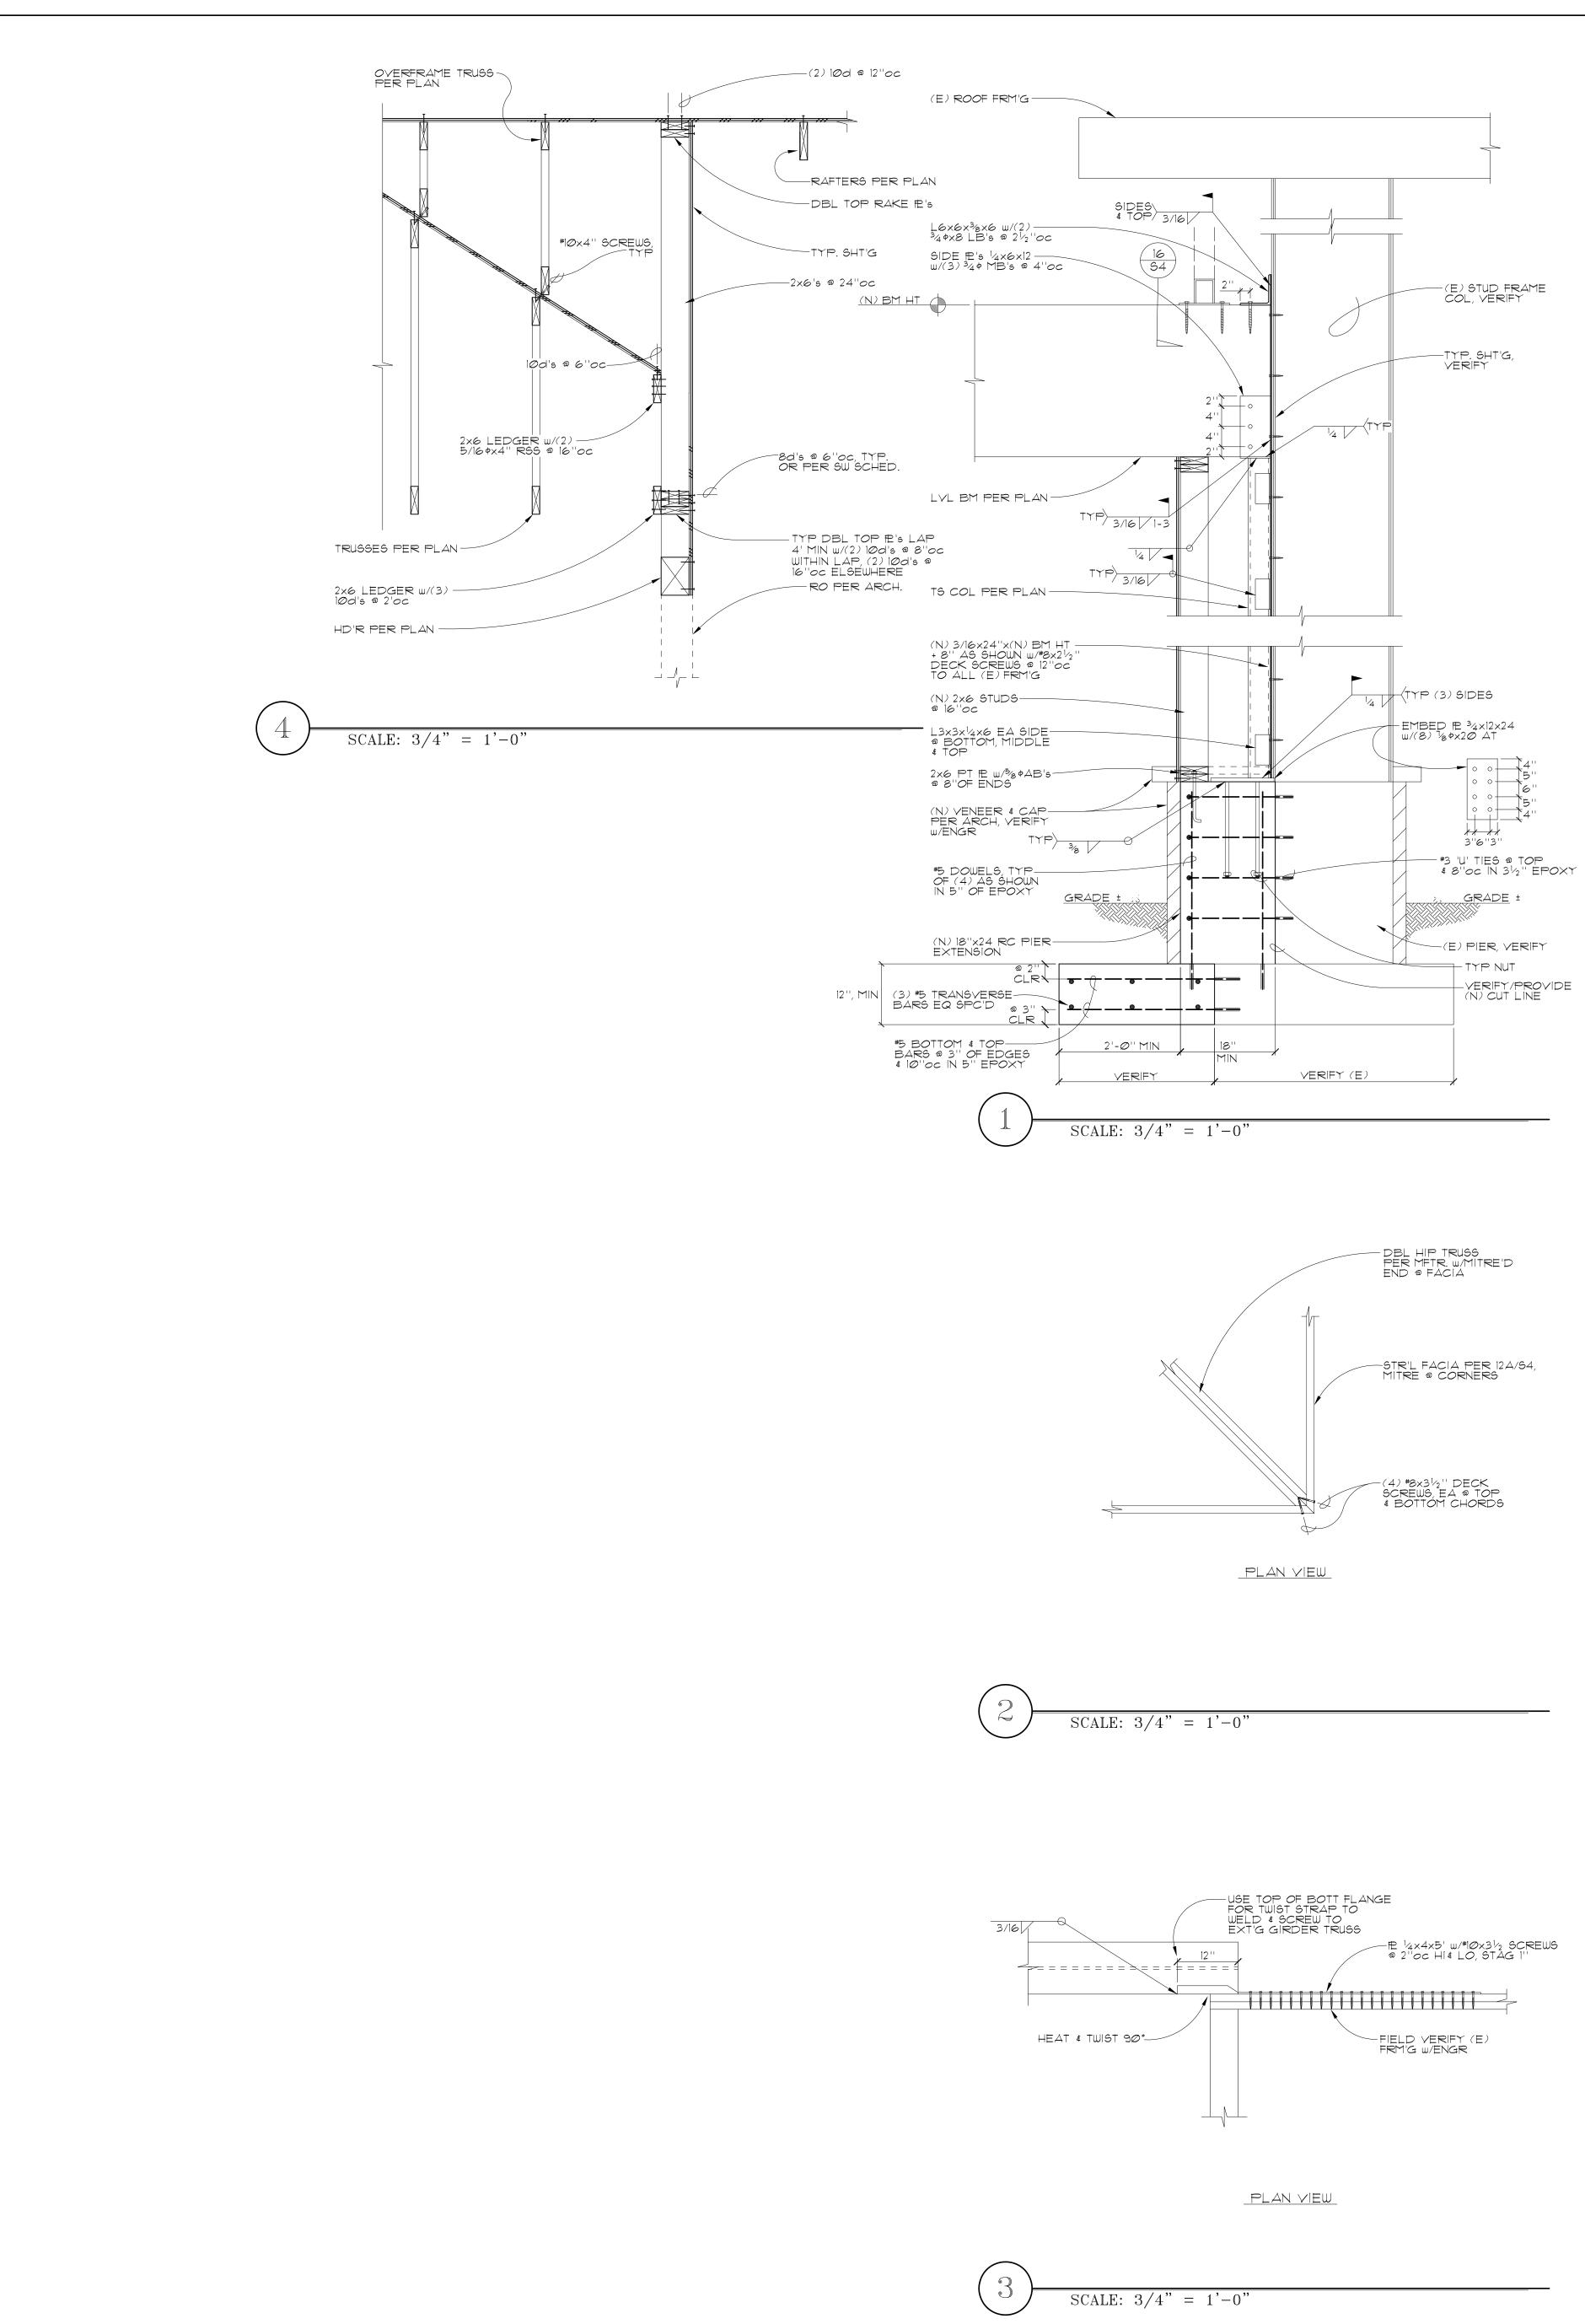

REMODEL ID 83340

RESIDENCE CK ROAD KETCHUM,

MARTLEY

130 RIVER ROCK

PROJECT #

SHEET:

S5

2314

DATE/SET

august 25 2023 PERMIT SET